PARKLAND DEDICATION, HISTORIC STRUCTURE RESTORATION, ARBORETUM, AND MOUNTAIN BIKE TRAIL SYSTEM CONSTRUCTION AND MAINTENANCE AGREEMENT BETWEEN THE CITY OF FRANKLIN AND LEGACY, LLC COF CONTRACT NO. 2019-0096

PARKLAND DEDICATION, HISTORIC STRUCTURE RESTORATION, ARBORETUM AND TRAIL **CONSTRUCTION** BIKE **SYSTEM** AND **MAINTENANCE** MOUNTAIN **AGREEMENT**, ("Agreement"), made and entered into this day of , 2019, by and between THE CITY OF FRANKLIN, TENNESSEE ("City") and LEGACY, LLC ("Legacy") as owner of that certain land consisting of approximately 988,812 square feet or 22.7 acres of undeveloped land located in Williamson County, Tennessee, as more particularly described in the Huffines Property PUD Subdivision Development Plan, Sheet C2.0, attached hereto, pursuant to Title 25, Chapter 4 of the City of Franklin Municipal Code.

WITNESSETH:

WHEREAS, Legacy is in the process of developing 1343 Huffines Ridge Drive (Map 62-Parcel 20) ("Property" or "Development Project"), consisting of four hundred twenty-six (426) apartment units, a one hundred seventy (170) room hotel, and an approximately 150,000 square foot office building, all as more particularly shown on the Huffines Property PUD Subdivision Development Plan, Sheet C2.0" ("Exhibit A"); and

WHEREAS, pursuant to Title 25, Chapter 4 of the City of Franklin Municipal Code, Legacy has agreed to design and construct an Arboretum and Mountain Bike Trail System, as well as restore the Historic Structure located on 10.03 areas of undeveloped land within the Huffines Property PUD Subdivision, to be zoned Civic Institutional (CI), which will include, but not be limited to, the mountain bike trail, trailheads, existing trees, shrubbery, and associated appurtenances such as signage, benches, and other associated amenities as approved by the City of Franklin, all as more particularly shown and described in the Letter of Intent ("Exhibit B") and on the Overall Master Plan ("Exhibit C") attached hereto; and

WHEREAS, Legacy desires to develop a plan, the Historic Structure Restoration Effort, and intends to restore the Carothers family home ("Home") to community center specifications to be provided by City as shown in the Architectural Restoration Plans (Exhibit D"); restore one (1) associated structure as a maintenance shed for the City of Franklin Parks Department; construct a trail storm shelter; demolish the other associated and unsound structures currently located on the property; restack the dry-stacked stone walls quarried and located in the area immediately surrounding the Home, all as more particularly described in Exhibit B and on Exhibit C attached hereto; and

WHEREAS, Legacy intends to develop an interpretive Arboretum in the area immediately surrounding the Home as a means to commemorate the historical use of the property as a homestead and farm as more particularly described on Exhibit C attached hereto; and

WHEREAS, Legacy and City intend for the entire area to be included in a Historic Preservation Overlay ("HPO") designation on the final plat; and

WHEREAS, the HPO, Historic Structure Restoration, Arboretum, and Mountain Bike Trail System encompasses approximately 10.03 acres of land on the Property all as more particularly shown and described on Exhibit A attached hereto; and

WHEREAS, Legacy has requested to offset a portion of the costs of construction of these improvements against any Parkland Impact Fees due from the Development Project, and the estimated amount of such eligible costs, and the potential offset, was determined by the Parks Department Director on February 4, 2019, to be ONE MILLION EIGHT HUNDRED THIRTY-THREE THOUSAND FIVE HUNDRED FOUR and 00/100 Dollars (\$1,833,504.00) as itemized in the Opinion of Cost ("Exhibit E"); and

WHEREAS, Legacy has agreed to plat and dedicate the HPO, Historic Structure Restoration, Arboretum, and Mountain Bike Trail System upon restoration and construction of the Home, Arboretum, and the Mountain Bike Trail System improvements as illustrated on Exhibits B and C, and described in detail below for the future enjoyment of the public, free of charge, subject to the terms and conditions set forth herein; and

WHEREAS, any approved fixed structures associated with the Home, Arboretum, or Mountain Bike Trail System (examples may include fencing, benches, off-street parking, signage, etc. as illustrated on the approved construction drawings on file with the City of Franklin Parks Department) shall not be altered, expanded, or in any way modified in any material way by Legacy with respect to the nature and intensity of its use without the written consent of the City (which shall not be unreasonably withheld, conditioned or delayed).

NOW, THEREFORE, in consideration of the terms, conditions and mutual agreements by and between the parties as hereinafter set forth in detail, the parties do hereby mutually agree as follows:

I. AGREEMENT OF DEDICATION AND CONSTRUCTION

- 1. The foregoing recitals are incorporated into this Agreement and made a part thereof.
- 2. Legacy agrees to provide City with a copy of the Certificate of Liability Insurance, which must show that the policy is active, prior to the signing of this agreement.
- 3. Legacy agrees to and has attached all pertinent exhibits to this contract prior to the first submittal of this agreement to the City for review. Legacy further understands that failure to provide all pertinent exhibits prior to the first submittal of this agreement for review will result in a potential delay in the agreement approval process.
- 4. Legacy and City agree that Legacy shall be eligible and shall receive an offset of applicable Parkland Impact Fees as hereafter set forth for the Historic Home restoration effort, Arboretum construction, and Mountain Bike Trail System, dedication of land and easements, and associated improvements as illustrated in Exhibit C and as allowed under Title 25, Chapter 4 of the City of Franklin Municipal Code.

- 5. The total estimated cost of land and/or easement dedication, design, and the cost of labor, equipment, supplies, and materials used to preserve the Historic Home, construct the Arboretum, and construct the Mountain Bike Trail improvement as illustrated in Exhibit C, is One Million Nine Hundred Seventy-Three Thousand Seventy-Four Dollars (\$1,973,074) as indicated in Exhibit E, and the estimated total offset to Legacy is One Million Eight Hundred Thirty Three Thousand Five Hundred Four and 00/100 (\$1,833,504.00), as indicated on Exhibit F, upon submittal and approval of supporting documentation. The following costs are specifically excluded and not eligible for an offset: fiscal cost, including interest on money borrowed to finance the construction, cost for utility relocations, and other improvements that benefit the development.
- 6. Pursuant to Title 25, Chapter 4 of the Franklin Municipal Code, the eligible offset does and shall not exceed the total Parkland Impact Fees due for the Development Project.
- 7. The Historic Home, Arboretum, and Mountain Bike Trail system as depicted in Exhibits C and D shall be constructed, inspected, approved, and accepted in its entirety within two (2) years from the date of approval or the issuance of the first building permit for the development. Legacy shall post a Letter of Credit or cash surety with the City for the cost of the outstanding improvements as reasonably determined by the City of Franklin Parks Department Director prior to additional Certificate of Occupancy Permits being issued. Once the project has been accepted by the City, Legacy agrees to provide all finalized and approved detailed costs to the City at the final plat, and accurate reimbursement will be calculated and executed by the City
- 8. Legacy will build, restore, and construct the Historic Home, Arboretum, and Mountain Bike Trail as depicted in Exhibit C and as approved in the construction drawings approved by the City. The HPO and parkland dedication area on the Property totals approximately 10.03 acres. Upon acceptance of the restoration and construction per the plans on file with the City by Certificate of Occupancy, City will accept title to the Historic Structures, Arboretum, and Mountain Bike Trail System in fee simple by warranty deed and the City shall be responsible for maintaining the Historic Structures, Arboretum, and Mountain Bike Trail System.
- 9. Legacy shall be responsible for the location and protection of all existing utilities in accordance with State and local laws while utilizing the right-of-way. There shall be no offsets or reimbursement for relocating or protecting public utilities.
- 10. Legacy shall be solely responsible for the maintenance of the retaining wall, fencing, and parking stalls bordering the public right of way. Barring force majeure or weather delays, Legacy agrees, upon thirty (30) days written notice from the City, to remove, repair or replace trees, landscaping, and damage as described herein that may require reasonable removal, repair or replacement. The City reserves its right to determine health of the trees, landscaping, and condition of the retention wall, fencing, and parking stalls and, whether trees, landscaping, retention wall, fencing, and parking stalls are to be replaced and maintained. If no remedy is made within the specified time, the City reserves the

right to remove all affected trees and landscaping and repair the retention wall, fencing, and parking stalls with notice to Legacy and at the sole cost and expense of Legacy. Legacy shall submit payment for full cost and expense incurred by the City within forty-five (45) days of the date of the invoice.

- 11. Naming Rights. The policy of the City is to reserve naming or renaming of city assets to those circumstances which tradition and practice have shown to best serve the interests of the City and assure a worthy and enduring legacy for the City.
- 12. Organized Events. Events require a Special Event Permit which may be obtained through the Franklin Parks Department. No entity shall sponsor, host or organize an event at the Historic Home, Arboretum, and Mountain Bike Trail without prior approval of the Special Event Permit.
- 13. All improvements, uses, and activities shall comply with the policies established by the City of Franklin Zoning Ordinance and Municipal Code with the terms and conditions of this Agreement.
- 14. Upon completion and prior to acceptance of the Historic Home restoration, Arboretum construction, and Mountain Bike Trail improvements, Legacy will provide reasonable documentation for all such costs and provide notarized release of liens.
- 15. Final as-built plans shall be submitted immediately following completion of construction activities. If the project is developed in phases, as-built plans for each phase shall be submitted once the work is complete in that phase. Acceptance of Parkland dedication and construction projects will not be issued until satisfactory as-built plans have been approved by the Parks Department Director or designee and the City Engineer's designee. All aspects of the project that have been affected by construction shall be verified and appear on the as-built plans. This would include, but is not limited to the following items:
 - All property lines and easements
 - New and Existing structures (include restrooms, playground equipment, trail/multi-use paths, trail heads, pavilions, pools, athletic fields, athletic courts, athletic venues, etc.)
 - Location of all "as-built" work with station and offsets
 - Height and location of all fences, walls, screens, trees, and hedges over 42" tall
 - All commercial driveways, paved areas, and required parking spaces
 - All concealed components with station and offsets (include known buried cables, utilities, drainage structures, etc.)
 - All utilities
 - File formats shall be in a *.PDF along with either *.DWG, *.DXF, *.DGN, or AutoDACr14
 - Two paper sets

*Note: on all sheets referencing the Tennessee State Plane Coordination System, Zone 5301, Fipszone 4100; NAD 83 datum.

Concealed components will require documented proof to be submitted with the as-built plans in the form of a certified construction log that has been generated by the design engineer. As-built plans are required to be endorsed by a Tennessee registered professional engineer and or a registered land surveyor.

- 16. In the case of emergency situations where unplanned disturbance of the trees, landscaping, Home, Arboretum, and Mountain Bike Trail system, occurs due to natural disaster, emergency infrastructure repairs, or public safety/emergency response, and the City must act swiftly for the purposes of public safety, health and welfare, the City agrees to minimize disturbance to the extent feasible. The City will bring the site back to substantially similar condition as soon as practicable subject to budgetary constraints; other priorities that serve the public health, safety, and welfare; seasonal limitations for replacement or planting; and weather delays.
- 17. The Agreement shall be effective as of the date of execution by both parties and shall terminate only as provided within this Agreement.
- 18. This Agreement is non-transferable to the successors or assigns of Legacy unless the successor assumes the same obligations of Legacy in writing. Such assignment shall be provided to the City within fifteen (15) days after the transfer of the Development Project. Upon transfer, Legacy shall be relieved from any and all further liability under this Agreement, including, without limitation, pursuant to Section 18 hereof. Legacy shall exercise the rights, privileges and permission granted herein at Legacy's own risk. Legacy shall not claim any damages from the City for any injuries or damages, including death, about or because the exercise of such rights, privileges or permission, the condition of the non-exclusive, all-access public easement or the use of the non-exclusive, allaccess public easement excluding gross negligence or willful misconduct by the City and its Mayor, Aldermen, officers, employees, officials and agents. Legacy shall indemnify and hold harmless The City of Franklin, its officials and agents, its Mayor, Aldermen, officers, employees, officials and agents, from and against all claims, actual damages, actual losses and actual out-of-pocket expenses, including reasonable attorney's fees for outside counsel and costs, arising out of, resulting from, or in any way connected with the failure of Legacy to comply with any of the provisions specified herein or compliance with the approved plans. The City shall not be liable to Legacy should Legacy's use of the property be hindered or disturbed.
- 19. The City agrees that the terms and conditions contained herein shall be binding on and shall insure to its heirs, representatives, successors, and assigns and that there are no understandings or agreements between them except as contained in this instrument.
- 20. Applicable Law/Choice Forum and Venue. This Agreement is made under and will be construed in accordance with the laws of the State of Tennessee without giving effect to

that state's choice of law rules. The parties' choice for forum and venue shall be exclusively in the courts of Williamson County, Tennessee.

21. All notices required to be given by any party shall be in writing, addressed to all other parties, and delivered by certified mail or in person to:

In the case of the City:

City of Franklin Attn: Vernon J. Gerth, ACA 109 Third Ave. South P.O. Box 305 Franklin, TN 37065-0305

In the case of Legacy:

Goldberg Companies, Inc. Attn: Jordan Goldberg 25101 Chagrin Blvd., Suite 300 Beachwood, OH 44122

Goldberg Companies, Inc. Attn: Peter Nintcheff 25101 Chagrin Blvd., Suite 300 Beachwood, OH 44122

- 22. This Agreement shall be recorded with the Williamson County Register of Deeds with a copy maintained in the City Recorder's office in City Hall, Franklin, TN. Upon completion of this Agreement, the City agrees to cover the costs and responsibility associated with recording this Agreement.
- 23. This Agreement constitutes the entire agreement between parties. There are no further or other agreements or understandings, written or oral, in effect between the parties, relating to the subject matter hereof. This Agreement may be amended or modified only by an instrument of equal formality signed by the respective parties.

II. GENERAL TERMS AND CONDITIONS

1. **Personal Liability.**

No member, Mayor, Alderman, official, or employee of the City shall be personally liable to Legacy or any successor in interest, in the event of any default or breach by the City, or for any amount which may become due to Association or successor or on any obligations hereunder; provided, however, the City shall remain liable to Legacy for its gross negligence and willful misconduct. The City shall only look to Legacy and the Development Project for the enforcement of Legacy's obligations hereunder. None of the trustees, officers, directors, employees, members, owners, partners or shareholders of Legacy or any direct or indirect owner of Legacy shall have any personal liability for any of the liability or obligations of Legacy in connection herewith.

2. Warranties/Limitation of Liability/Waiver.

The City reserves all rights afforded to local governments under law for all general and implied warranties. The City does not waive any rights it may have to all remedies

provided by law and therefore any attempt by Legacy to limit its liability shall be void and unenforceable.

3. Severability.

If any term or provision of this Agreement is held to be illegal or unenforceable, the validity or enforceability of the remainder of this Agreement will not be affected.


[Signature pages follow next]

IN WITNESS WHEREOF the said parties have hereunto set their signatures, on this day and date first above written.

CITY OF FRANKLIN, TENNESSEE	Attest:	
By: Dr. Ken Moore, Mayor Date:	By:Eric S. Stuckey, City	
STATE OF TENNESSEE COUNTY OF WILLIAMSON)))	
Before me,	idence), and where, upon oath, D cknowledged himself to be City	r. Ken Moore acknowledged Administrator of the City of
Witness my hand and seal, at office, this _	day of	, 20
NOTARY PUBLIC		
My Commission Expires:		
Approved as to form:		
By:Shauna R. Billingsley, City Attorney	-	

LEGACY, LLC, an Ohio limited liability company
By:
Name:
Title:
A notary public or other officer completing this certificate verifies only the identity of the individual who signed the document to which this certificate is attached, and not the truthfulness, accuracy, or validity of that document.
STATE OF OHIO) COUNTY OF)
COUNTY OF
On, before me,,
On
I certify under PENALTY OF PERJURY under the laws of the State of Ohio that the foregoing paragraph is true and correct.
WITNESS my hand and official seal.
(seal)
Signature

Exhibit A COF Contract No. 2019-00096

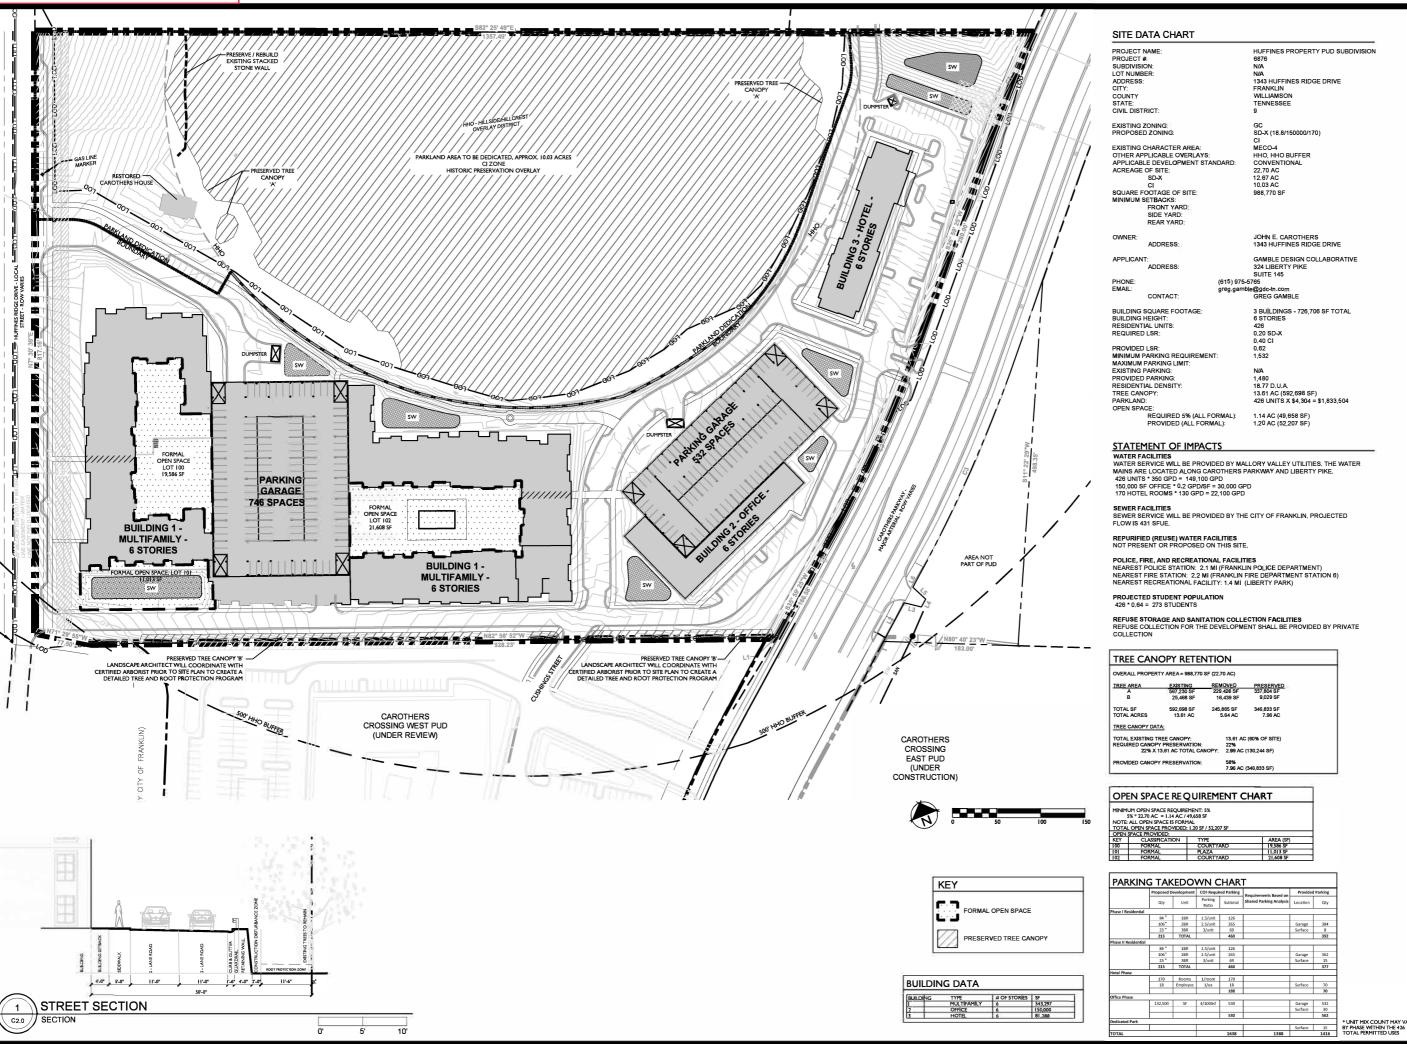

GAMBLE ESIGN COLLABORATIV

VELOPMENT PLANNING ANI ANDSCAPE ARCHITECTURE

S PROPERTY PUD SUBDIVISION DEVELOPMENT PLAN Franklin, Williamson County, Tennessee

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HUFFINE



Revision Date

DEVELOPMENT PIAN SHEET

C2.0 COF # 6876

COF Contract No. 2019-0096

EXHIBIT B

Huffines Property PUD Subdivision Park Impact Fee Offset Narrative

The Legacy Cool Springs Apartments development plan proposes 426 residential units generating \$1,833,504.00 in Parkland Impact Fees. The project team intends to offset these Parkland Impact Fees through a combination of **land dedication** and **constructed improvements** to the national historic registered John Henry Carothers Home site at Huffine's Ridge.

Proposed Land Dedication:

The proposed development plan (as re-submitted on February 7, 2019) shows a 10.03-acre parcel to be zoned Civic and Institutional (CI) with a Historic Preservation Overlay (HPO) which is home to the John Henry Carothers Home. These 10.03 acres are proposed to be dedicated to the City of Franklin as a park. This land has an offset value of \$62,121.00 per acre as established in the parkland dedication ordinance.


Proposed Constructed Improvements:

First and foremost, the project team intends to develop a mountain bike/hiking trail system as a continuation of trail systems proposed in development projects to the east. The J.H. Carothers house will be restored and will serve as a community meeting space and trailhead to the trail system. The team will work with COF parks staff to design and program this building to the standards required by the City.

The City of Franklin has expressed interest in additional improvements to the site of the historic home. The immediate surroundings of the home are proposed to be improved through the construction of an arboretum/community garden designed in partnership with Parks Staff. Additionally, a securable maintenance shed for park equipment and a covered storm shelter are to be built by using reused/recycled materials from the existing outbuildings on site to the greatest extent possible. Wayfinding and interpretive signage are also proposed.

The site is also intended to function as an extension of the trail network proposed on parcels to the east of Carothers Parkway. Mountain bike/hiking trails, a trailhead, wayfinding signage, and parking are all planned. The development team also proposes to restore and rebuild historic stone walls where possible and to re-use stone wall materials where walls cannot be rebuilt. The project additionally includes the construction of a four-rail horse fence with wire mesh to serve as a guardrail to proposed retaining walls.

Exhibit C

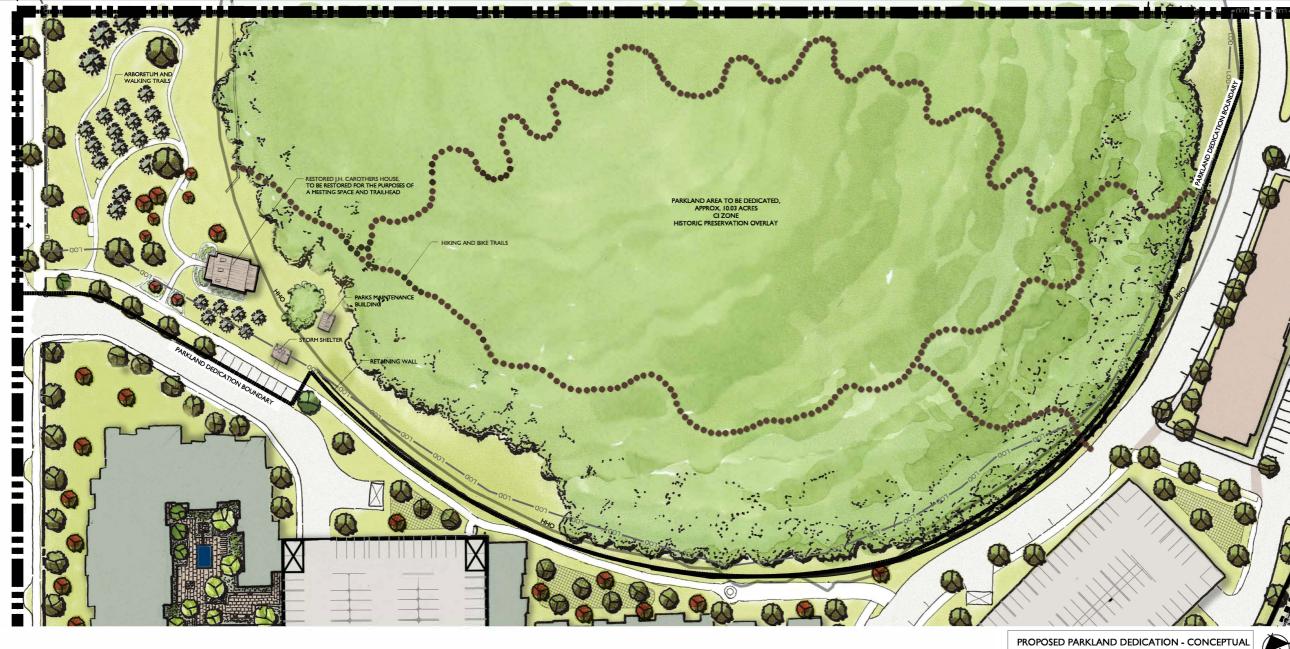

PARK IMPACT FEE OFFSET NARRATIVE

The Huffines Property PUD Development Plan proposes 426 residential units generating \$1,833,504 in Parkland Impact Fees. The project team intends to offset these Parkland Impact Fees through a combination of land dedication and constructed improvements to the national historic registered John Henry Carothers Home site on Huffines Ridge.

Proposed Land Dedication:

The proposed development plan (COF #6876) shows a 10.03-acre parcel to be zoned Civic and Institutional (CI) with a Historic Preservation Overlay (HPO) which is home to the John Henry Carothers Home. These 10.03 acres are proposed to be dedicated to the City of Franklin as a Park. This land has an offset value of \$62,121 per acre as established in the parkland dedication ordinance.


Proposed Constructed Improvemen

First and foremost, the project team intends to develop a mountain bike/hiking trail system as a continuation of trail systems proposed in development projects to the east of Carothers Parkway. In addition to trails, a trailhead, wayfinding signage, and parking are all planned. The J.H. Carothers house will be restored and will serve as a community meeting space and trailhead to the trail system. The team will work with COF parks staff to design and program this building to the standards required by the City.

The City of Franklin has expressed interest in additional improvements to the site of the historic home. The immediate surroundings of the home are proposed to be improved through the construction of an arboretum/community garden designed in partnership with Parks Staff. Additionally, a securable maintenance shed for park equipment and a covered storm shelter are to be built using reused/recycled materials from the existing outbuildings on site to the greatest extent possible. Also proposed are wayfinding and interpretive signage, and pedestrian lighting from the historic home to parking.

The development team also proposes to restore and rebuild historic stone walls where possible and to re-use stone wall materials where walls cannot be rebuilt. The project additionally includes the construction of a four-rail horse fence with wire mesh to serve as a guardrail to proposed retaining walls.

FINAL PLANS WILL BE PROVIDED AT SITE PLAN AND WILL REQUIRE HZC REVIEW.

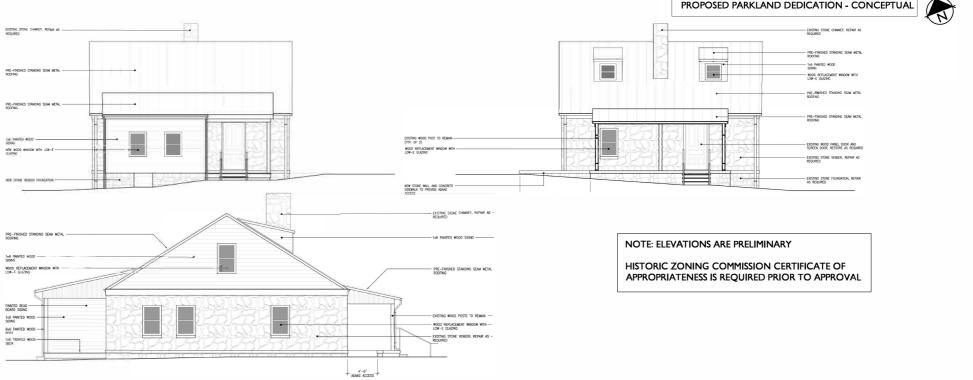

GENERAL DESIGN COLLABORATIVI DEVELOPMENT PLANNING AN LANDSCAPE ARCHITECTURE

HUFFINES PROPERTY PUD SUBDIVISION DEVELOPMENT PLAN Franklin, Williamson County, Tennessee



Issued: Dec. 10, 2018
Revision Date

PARKLAND DEDICATION PLAN SHEET C2.2

DESIGN DEVELOPMENT

JOHN CAROTHERS PROPERTY HOUSE RESTORATION AND RENOVATION

HUFFINES RIDGE DRIVE FRANKLIN, TENNESSEE 37067

	INDEX OF I		
	GENERAL (2) G1.00 TITLE SHEET, GENERAL INFORMATION G2.00 STANDARDS ARCHITECTURAL (8) A1.00 ARCHITECTURAL SITE PLAN A1.50 DEMOLITION PLANS A2.00 LIFE SAFETY PLAN A2.10 ARCHITECTURAL FLOOR PLAN AND FINISH PLAN A2.20 ARCHITECTURAL CEILING PLAN AND ROOF PLAN A4.00 EXTERIOR ELEVATIONS A4.10 BUILDING SECTIONS A4.11 BUILDING SECTIONS		
GENERAL NOTES:	PROJECT INFORMATION:	APPLICABLE BUILDING CODES AND STANDARDS:	VICINITY MAP:
 THE GENERAL CONTRACTOR IS RESPONSIBLE TO SUPPLY ALL SUBCONTRACTORS WITH CONSTRUCTION DRAWINGS AND SPECIFICATIONS NECESSARY TO BID AND/OR CONSTRUCT THIS PROJECT. ALL DIMENSIONS ON THE FLOOR PLANS, UNLESS OTHERWISE NOTED, ARE TAKEN FROM FACES OF STUDS OF EXTERIOR WALLS AND INTERIOR WALLS. THE OWNER SHALL BE RESPONSIBLE FOR NOTIFYING THE GENERAL CONTRACTOR OF ANY ADDITIONAL ITEMS TO BE INSTALLED THAT ARE NOT SHOWN ON THE DRAWINGS. ANY PENETRATIONS OF, OR MODIFICATIONS TO CONCRETE MUST BE COORDINATED WITH ARCHITECT PRIOR TO CONSTRUCTION. IN ACCORDANCE WITH GENERALLY ACCEPTED CONSTRUCTION PRACTICES, THE CONTRACTOR WILL BE SOLELY AND COMPLETELY RESPONSIBLE FOR CONDITIONS OF THE JOB SITE, INCLUDING SAFETY OF ALL PERSONS AND PROPERTY DURING PERFORMANCE OF WORK. THIS REQUIREMENT WILL APPLY CONTINUOUSLY AND SHALL NOT BE LIMITED TO NORMAL WORKING HOURS. THE CONTRACTOR SHALL TAKE ALL NECESSARY PRECAUTIONS TO BE INSTALL TAKE ALL NECESSARY PRECAUTIONS TO RECULTAINS REPITE AS A PETTY AND THE PREMISES. THE CONTRACTOR SHALL COMPLY WITH ALL LAWS, ORDINANCES, CODES, RULES AND REGULATIONS RELITIVE TO SAFETY AND THE PREVENTION OF ACCIDENTS. WHETHER OR NOT SPECIFICALLY INDICATED ON THE DRAWINGS, ALL CONTRACTORS SHALL BE RESPONSIBLE FOR REMOVING OR DEMOLISHING EXISTING CONSTRUCTION (INCLUDING UTILITIES) WHICH WILL INTERFERE WITH NEW WORK. PRIOR TO THE SHUT-DOWN OR TYING INTO ANY UTILITY, APPROVAL SHALL BE OBTAINED FROM THE OWNER'S REPRESENTATIVE. COORDINATE WITH OWNER'S REPRESENTATIVE, LOCATION OF CONTRACTORS' EQUIPMENT AND MATERIAL STORAGE. ALL MECHANICAL WORK SHALL BE PERFORMED BY A LICENSED PLUMBING CONTRACTOR AND IN ACCORDANCE WITH ALL APPLICABLE CODES AND STANDARDS. ALL ELECTRICAL WORK SHALL BE PERFORMED BY A LICENSED PLUMBING CONTRACTOR AND IN ACCORDANCE WITH ALL APPLICABLE CODES AND STANDARDS. ALL STRUCTURAL FRAMING WORK SHALL BE PERFORMED BY A LICENSED ELECTRICAL CONTRACTOR AND IN ACCO	OCCUPANCY CLASSIFICATION: IBC: BUSINESS: GROUP B ASSEMBLY USE: 42 OCCUPANTS NFPA: New BUSINESS: – CHAPTER 38 KITCHEN USE: 2 OCCUPANTS TYPE OF CONSTRUCTION: IBC: TYPE V (B) NFPA: TYPE V (000) ALLOWABLE NO. OF STORIES: 2 NO. OF STORIES: 1 ALLOWABLE BUILDING HEIGHT: 40'-0" BUILDING HEIGHT: 40'-0" BUILDING HEIGHT: 20'-0" ALLOWABLE BUILDING AREA: 9,000 S.F. BUILDING AREA: 1,068 S.F. PROJECT DESCRIPTION: THIS PROJECT INVOLVES THE CONVERSION OF AN EXISTING SINGLE FAMILY RESIDENCE INTO A PUBLIC MEETING SPACE WITH RESTROOM FACILITIES AND WARMING KITCHEN. THIS CONVERSION INCLUDES ARCHITECTURAL, PLUMBING, MECHANICAL, AND ELECTRICAL WORK.	2018 INTERNATIONAL BUILDING CODE INCLUDING APPENDICES D, G AND K 2018 INTERNATIONAL ENERGY CONSERVATION CODE (FOR BUILDINGS REVIEWED UNDER THE IBC) 2018 INTERNATIONAL FIRE CODE INCLUDING APPENDICES B, C AND D 2018 INFERNATIONAL PLUMBING CODE 2018 INTERNATIONAL PLUMBING CODE 2018 INTERNATIONAL MECHANICAL CODE 2018 INTERNATIONAL FUEL GAS CODE 2018 INTERNATIONAL EVISTING BUILDING CODE 2018 INTERNATIONAL EXISTING BUILDING CODE 2018 INTERNATIONAL RESIDENTIAL CODE INCLUDING APPENDICES G AND J 2009 INTERNATIONAL RESIDENTIAL CODE INCLUDING APPENDICES G AND J 2018 INTERNATIONAL PROPERTY MAINTENANCE CODE 2018 INTERNATIONAL PROPERTY MAINTENANCE CODE 2018 INTERNATIONAL SWIMMING POOL AND SPA CODE PROFESSIONAL OF RECORD: ARCHITECT: FUSION ARCHITECTURE, PC 116 MAJESTIC LANE FRANKLIN, TENNESSEE 37064	Google
		VOICE: 615.454.3916 CONTACT: KYLE M. KRAMER, ARCHITECT EMAIL: kkramer@fusionarchitecture.com	PROJECT SITE N JOHN CAROTHERS HOUSE HUFFINES RIDGE DRIVE FRANKLIN, TENNESSEE 37067
SYMBOLS LEGEND:	CONSU	HATCH LEGEND:	
XXXX ROOM NUMBER DETAIL TAG XXXX KEY NOTE XXXX DOOR NUMBER P-X PARTITION TAG XXXX PHOTO TAG XXXXX ELEVATION TAG XXXXX ELEVATION TAG XXXXX KEY NOTE			PLAN: SPANDREL GLASS INSULATION
X:AX.XX SECTION TAG XX KEY NOTE			CLEAR GLASS STEEL

FUSION ARCHITECTURE

COF Contract No. 2019-00096

FUSION ARCHITECTURE, PC

116 MAJESTIC LANE FRANKLIN, TENNESSEE 37064 V: 615.454.3916 W: FUSIONARCHITECTURE.COM

and is not to be reproduced or copied in whole or part. It is only to be used for the project and si

personal supervision, and to the best of our kn

EXHIBIT

PROJECT NUMBER 03-014-18

SHEET TITLE


TITLE SHEET

1. DETAILS AND NOTES ON THIS SHEET SHALL GOVERN STANDARD DIMENSIONS ,CLEARANCES, AND MOUNTING LOCATIONS. CONTRACTOR SHALL IMMEDIATELY BRING TO ARCHITECT'S ATTENTION ANY DISCREPENCIES BETWEEN INFORMATION ON THIS SHEET AND ANY OTHER INFORMATION IN

2. ALL NOTES, ABBREVIATIONS AND DETAILS MAY NOTE APPLY.

ADDDE MATIONIC

	ABBREVIATIONS:					
A	AMPERES	F.F.E.	FINISH FLOOR ELEVATION	OPNG.	OPENING	
A.B.	ANCHOR BOLT	F.N.	FIELD NAILING	OPPO.	OPPOSITE	
A.F.G.	ABOVE FINISHED FLOOR ABOVE FINISHED GRADE	F.O. F.S.	FACE OF FLOOR SINK	P.C. P.L. or P	PRECAST CONCRETE	
A.F.G. A/C	AIR CONDITIONING	F/G	FIBERGLASS	P.LAM.	PROPERTY LINE PLASTIC LAMINATE	
ABC	AGGREGATE BASE COURSE	FAB.	FABRICATE	P.O.C.	POINT OF CONNECTION	
ABS	ACRYLONITRILE-BUTADIENE-STYRENE	FACP	FIRE ALARM CONTROL PANEL	PERF.	PERFORATED	
ABV.	ABOVE	FDC	FIRE DEPARTMENT CONNECTION	PERP. or ⊥	PERPENDICULAR	
ACB	ASBESTOS—CEMENT BOARD	FDN.	FOUNDATION CARDINET	PH or Ø	PHASE	
ACOU.	ACOUSTIC ACOUSTICAL CEILING TILE	FHC FIN.	FIRE HOSE CABINET	PL. or FL	PLASTER PLATE	
ADD.	ADDITION or ADDENDUM	FL FL	FLOOR	PLAS.	PLASTIC	
AG	ABOVE GRADE	FLG.	FLOORING	PLUMB.	PLUMBING	
AHU	AIR HANDLING UNIT	FLUOR.	FLUORESCENT	PLYWD.	PLYWOOD	
AL. or ALUM.	ALUMINUM	FP	FIRE PROOF	PORC.	PORCELAIN	
ALT.	ALTERNATE	FRP	FIBER REINFORCED PLASTIC	PREFAB.	PREFABRICATED	
ANL ASPH.	ANNEALED ASPHALT	FTG. FURN.	FOOTING FURNISH	PSF PSI	POUNDS PER SQUARE FOOT POUNDS PER SQUARE INCH	
AVG	AVERAGE	G.I.	GALVANIZED IRON	PTN.	PARTITION	
AWG	AMERICAN WIRE GAUGE	GA.	GAUGE	PVC	POLYVINYLCLORIDE	
4	ANGLE	GALV.	GALVANIZED	PWR.	POWER	
B.M.	BENCH MARK	GAR.	GARAGE	Q.T.	QUARRY TILE	
B.N. B.O.	BOUNDARY NAILING BOTTOM OF	GFCI	GROUND FAULT CIRCUIT	QTY.	QUANTITY RADIUS	
B.O.F.	BOTTOM OF FOOTING	GFI	GROUND FAULT INTERRUPTER	RCP	REINFORCED CONCRETE PIP	
B.U.	BUILT UP	GL	GLASS	R.D.L.	ROOF DRAIN LEADER	
B/C	BACK OF CURB	GLB	GLUE LAMINATED BEAM	R.D.O.	ROOF DRAIN OVERFLOW	
BD.	BOARD	GM	GRADE MARK	R.O.	ROUGH OPENING	
BLDG	BUILDING	GV	GATE VALVE	R.O.W. or	RIGHT OF WAY	
BLKG.	BLOCK BLOCKING	GRC GYP.	GALVANIZED RIGID TUBING GYPSUM	R/W REF	REFRIGERATOR	
BLKG.	BEAM	GYP. BD.	GYPSUM BOARD	RE:	REFERENCE	
BR BR	BRASS	H.B.	HOSE BIBB	REINF.	REINFORCED	
BRG.	BEARING	H.C.	HOLLOW CORE	REQ'D.	REQUIRED	
BRZ	BRONZE	H.M.	HOLLOW METAL	RET.	RETURN	
C.A.P.	CONCRETE ASBESTOS PIPE	H/C	HANDICAPPED	REV.	REVISION	
C.D.	CONSTRUCTION DOCUMENTS CAST IN PLACE	HDBD. HDW	HARDBOARD HARDWARE	RMV.	ROOM REMOVE	
C.J.	CONTROL JOINT	HGT.	HEIGHT	S.C.	SOLID CORE	
C.O.	CLEAN OUT	HOR.	HORIZONTAL	S.D.	SMOKE DETECTOR	
C.T.	CERAMIC TILE	HTR	HEATER	S.O.V.	SHUT OFF VALVE	
CAB	CABINET	HVAC	"HEATING, VENTILATING &	S/L	SKYLIGHT	
CAM.	CAMBER CIRCUIT TELEVISION	1 NAV	AIR CONDITIONING"	S/S	STAINLESS STEEL	
CCTV CEM.	CLOSED CIRCUIT TELEVISION CEMENT	HW HYD.	HOT WATER HYDRAULIC	SC SCHED.	SELF CLOSING SCHEDULE	
CER	CERAMIC	I.C.	INTERCOM OUTLET	SECT.	SECTION	
CFM	CUBIC FEET PER MINUTE	I.D.	INSIDE DIAMETER	SES	SERVICE ENTRANCE SECTION	
CH or □	CHANNEL	I.F.	INSIDE FACE	SH	SHEET	
CKT. BKR.	CIRCUIT BREAKER	ID	IDENTIFICATION	SHT'G.	SHEATHING	
CL or Q	CENTERLINE CEILING	IG IMC	ISOLATED GROUND	SIM.	SIMILAR SPACE	
CLG.	CAULKING	IMPG	INTERMEDIATE METALLIC CONDUIT IMPREGNATED	SPECS	SPECIFICATIONS	
CLO.	CLOSET	INCL.	"INCLUDE, INCLUSIVE"	SPKR.	SPEAKER	
CLR.	CLEAR	INSUL.	INSULATION	<u> </u>	SQUARE FEET	
CMP	CORRUGATED METAL PIPE	INT.	INTERIOR	SQ. IN.	SQUARE INCHES	
CMU	CONCRETE MASONRY UNIT	J-BOX	JUNCTION BOX	STC	SOUND TRANSMISSION CLAS	
CNTRD.	CENTERED	JCT JST.	JUNCTION JOIST	STD.	STANDARD STEEL	
COMB.	COMBINATION	JT.	JOINT	SUSP.	SUSPENDED	
CONC.	CONCRETE	K-D	KNOCK DOWN	SW	SWITCH	
CONST.	CONSTRUCTION	KD	KILN DRIED	SYM	SYMMETRICAL	
CONT.	CONTINUOUS	KO	KNOCK OUT	SYS.	SYSTEM	
CONTR.	CONTRACTOR COPPER	L.E.D. L.FT.	LIGHT EMITTING DIODE LINEAR FEET	T & G	TONGUE AND GROOVE THROUGH BOLT	
d	PENNY	LAM	LAMINATE	T.M.B.	TELEPHONE MOUNTING BOA	
D.F.	DRINKING FOUNTAIN	LAT.	LATERAL	T.O.	TOP OF	
D.G.	DECOMPOSED GRANITE	LAV	LAVATORY	T.O.B.	TOP OF BEAM	
D.S.	DOWN SPOUT	LD.	LEAD	T.O.C.	TOP OF CURB	
D/W	DISHWASHER	LIN.	LINEAR	T.O.F.	TOP OF FOOTING	
DBL. DEMO	DOUBLE DEMOLITION	LINO. LT.	LINOLEUM	T.O.J.	TOP OF JOIST TOP OF MASONRY	
DIA. or Ø	DIAMETER	LTG.	LIGHTING	T.O.S.	TOP OF SLAB-TOP OF STE	
DIAG.	DIAGONAL	LVL	LAMINATED VENEER LUMBER	T.O.W.	TOP OF WALL	
DIM.	DIMENSION	M.B.	MACHINE BOLT	T.S.	TUBE STEEL	
DL	DEAD LOAD	M.H.	MANHOLE	T.V.	TELEVISION OUTLET	
DN.	DOWN	M.I.	MALLEABLE IRON MASONRY OPENING	TEL.	TELEPHONE THRESHOLD	
DR E.A.	DOOR EXPANSION ANCHOR	M.O. MAR.	MASONRY OPENING MARBLE	TH.	THRESHOLD THREADED	
E.F.	EXHAUST FAN	MAS.	MASONRY	THK.	THICK	
E.J.	EXPANSION JOINT	MAT'L	MATERIAL	THRU	THROUGH	
E.N.	END NAILING	MAX.	MAXIMUM	TLT.	TOILET	
E.W.	EACH WAY	MECH.	MECHANICAL	TRANS.	TRANSFORMER	
EA. EL	EACH ELEVATION	MED. MFG.	MEDIUM MANUFACTURING	TYP.	TYPICAL UNFINISHED	
ELECT.	"ELECTRIC, ELECTRICAL"	MFG.	MANUFACTURER	U.N.O.	UNLESS NOTED OTHERWISE	
ELEV.	ELEVATOR ELECTRICAL	MIN.	MINIMUM	UR	URINAL	
EMC	ELECTRICAL METALLIC CONDUIT	MISC.	MISCELLANEOUS	V.B.	VAPOR BARRIER	
EMT	ELECTRICAL METALLIC TUBING	MOD	MODULAR	V.I.F.	VERIFY IN FIELD	
ENT	ELECTRICAL NON-METALLIC TUBING	MTL.	METAL	VA	VOLT AMPERE	
EQ. EQUIP.	EQUIPMENT	MUL N.I.C.	NOT IN CONTRACT	VCT VERT.	VINYL COMPOSITION TILE VERTICAL	
EST.	ESTIMATE	N.I.C. N.T.S.	NOT TO SCALE	VERT.	VERTICAL VERIFY ON JOB	
EVAP.	EVAPORATIVE COOLER	NCM	NON-CORROSIVE METAL	W/C	WATER CLOSET	
EWC	ELECTRIC DRINKING COOLER	NFC	NOT FOR CONSTRUCTION	WDW	WINDOW	
EXC	EXCAVATE	NLR.	NAILER	WCT	WAINSCOT	
EXH.	EXHAUST	NO.	NUMBER	WP	WEATHER PROOF	
EXIST.	EXISTING	NOM.	NOMINAL ON CENTER	WT.	WEIGHT	
F.A.	EXTERIOR FIRE ALARM	0.C. 0.D.	ON CENTER OUTSIDE DIAMETER	W/ W/O	WITHOUT	
F.C.	FAN COIL	0.D. 0.H.	OVER HANG	WD.	WOOD	
F.C.O.	FLOOR CLEAN OUT	0.1.	ORNAMENTAL IRON	W.I.	WROUGHT IRON	
F.D.	FLOOR DRAIN	0.R.	OUTSIDE RADIUS	YD.	YARD	
F.E.	FIRE EXTINGUISHER	OAI	OUTSIDE AIR INTAKE			
F.F.	FINISH FLOOR	OH	OVER HEAD			
			•			

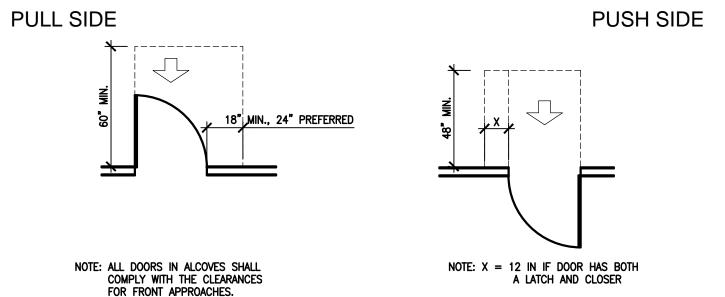



FRONT APPROACHES - SWINGING DOORS PULL SIDE **PUSH SIDE**


> BOTH A LATCH AND CLOSER X = 42IN MINIMUM IF Y = 54INHINGE SIDE APPROACHES - SWINGING DOORS


NOTE: Y = 48IN MINIMUM IF DOOR HAS

NOTE: X = 36IN MINIMUM IF Y = 60IN;

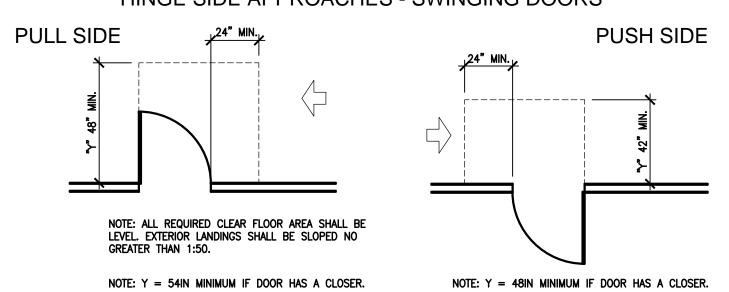

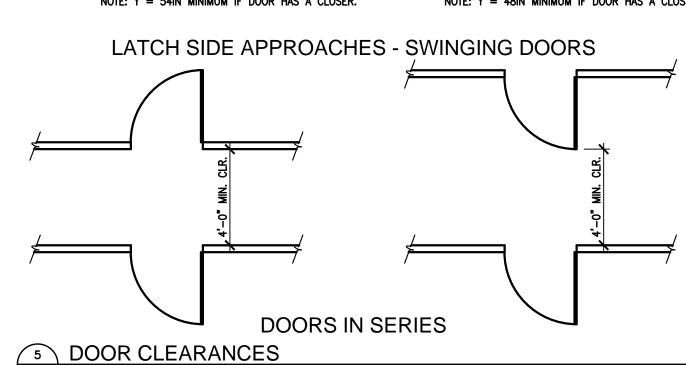

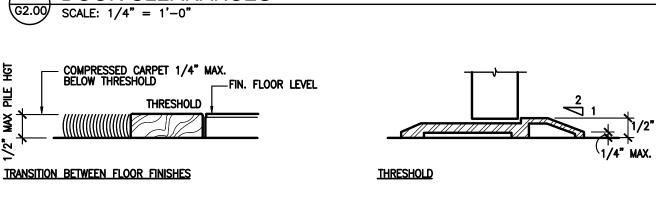


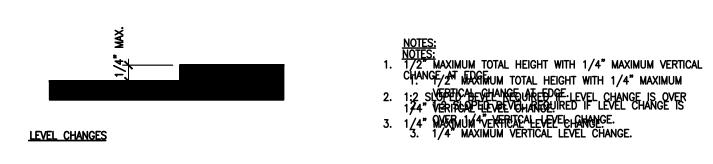

8 THRESHOLD / LEVEL CHANGES G2.00 SCALE: 6" = 1'-0"

DETECTABLE WARNING SURFACES INSIDE PROPERTY LINES: DETECTABLE WARNING AREAS SHALL CONSIST OF A REGULARLY SPACED, CONTINUOUS PATTERN OF GROOVES RUNNING PERPENDICULAR TO THE RUN OF A CURB RAMP OR PARALLEL TO THE EDGE BETWEEN A CIRCULATION PATH AND A HAZARDOUS AREA. GROOVES SHALL BE 1/4" WIDE BY 5/8" DEEP SPACED 3" O.C. WARNING AREAS SHALL CONTRAST VÍSUALLY WITH ADJOINING SURFACES, EITHER LIGHT-ON-DARK, OR DARK-ON-LIGHT.


DETECTABLE WARNING SURFACES OUTSIDE PROPERTY LINES: DETECTABLE WARNINGS SHALL CONSIST OF RAISED TRUNCATED DOMES WITH A DIAMETER OF NOMINAL 0.9", A HEIGHT OF NOMINAL 0.2" AND A CENTER-TO-CENTER SPACING OF NOMINAL 2.35" AND SHALL CONTRAST VISUALLY WITH ADJOINING SURFACES, EITHER LIGHT-ON-DARK, OR DARK-ON-LIGHT.

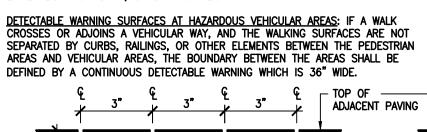

DETECTABLE WARNING SURFACES INSIDE PROPERTY LINES

G2.00 SCALE: 3" = 1'-0"

DETECTABLE WARNING SURFACES OUTSIDE PROPERTY LINES 10 DETECTABLE WARNING SURFACES

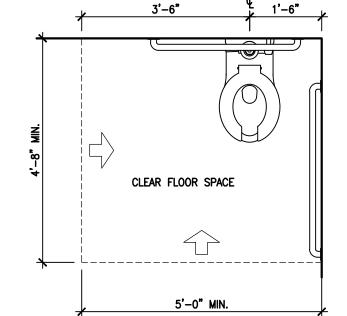

1 CLEAR FLOOR SPACE AT ACCESSIBLE WATER CLOSETS

7'-4" CLR. MIN.

3 STANDARD ACCESSIBLE SINGLE FIXTURE TOILET

G2.00 SCALE: 1/2" = 1'-0"

30" X 48" LAVATORY -CLEAR FLOOR SPACE

60" DIA. TURNING RADIUS -

56" X 60" WATER CLOSET -

MINIMUM 6" METAL STUD -

G2.00 SCALE: 1/2" = 1'-0"

LEVEL LANDING

♠ RAMP HANDRAIL

9 STAIR HANDRAIL G2.00 SCALE: 1/2" = 1'-0"

-FIRE EXT. CABINET

COUNTER TOP RECEPTACLE -

11 STANDARD MOUNTING HEIGHTS

G2.00 SCALE: 1/2" = 1'-0"

-ROOM SIGNAGE

LIGHT SWITCH -

(POWER, TEL.

CABLE, DATA)

- OUTLET

G2.00 SCALE: 1/2" = 1'-0"

T = (1) TREAD WIDTH $\frac{1'-0"}{}$ MIN.


LEVEL LANDING

NOTE: ENDS OF NON-CONTINUOUS HANDRAILS SHALL BE EITHER ROUNDED OR RETURNED SMOOTHLY TO FLOOR, WALL, OR POST.

OR 5 1/2" WOOD STUD

WALL (RE: PLANS) WATER CLOSET -

CLEAR FLOOR SPACE

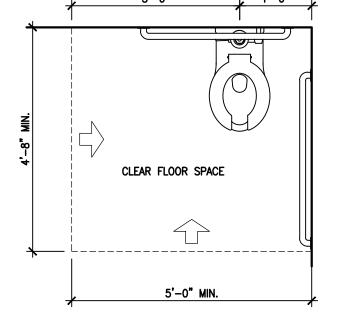

- 2" MIN. CURB OR SIDE EXTENSION (RE: BELOW)

LEVEL LANDING

- SIDE EXTENSION —

NOTE: PROVIDE SECOND SET OF

HANDRAILS AT 24" A.F.F. WHEN

CHILDREN ARE PRIMARY USERS

HANDRAILS SHALL BE EITHER ROUNDED OR RETURNED SMOOTHLY

TO FLOOR, WALL, OR POST.

LEVEL LANDING

CIRCULAR

— TOILET PARTITION

URINAL SCREEN

TOILET PAPER DISP.

NOTE: ENDS OF NON-CONTINUOUS

PERIMETER

HANDRAIL PROFILES


NON-CIRCULAR


COAT HOOK-

SOAP DISP.

- PAPER

TOWEL DISP.

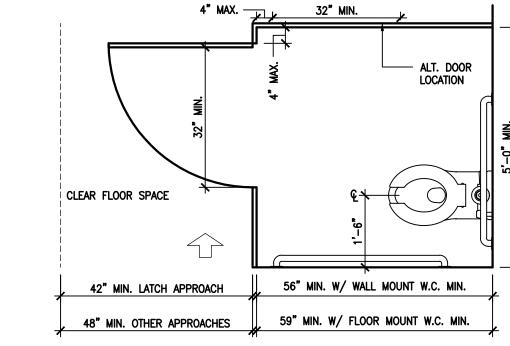

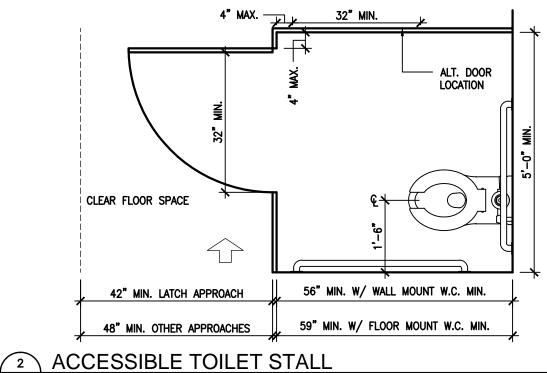



FRANKLIN, TENNESSEE 37064 V: 615.454.3916 W: FUSIONARCHITECTURE.COM

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PHASE | REVISION SCHEMATIC DESIGN DESIGN DEVELOPMENT CONSTRUCTION DOCUMENTS

ND REI

ATION

OR.

S

 $\frac{1}{2}$

EXHIBIT

JOHN E REST

PRO


AROTHERS

DRIVE EE 3700

HUFFINES RIDGE DANKLIN, TENNESSE

G2.00 SCALE: 1/2" = 1'-0"MIRROR LAVATORY PERTY:

39"-41"

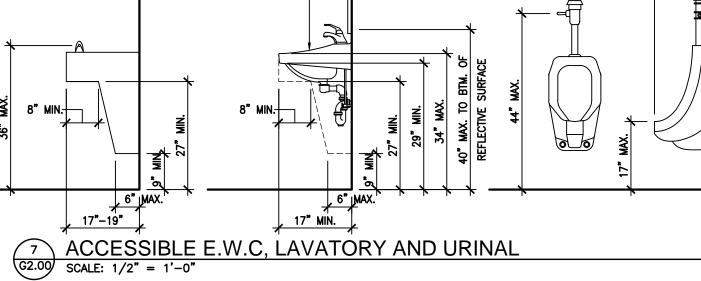

MOUNTING HEIGHTS AT ACCESSIBLE WATER CLOSETS

TOILET PAPER DISP.

INTERNATIONAL ACCESSIBLITY SYMBOL

<u>raised</u>

MEN

INTERNATIONAL TDD SYMBOL



G2.00 SCALE: 1/2" = 1'-0"

NOTE: FIXTURES SHOWN ARE FOR REFERENCE PURPOSES ONLY. RE: PLANS AND SPECIFICATIONS FOR

ACTUAL FIXTURE TYPES.

TOILET PAPER DISP. -

LIGHT BACKGROUND. 6. CHARCTERS AND NUMBERS ON SIGNS SHALL BE SIZED ACCORDING TO THE VIEWING DISTANCE FROM WHICH THEY ARE TO BE READ. THE MINIMUM HEIGHT IS

LETTERS AND NUMBERS:

FOR SIGNS SUSPENDED OR PROJECTED GREATER THAN 80" ABOVE THE FINISH FLOOR, THE MINIMUM CHARACTER HEIGHT SHALL BE 3". CONTRACTED GRADE 2 BRAILLE SHALL BE USED WHEREVER BRAILLE SYMBOLS SHALL BE 1/10" ON CENTERS IN EACH CELL WITH 2/10" SPACE BETWEEN

WITH DISABILITIES AND AT EVERY MAJOR JUNCTION ALONG OR LEADING TO AN ACCESSIBLE ROUTE OF TRAVEL SHALL BE IDENTIFIED WITH A SIGN DISPLAYING THE INTERNATIONAL SYMBOL OF ACCESSIBILITY AND WITH ADDITIONAL DIRECTIONAL SIGNS, AS REQUIRED, TO BE VISIBLE TO PERSONS ALONG APPROACHING PEDESTRIAN WAYS.

WHEN PERMANENT IDENTIFICATION IS PROVIDED FOR ROOMS AND SPACES. RAISED LETTERS SHALL BE PROVIDED AND SHALL BE ACCOMPANIED BY BRAILLE. SIGNS SHALL BE INSTALLED ON THE WALL ADJACENT TO THE LATCH OUTSIDE OF THE DOOR. WHERE THERE IS NO WALL SPACE ON THE LATCH SIDE, INCLUDING AT LEAF DOORS, SIGNS SHALL BE PLACE ON THE NEAREST ADJACENT WALL, PREFERABLY ON THE RIGHT. MOUNTING HEIGHT SHALL BE 60" ABOVE THE FINISH FLOOR TO THE CENTERLINE OF THE SIGN. MOUNTING LOCATION SHALL BE DETERMINED SO THAT THE PERSON MAY APPROACH WITHIN 3" OF THE SIGNAGE WITHOUT ENCOUNTERING PROTRUDING OBJECTS OR STANDING WITHIN THE SWING OF A DOOR.

D. ADDITIONAL DIRECTIONAL SIGNS ALONG ACCESSIBLE PATH OF TRAVEL ARE . BUILDINGS REMODELED TO PROVIDE ACCESSIBLE SANITARY FACILITIES FOR PUBLIC USE SHALL HAVE INFORMATION POSTED IN THE LOBBY AS PART OF THE BUILDING DIRECTORY.

INTERNATIONAL SYMBOL OF ACCESSIBILITY:

12. STANDARD USED TO IDENTIFY ACCESSIBLE FACILITIES.

13. WHITE FIGURE ON BLUE BACKGROUND. 14. WHEN ENFORCING AGENCY DETERMINES, IF APPROPRIATE, SPECIAL DESIGNS AND COLORS MAY BE APPROVED.

15. USE CONTRASTED GRADE 2 BRAILLE. DOTS TO BE 0.1 INCH ON CENTER IN

17. DOTS RAISED MINIMUM 0.025 INCH ABOVE BACKGROUND.

SHEET NUMBER

STANDARDS

PROJECT NUMBER

03-014-18

SHEET TITLE

12 ACCESSIBLE SIGNAGE G2.00 SCALE: NO SCALE

PROPORTIONS INTERNATIONAL ACCESSIBLITY SYMBOL

LETTERS AND NUMBERS ON SIGNS SHALL BE RAISED 1/32" MINIMUM AND SHALL BE SANS-SERIF UPPERCASE CHARACTERS ACCOMPANIED BY GRADE 2 BRAILLE. RAISED CHARACTERS OR SYMBOLS SHALL BE A MINIMUM OF 5/8" HIGH. PICTORIAL SYMBOL SIGNS (PICTOGRAMS) SHALL BE ACCOMPANIED BY THE EQUIVALENT VERBAL DESCRIPTION PLACED DIRECLY BELOW THE PICTOGRAM. THE BORDER DIMENSION OF THE PICTOGRAM SHALL BE A MINIMUM OF 6" IN HEIGHT. 4. LETTERS AND NUMBERS ON SIGNS SHALL HAVE A WIDTH-TO-HEIGHT RATIO OF BETWEEN 3:5 AND 1:1 AND A STROKE WIDTH-TO-HEIGHT RATIO BETWEEN 1:5 5. CHARACTERS AND SYMBOLS SHALL CONTRAST WITH THEIR BACKGROUND, EITHER

LIGHT CHARACTERS ON A DARK BACKGROUND OR DARK CHARACTERS ON A

MEASURED USING AN UPPER CASE X. LOWER CASE CHARACTERS ARE PERMITTED. ARE SPECIFICALLY REQUIRED IN OTHER PORTIONS OF THESE REGULATIONS. DOTS CELLS. DOTS SHALL BE RAISED A MINIMUM OF 1/40" ABOVE THE BACKGROUND.

SIGN LOCATIONS:

8. ALL BUILDING ENTRANCES THAT ARE ACCESSIBLE TO AND USABLE BY PERSONS

INTERNATIONAL SYMBOL OF ACCESS 16. 0.2 INCH SPACE BETWEEN CELLS.

LEGEND PROPERTY LINE (RE: SURVEY) — OHE — POWER LINE (RE: SURVEY) IMPERVIOUS CONCRETE PAVING (RE: CIVIL DWGS.) CONCRETE SIDEWALK (RE: CIVIL DWGS.) SEWER MANHOLE WATER VALVE FIRE HYDRANT POWER POLE □ POLE LIGHT W WATER METER GAS COCK AND METER ELECTRICAL METER

SITE PLAN GENERAL NOTES

- 1. COORDINATE ALL WORK SCHEDULING AND COMPLY WITH SAFETY PROCEDURES THAT PROTECT ALL OCCUPANTS IN CONSTRUCTION AREAS. OCCUPANTS IN CONSTRUCTION AREAS.

 2. CONSTRUCTION DEBRIS SHALL BE REMOVED AND/OR STORED AWAY FROM THE BUILDING ON A DAILY BASIS. DISPOSE OF TRASH AS REQUIRED BY ORDINANCE OR CODE.

 3. PROPER SITE DRAINAGE SHALL BE MAINTAINED AT ALL TIMES, DAMAGE CAUSED BY FAILING TO MAINTAIN SITE DRAINAGE SHALL BE THE RESPONSIBILITY OF THE GENERAL CONTRACTOR.

 4. PROVIDE COMPACTED FILL AT RUTS OR HOLES CAUSED BY CONSTRUCTION ACTIVITIES. REPAIR ANY CONCRETE DAMAGED DURING CONSTRUCTION.

 5. ALL NEW PAVING SHALL BE REINFORCED CONCRETE. THICKNESS AND REINFORCING SHALL BE AS DETAILED ON CIVIL DRAWINGS.

 6. ACCESSIBLE PARKING SPACE TO BE DESIGNATED BY BLUE STRIPING AND EITHER A BLUE SYMBOL ON A WHITE BACKGROUND OR A WHITE SYMBOL ON A BILLE BCAKGROUND ACCESSIBLE PARKING

- ON A WHITE BACKGROUND OR A WHITE SYMBOL ON A BLUE BCAKGROUND. ACCESSIBLE PARKING STALLS REQUIRE THE INSTALLATION OF THE PROPER SIGNAGE.

 7. ALL PARKING SPACES SHALL BE LAID OUT IN ACCORDANCE WITH THE TYPICAL DETAIL AS SHOWN ON THIS PLAN, UNLESS OTHERWISE INDICATED ON THIS PLAN.

 8. PRIOR TO INSTALLATION AND POURING OF CONCRETE PAVING, CONTRACTOR SHALL VERIFY AND COORDINATE ALL CONDUITS SIZES AND POLITIES.
- COORDINATE ALL CONDUIT SIZES AND ROUTES. 9. REFERENCE LANDSCAPE DRAWINGS FOR PLANTING AND SEEDING SCOPE OF WORK.

PARKING SUMMARY

SITE PLAN KEYNOTES

1 NEW CONCRETE SIDEWALK

JOHN CAROTHERS PROF HOUSE RESTORATION AND RE

03.08.2019

EXHIBIT

PROJECT NUMBER


03-014-18


SHEET TITLE


ARCH. SITE PLAN

SHEET NUMBER

A1.00

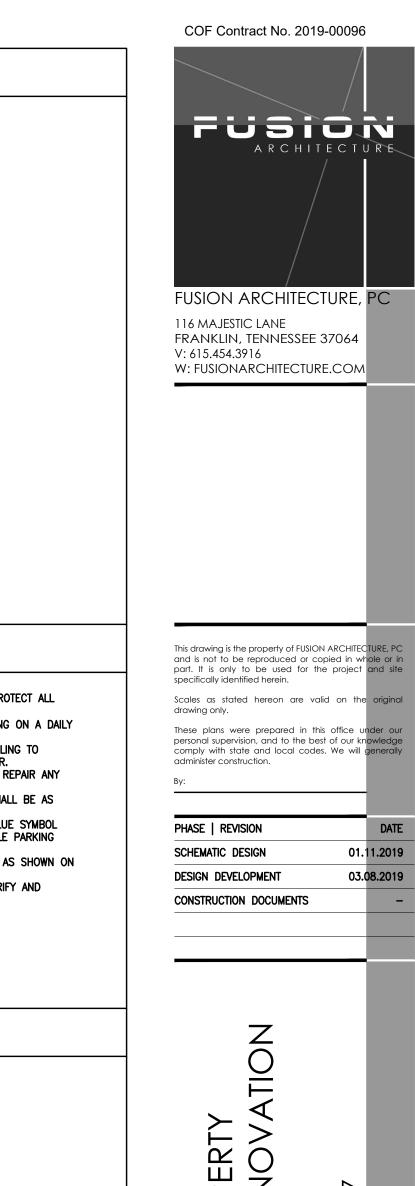

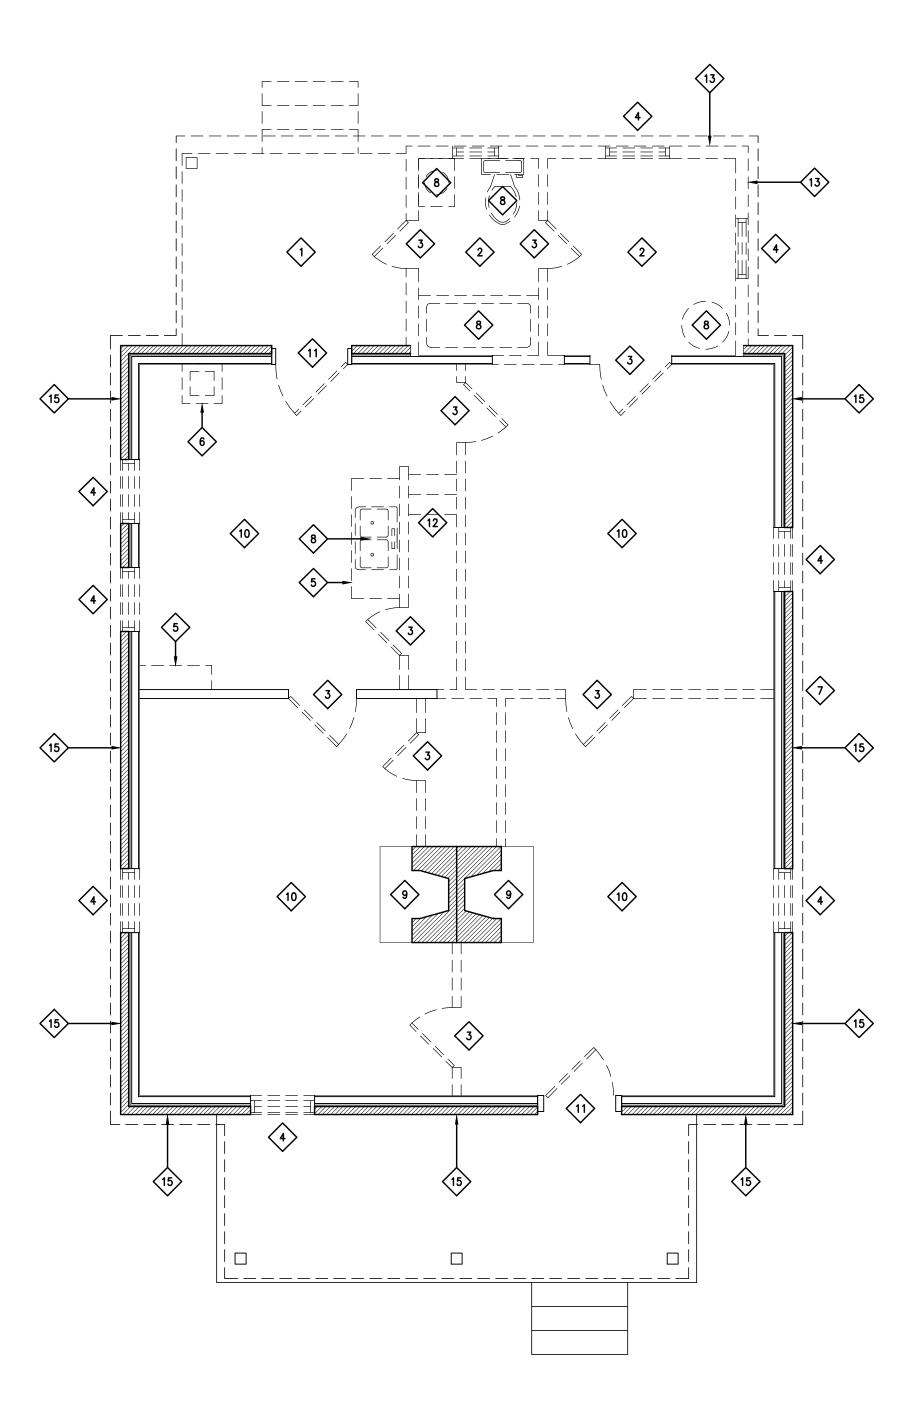

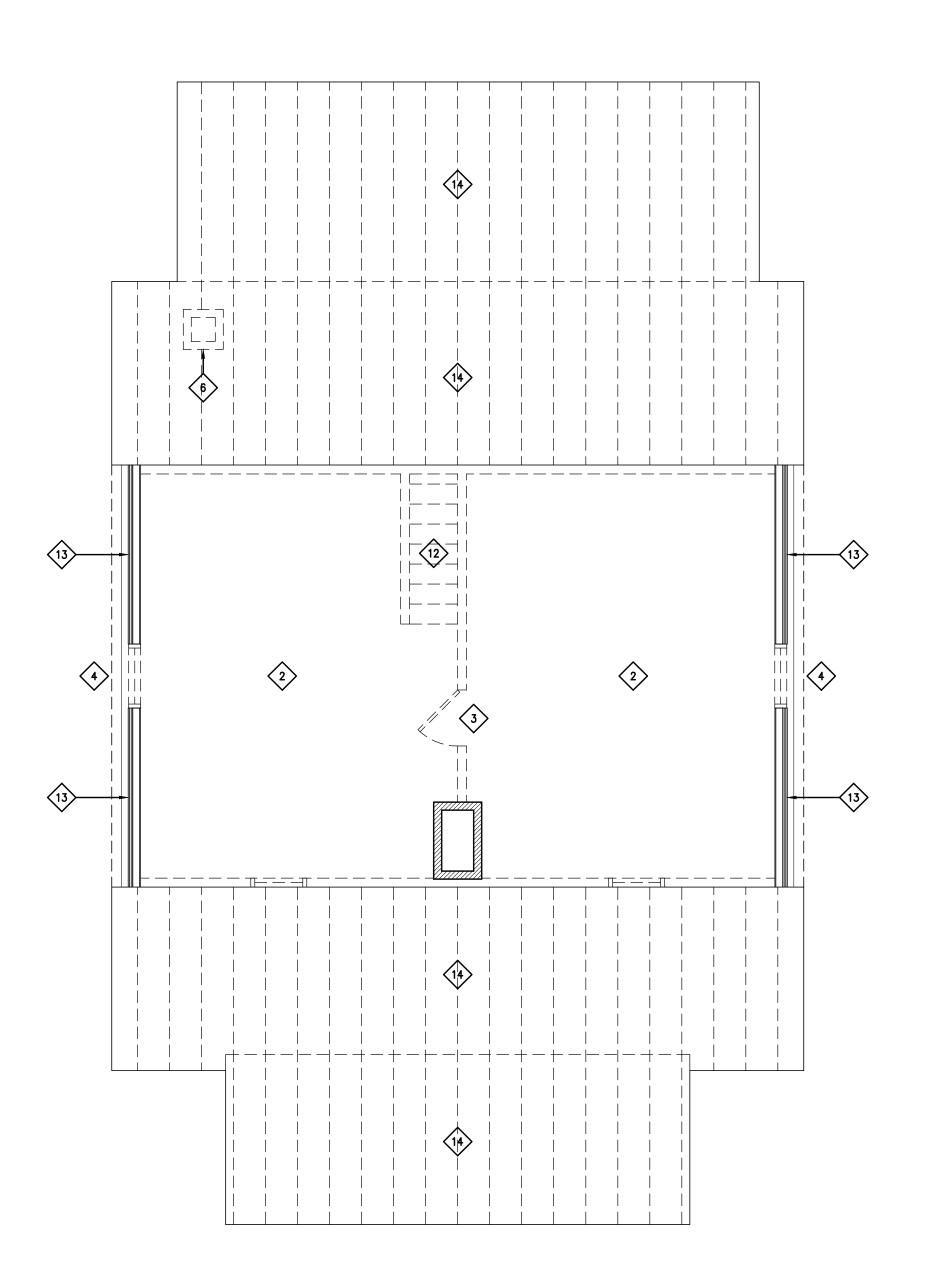

DEMOLITION FLOOR PLAN-FIRST FLOOR

SCALE: 1/4" = 1'-0"



LEGEND

EXISTING DOOR TO REMAIN

EXISTING WALL TO REMAIN

EXISTING DOOR TO BE REMOVED _____ EXISTING WALL TO BE REMOVED

DEMOLITION PLAN GENERAL NOTES

- 1. VERIFY FIELD CONDITIONS PRIOR TO COMMENCEMENT OF EACH PORTION OF WORK. NOTIFY ARCHITECT OF ANY DISCREPANCIES.
- 2. DIMENSIONS ARE TO STRUCTURAL GRID OR TO FINISH SURFACES, UNLESS NOTED OTHERWISE
- 3. WHERE PARTITION DEMOLITION OCCURS, PATCH AND REPAIR ADJACENT CEILINGS AND FLOORING CONDITIONS TO REMAIN FOR A UNIFORM APPEARANCE.
- 4. DO NOT DEMOLISH ANY LOAD BEARING WALLS OR CONSTRUCTION THAT WILL COMPROMISE THE STRUCTURAL INTEGRITY OF THE STRUCTURE. NOTIFY ARCHITECT OF ANY STRUCTURAL ISSUES ARISING FROM DEMOLITION.
- 5. REMOVE AND CAP ALL EXISTING ELECTRICAL CONDUIT/POWER OUTLETS THROUGHOUT PER ELECTRICAL CODE REQUIREMENTS.

DEMOLITION PLAN KEYNOTES

REMOVE EXISTING WOOD DECKING AND JOISTS.

2 REMOVE EXISTING FLOORING, SUB-FLOORING AND JOISTS.

EXISTING ELECTRICAL SERVICE TO BE REMOVED.

REMOVE EXISTING DOOR AND FRAME.

4 REMOVE EXISTING WINDOW.

5 REMOVE EXISTING MILLWORK.

REMOVE EXISTING BRICK CHIMNEY.

×

8 REMOVE EXISTING SINK. MODIFY WASTE, VENT AND WATER AS REQUIRED FOR NEW WORK.

9 EXISTING FIREPLACE TO REMAIN.

10> EXISTING WOOD FLOORS TO BE REMOVED AND RESTORED FOR REINSTALLATION.

EXISTING DOOR TO BE REMOVED AND RESTORED FOR REINSTALLATION.

22 EXISTING STAIRS TO BE REMOVED.

REMOVE EXISTING ASBESTOS SIDING.

REMOVE EXISTING METAL ROOFING.

EXISTING STONE VENEER TO BE REPAIRED AS REQUIRED.

ARCHITECTURE

COF Contract No. 2019-00096

FUSION ARCHITECTURE, PC

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These plans were prepared in this office under our personal supervision, and to the best of our knowledge comply with state and local codes. We will generally administer construction.

PHASE | REVISION DATE | REVISION DATE | REVISION DATE | REVISION DESIGN DESIGN DEVELOPMENT 03.08.201

CONSTRUCTION DOCUMENTS

NATION

JOHN CAROTHERS PROPE HOUSE RESTORATION AND REN HUFFINES RIDGE DRIVE

EXHIBIT

PROJECT NUMBER


03-014-18

SHEET TITLE

DEMO. FLOOR PLAN

SHEET NUMBER

A1.50

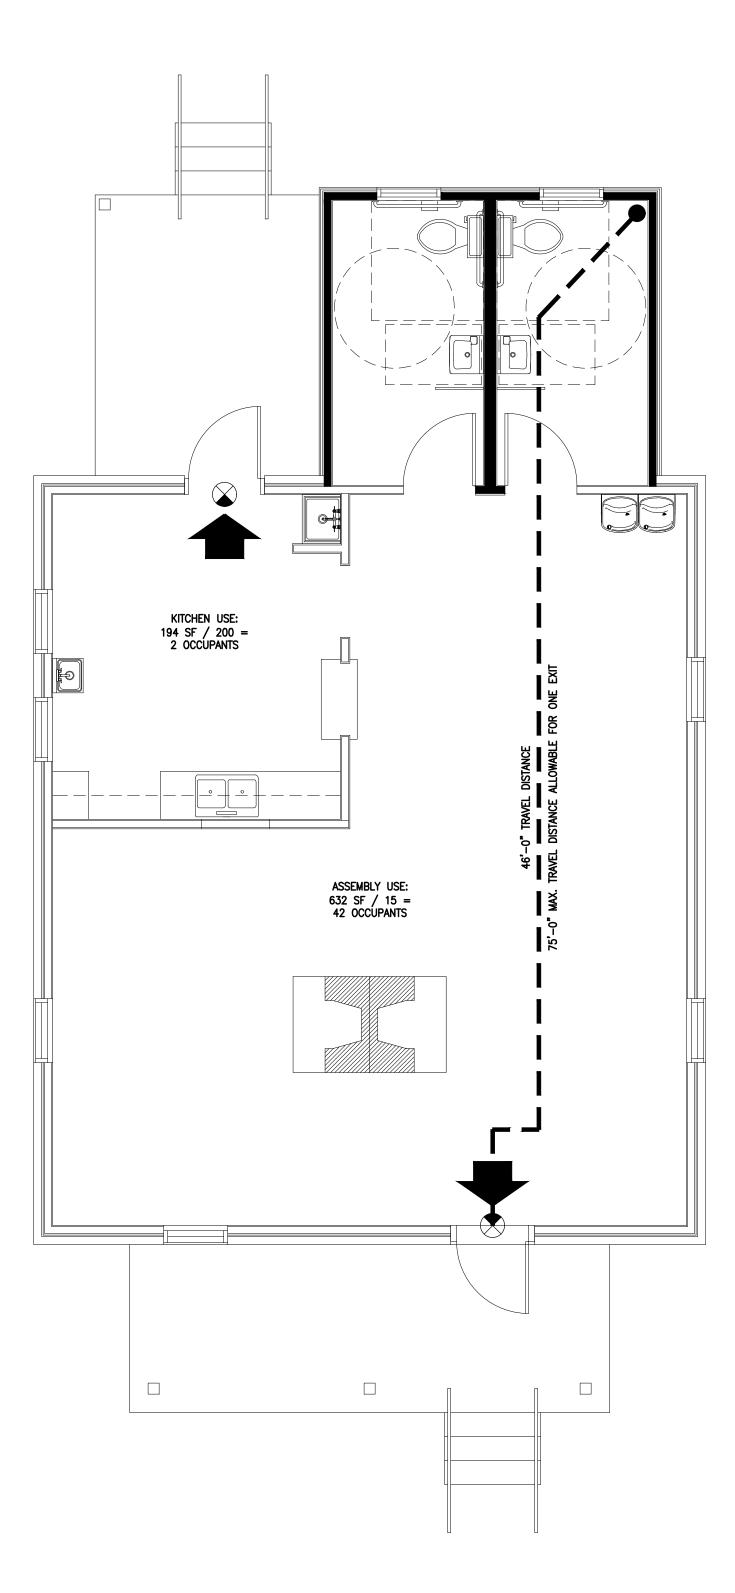



LEGEND:

EXIT ACCESS CORRIDORS

TRAVEL DISTANCE RATED FIRE BARRIER

REQUIRED EXIT (PANIC DEVICE AS NOTED)

FIRE ALARM CONTROL PANEL

FIRE EXTINGUISHER AND CABINET

INDICATES 20 MIN. FIRE RATED DOOR AND FRAME INDICATES 45 MIN. FIRE RATED DOOR AND FRAME

INDICATES 60 MIN. FIRE RATED DOOR AND FRAME

INDICATES SMOKE PARTITION

INDICATES 1/2-HOUR FIRE BARRIER

INDICATES 1-HOUR FIRE BARRIER FIRE ALARM PULL STATION

FIRE ALARM HORN AND STROBE DEVICE EXIT SIGN AND EMERGENCY LIGHT

LIFE SAFETY PLAN GENERAL NOTES:

ALL ROOMS SHALL HAVE SIGNAGE TO COMPLY WITH THE AMERICANS WITH DISABILITIES ACT AS

PROVIDE 2A-10B-C FIRE EXTINGUISHERS AS SHOWN ON PLANS. (REFER TO FLOOR PLAN SYMBOL FOR PROPER LOCATION OF NEW EXTINGUISHERS) TOP OF EXTINGUISHERS SHALL BE MOUNTED © 60" AFF (FOR EXTINGUISHERS WEIGHING LESS THAN 40 LBS.) (LAC: 55V: 303D / NFPA 10) NEW EXTINGUISHER CABINETS SHALL BE SEMI—RECESSED.

4. REFERENCE ELECTRICAL DRAWINGS FOR ALL EMERGENCY AND REQUIRED EXIT LIGHTING.

5. 101:6.2.2.3 CONTENTS OF THIS BUILDING SHALL BE CLASSIFIED AS ORDINARY HAZARD.

FUSION

COF Contract No. 2019-00096

FUSION ARCHITECTURE, PC

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PHASE | REVISION SCHEMATIC DESIGN DESIGN DEVELOPMENT

CONSTRUCTION DOCUMENTS

HUFFINES RIDGE DRIVE FRANKLIN, TENNESSEE 3706 JOHN CAROTHERS PROF HOUSE RESTORATION AND RE

BUILDING AREA-OCCUPANT LOAD:

TOTAL BUILDING AREA: ASSEMBLY OCCUPANCY AREA: STORAGE OCCUPANCY AREA:

TOTAL OCCUPANT LOAD:

1,015 SF 632 SF / 15 = 42 OCCUPANTS 194 SF / 200 = 2 OCCUPANTS

44 OCCUPANTS

REQUIRED EXIT WIDTH:

NFPA 101, LIFE SAFETY CODE (2018 EDITION): TABLE 7.3.3.1:

44 OCCUPANTS (0.2) = 8.8 INCHES 72 INCHES PROVIDED

REQUIRED SEPARATIONS:

NFPA 101 (2018 EDITION), BUSINESS OCCUPANCY (CHAPTER 38):
NONE.
IBC (2018 EDITION)
NONE.

PROTECTION FROM HAZARDS:

NFPA 101 (2018 EDITION) NONE

IBC (2018 EDITION) TABLE 509 NONE

PROTECTION OF EXIT ACCESS CORRIDORS:

NFPA 101 (2018 EDITION) NONE

IBC (2018 EDITION) TABLE 1018.1 NONE

EXHIBIT


PROJECT NUMBER


03-014-18

SHEET TITLE

LIFE SAFETY PLAN

SHEET NUMBER A2.00

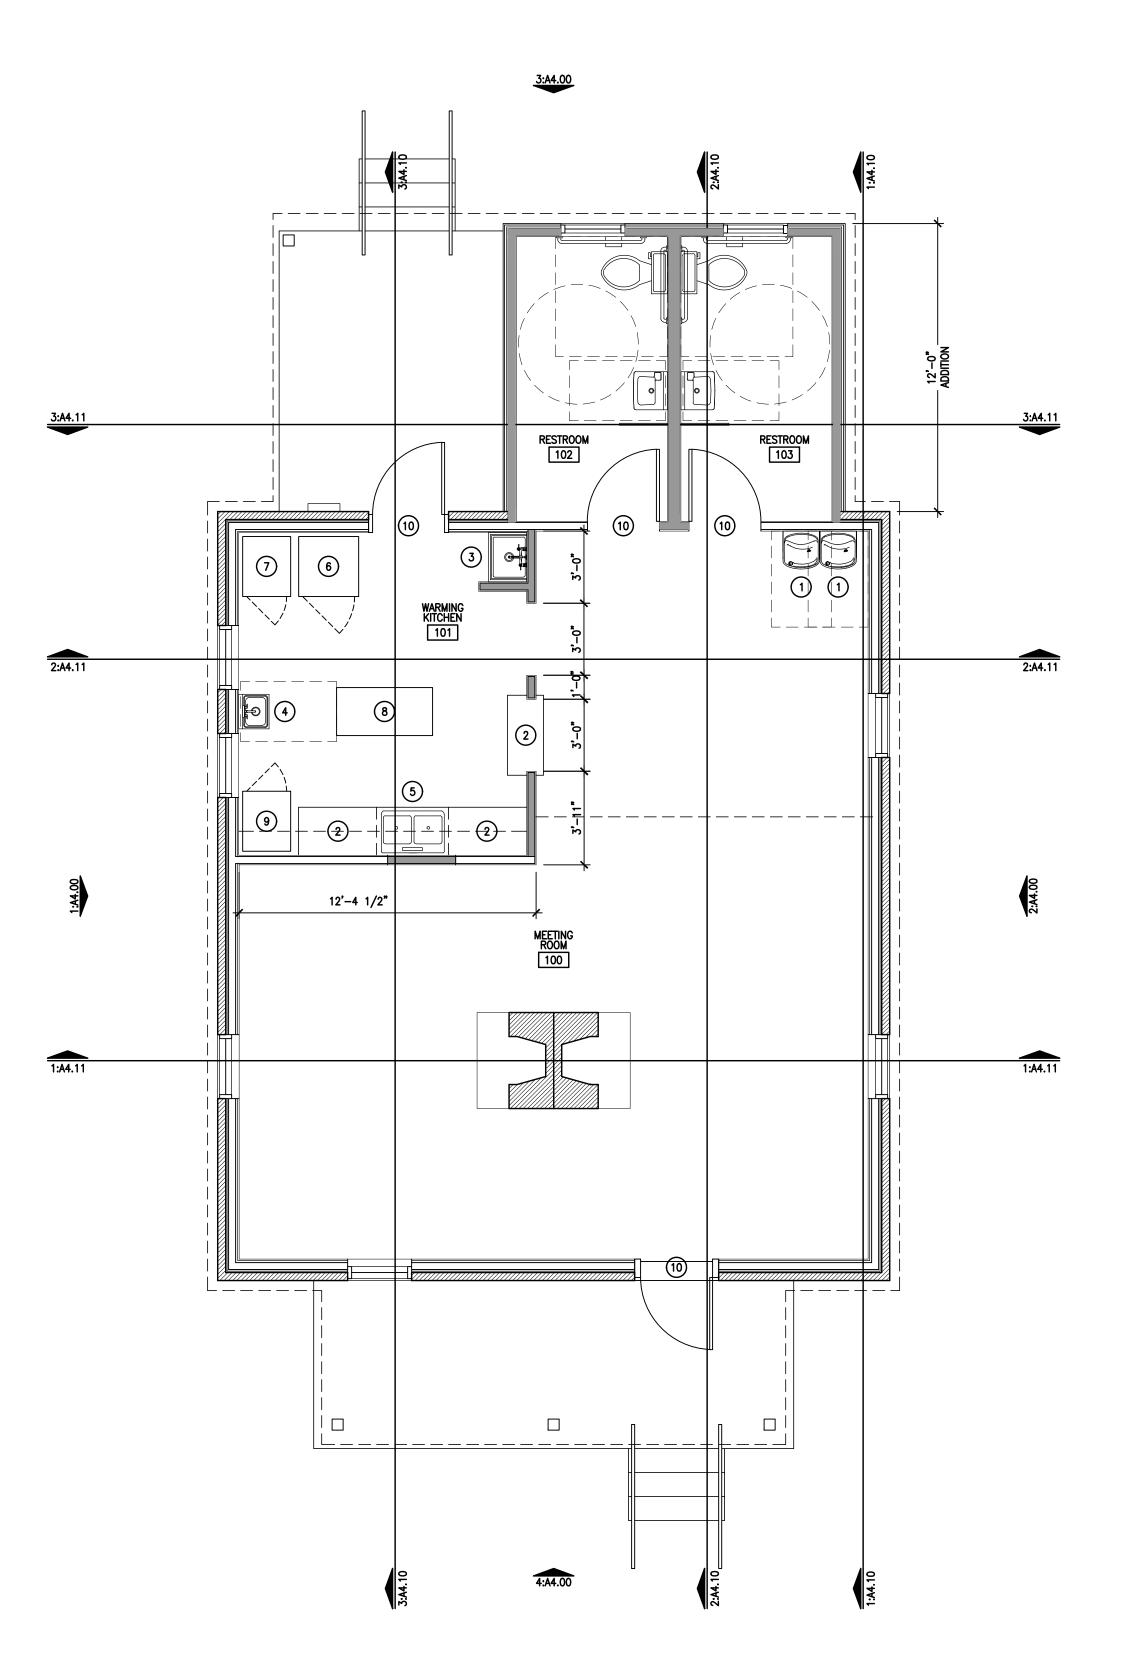

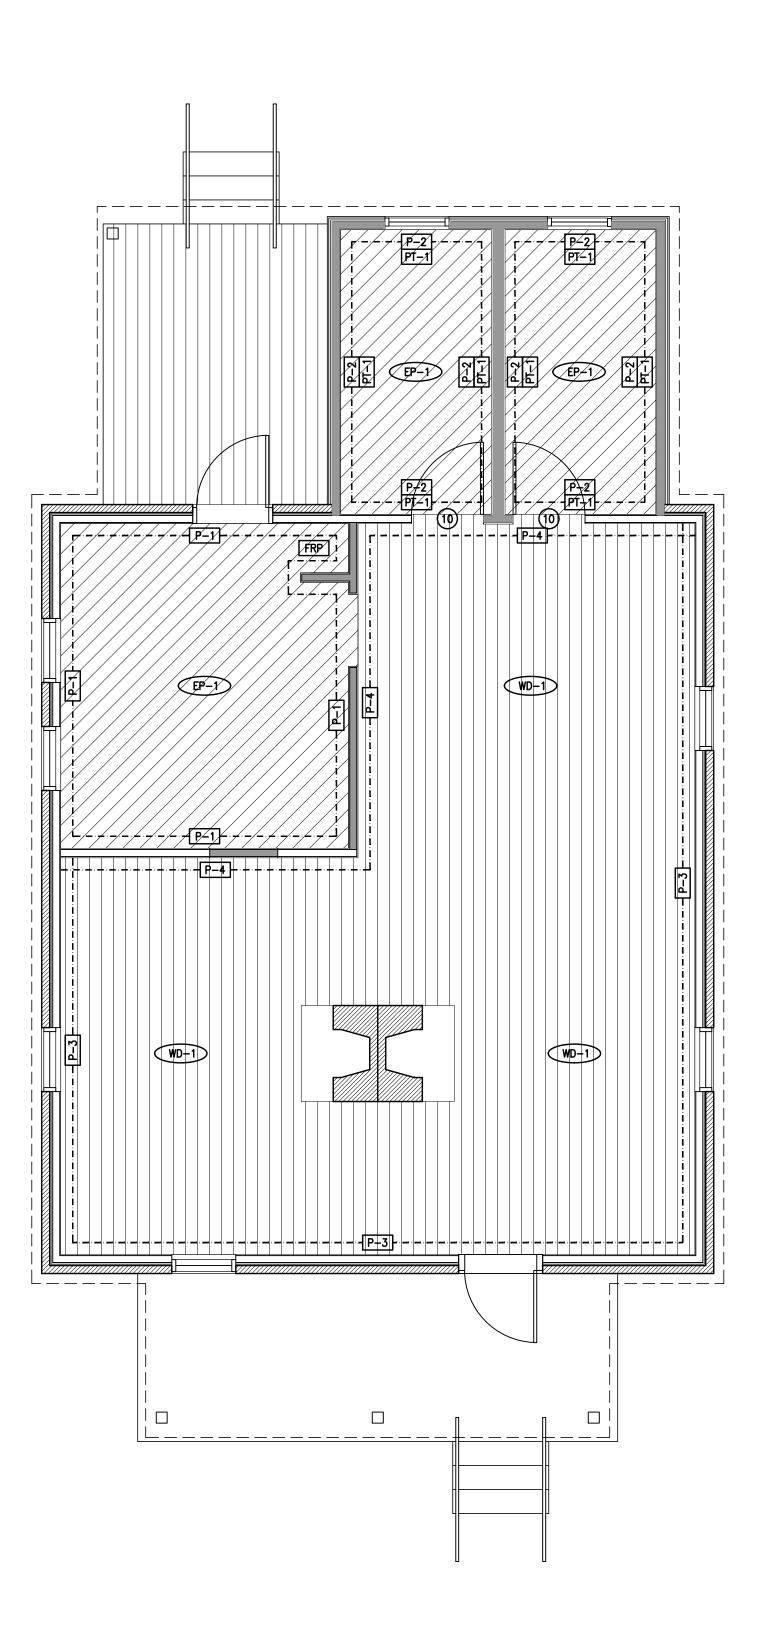





LEGEND

EXISTING WALL TO REMAIN

NEW WALL AS SCHEDULED

FLOOR PLAN GENERAL NOTES

- 1. INTERIOR FINISHES SHALL COMPLY WITH NFPA 101:36.3.3 (0-75) FLAMESPREAD WITH SMOKE DEVELOPMENT OF (0-450).
- 2. LOOSELY HANGING FURNISHINGS AND DECORATIONS SHALL BE FLAME RESISTANT AS DEMONSTRATED BY TESTING IN ACCORDANCE WITH NFPA 701.
- 3. ALL DIMENSIONS, UNLESS NOTED OTHERWISE, ARE TAKEN FROM FACE OF FRAMING. 4. INSULATION ASSEMBLIES SHALL MEET THE REQUIREMENTS OF SECTION 708, INTERNATIONAL BUILDING CODE, 2012 EDITION.

FLOOR PLAN KEYNOTES

- 1 ADAAG DRINKING FOUNTAIN.
- 2 MILLWORK AS SCHEDULED.

- DOUBLE SINK.
- REFRIGERATOR. WARMING OVEN.
- FREEZER.
- 10 NEW DOOR.

FINISH PLAN LEGEND

DURAQUARTZ EPOXY FLOOR SYSTEM

WD-1 STAINED WOOD FLOORING

---- P-1 ---- PAINTED GYPSUM BOARD

---- PAINTED GYPSUM BOARD

PAINTED GYPSUM BOARD ---- P-4 ---- PAINTED GYPSUM BOARD

FRP ---- FIBERGLASS REINFORCED PANELS: WHITE

— PT-1 — PORCELAIN TILE AND EPOXY GROUT

FINISH PLAN GENERAL NOTES

- INTERIOR FINISHES SHALL COMPLY WITH NFPA 101:36.3.3 (0-75) FLAMESPREAD WITH SMOKE DEVELOPMENT OF (0-450).
- 2. INTERIOR FLOOR FINISHES SHALL COMPLY WITH NFPA 101 18.3.3.3.
- LOOSELY HANGING FURNISHINGS AND DECORATIONS SHALL BE FLAME RESISTANT AS DEMONSTRATED BY
- TESTING IN ACCORDANCE WITH NFPA 701.
- 4. ALL DIMENSIONS, UNLESS NOTED OTHERWISE, ARE TAKEN FROM FACE OF FRAMING.
- INSULATION ASSEMBLIES SHALL MEET THE REQUIREMENTS OF SECTION 708, INTERNATIONAL BUILDING CODE, 2012 EDITION.
- PROVIDE TRANSITION STRIPS AS PER MANUFACTURER'S RECOMMENDATION AT ALL DISSIMILAR FINISH ABUTMENTS AND THRESHOLDS.

EXHIBIT

PROJECT NUMBER

03-014-18

SHEET TITLE

ARCH. FLOOR PLAN

SHEET NUMBER

A2.10


COF Contract No. 2019-00096 FUSION FUSION ARCHITECTURE, PC 116 MAJESTIC LANE FRANKLIN, TENNESSEE 37064 V: 615.454.3916 W: FUSIONARCHITECTURE.COM


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PHASE | REVISION SCHEMATIC DESIGN DESIGN DEVELOPMENT CONSTRUCTION DOCUMENTS

JOHN CAROTHERS PROF HOUSE RESTORATION AND RE



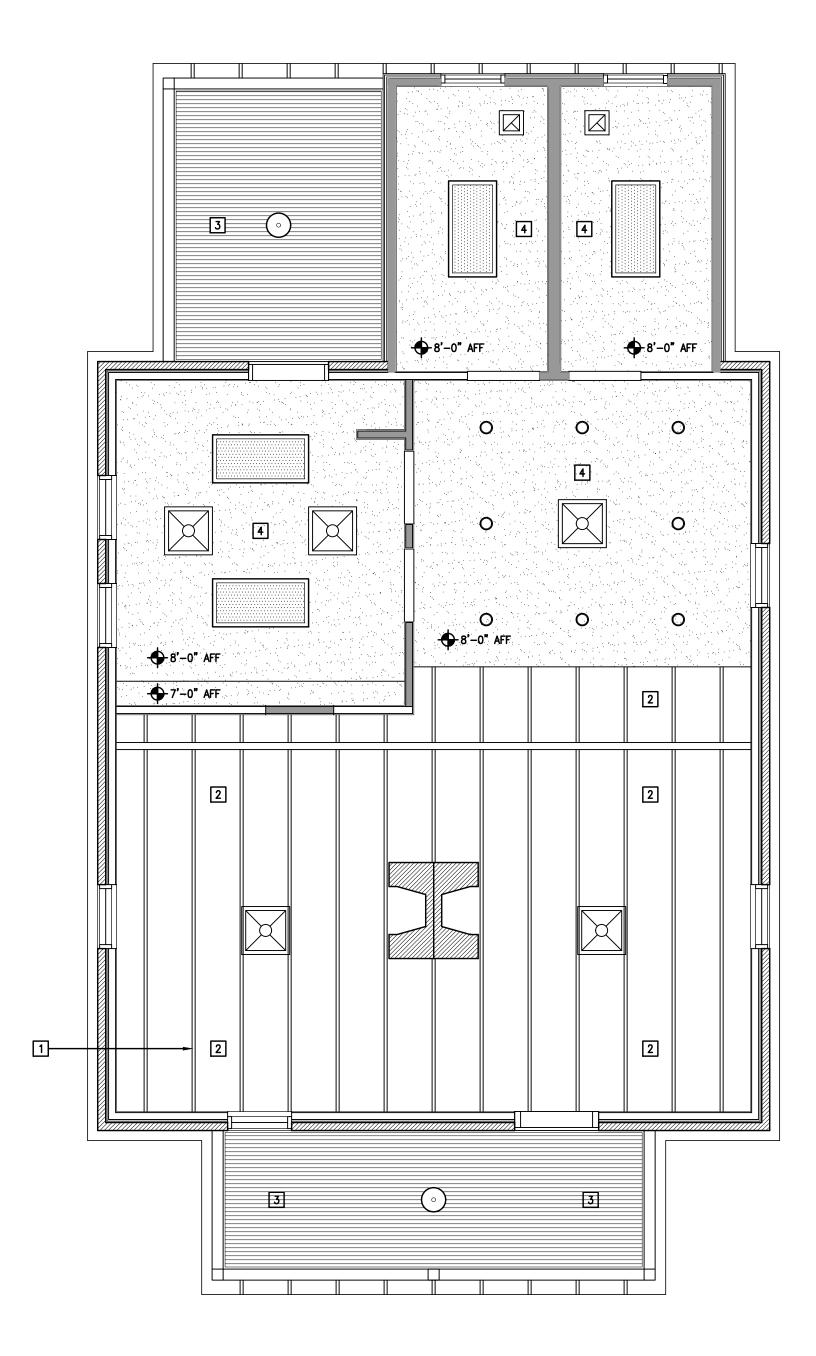

ARCHITECTURAL CEILING PLAN

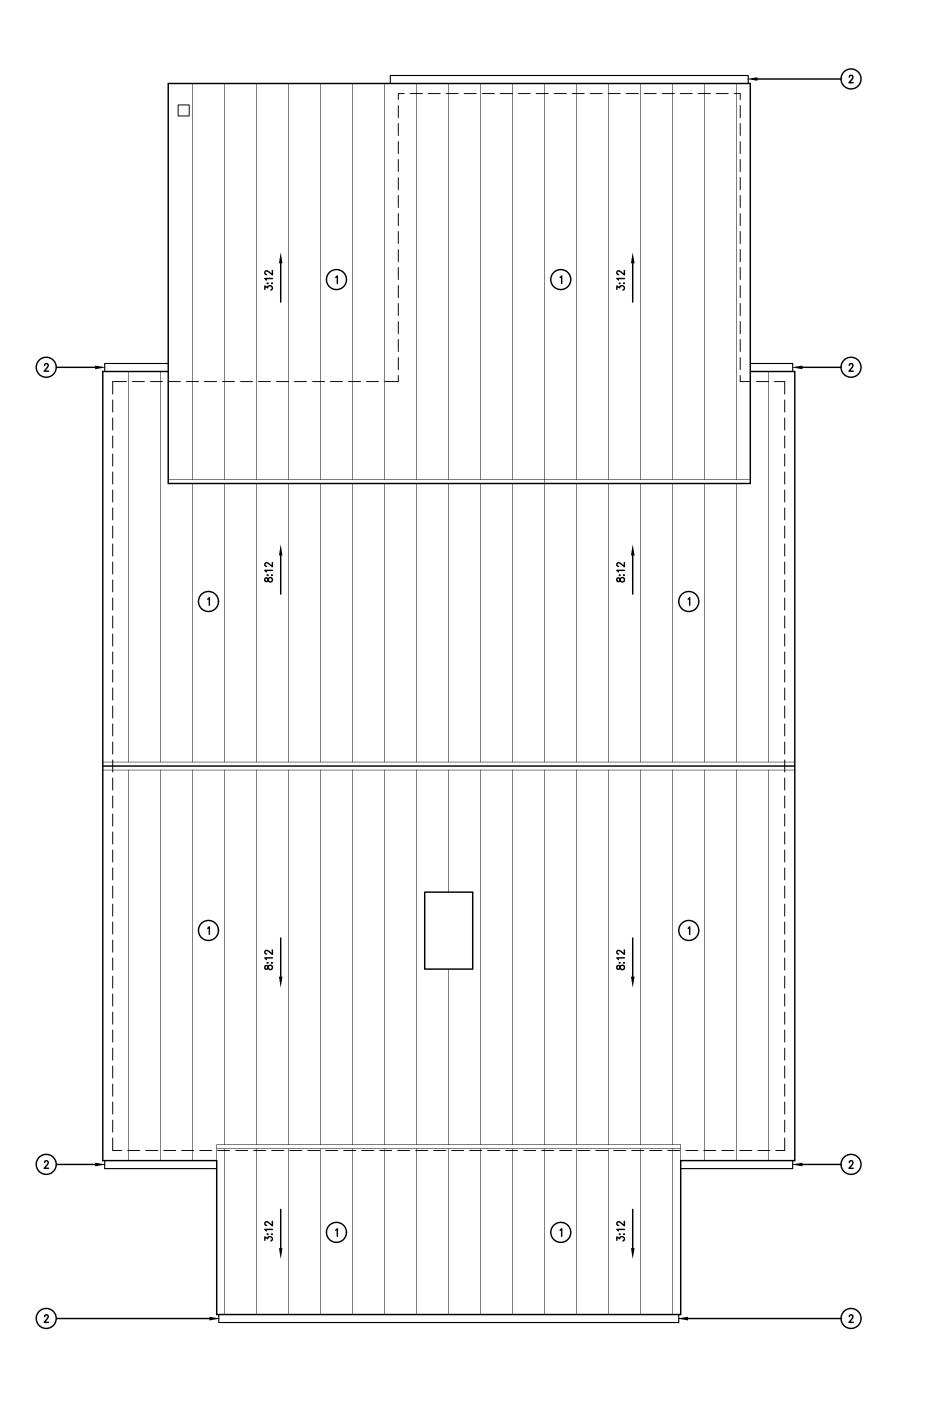A2.20 SCALE: 1/4" = 1'-0"



LEGEND

GYP-1

PAINTED GYPSUM BOARD:



2'-0"x2'-0" SUPPLY DIFFUSER (RE: MECHANICAL)



2'-0"x2'-0" RETURN AIR GRILLE (RE: MECHANICAL)



2'-0" x 2'-0" FLUORESCENT LIGHT WITH ACRYLIC LENS (RE: ELECTRICAL)




2'-0" x 4'-0" FLUORESCENT LIGHT WITH ACRYLIC LENS (RE: ELECTRICAL)





EXIT LIGHT (RE: ELECTRICAL)

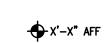

ELEVATION INDICATES CLEAR HEIGHT FROM FINISHED FLOOR TO FINISHED CEILING. ALL CEILING HEIGHTS = 9'-0" U.N.O.

CEILING PLAN GENERAL NOTES

1. REFER TO ELECTRICAL DRAWINGS FOR EXIT LIGHTING.

- 2. REFER TO ELECTRICAL DRAWINGS FOR ALL FIXTURE TYPES AND DESCRIPTIONS. SEE ELECTRICAL PLANS/ SPECIFICATIONS FOR ADDITIONAL ITEMS INCLUDING, BUT NOT LIMITED TO: LIGHT FIXTURE TYPES, SWITCHING, EXIT SIGNAGE, AND SECURITY LIGHTING.
- ACOUSTICAL CEILING TILE GRID LAYOUT SHOWN IS ARCHITECTS INSTALLATION INTENT. NOTIFY ARCHITECT IMMEDIATELY OF ANY CONFLICTS IN THE FIELD.
- . REFER TO FINISH SCHEDULE FOR ALL CEILING HEIGHTS NOT INDICATED AND ADDITIONAL CEILING MATERIAL INFORMATION.
- 5. SEE ARCHITECT'S SPECIFICATIONS FOR MATERIAL INFORMATION.
- 6. CONTRACTOR SHALL REUSE AS MANY EXISTING LIGHTS AS POSSIBLE.
- 7. ALL NEW HVAC GRILLES SHALL BE PAINTED TO MATCH CEILING TILE AND/OR PAINTED GYPSUM BOARD CEILINGS AS SCHEDULED.

CEILING PLAN KEYNOTES

1 2x WOOD JOISTS

2 OPEN TO ROOF DECK PAINTED BEAD BOARD CEILING

4 PAINTED GYPSUM BOARD CEILING

ROOF PLAN KEYNOTES

PRE-FINISHED STANDING SEAM METAL ROOFING 2 PRE-FINISHED METAL GUTTER

FUSION FUSION ARCHITECTURE, PC

COF Contract No. 2019-00096

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PHASE | REVISION SCHEMATIC DESIGN

DESIGN DEVELOPMENT CONSTRUCTION DOCUMENTS

JOHN CAROTHERS PROPERTY HOUSE RESTORATION AND RENOVATIO

HUFFINES RIDGE DRIVE FRANKLIN, TENNESSEE 3706

EXHIBIT

PROJECT NUMBER

03-014-18

SHEET TITLE

ARCH. FLOOR PLAN

SHEET NUMBER

A2.20

COF Contract No. 2019-00096

- 1x6 PAINTED WOOD SIDING

- PRE—FINISHED STANDING SEAM METAL ROOFING

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PHASE | REVISION

SCHEMATIC DESIGN DESIGN DEVELOPMENT CONSTRUCTION DOCUMENTS

> JOHN CAROTHERS PROPERTY
> HOUSE RESTORATION AND RENOVATION HUFFINES RIDGE DRIVE FRANKLIN, TENNESSEE 37067

EXHIBIT


PROJECT NUMBER

03-014-18

SHEET TITLE


ARCH. FLOOR PLAN

SHEET NUMBER A4.00

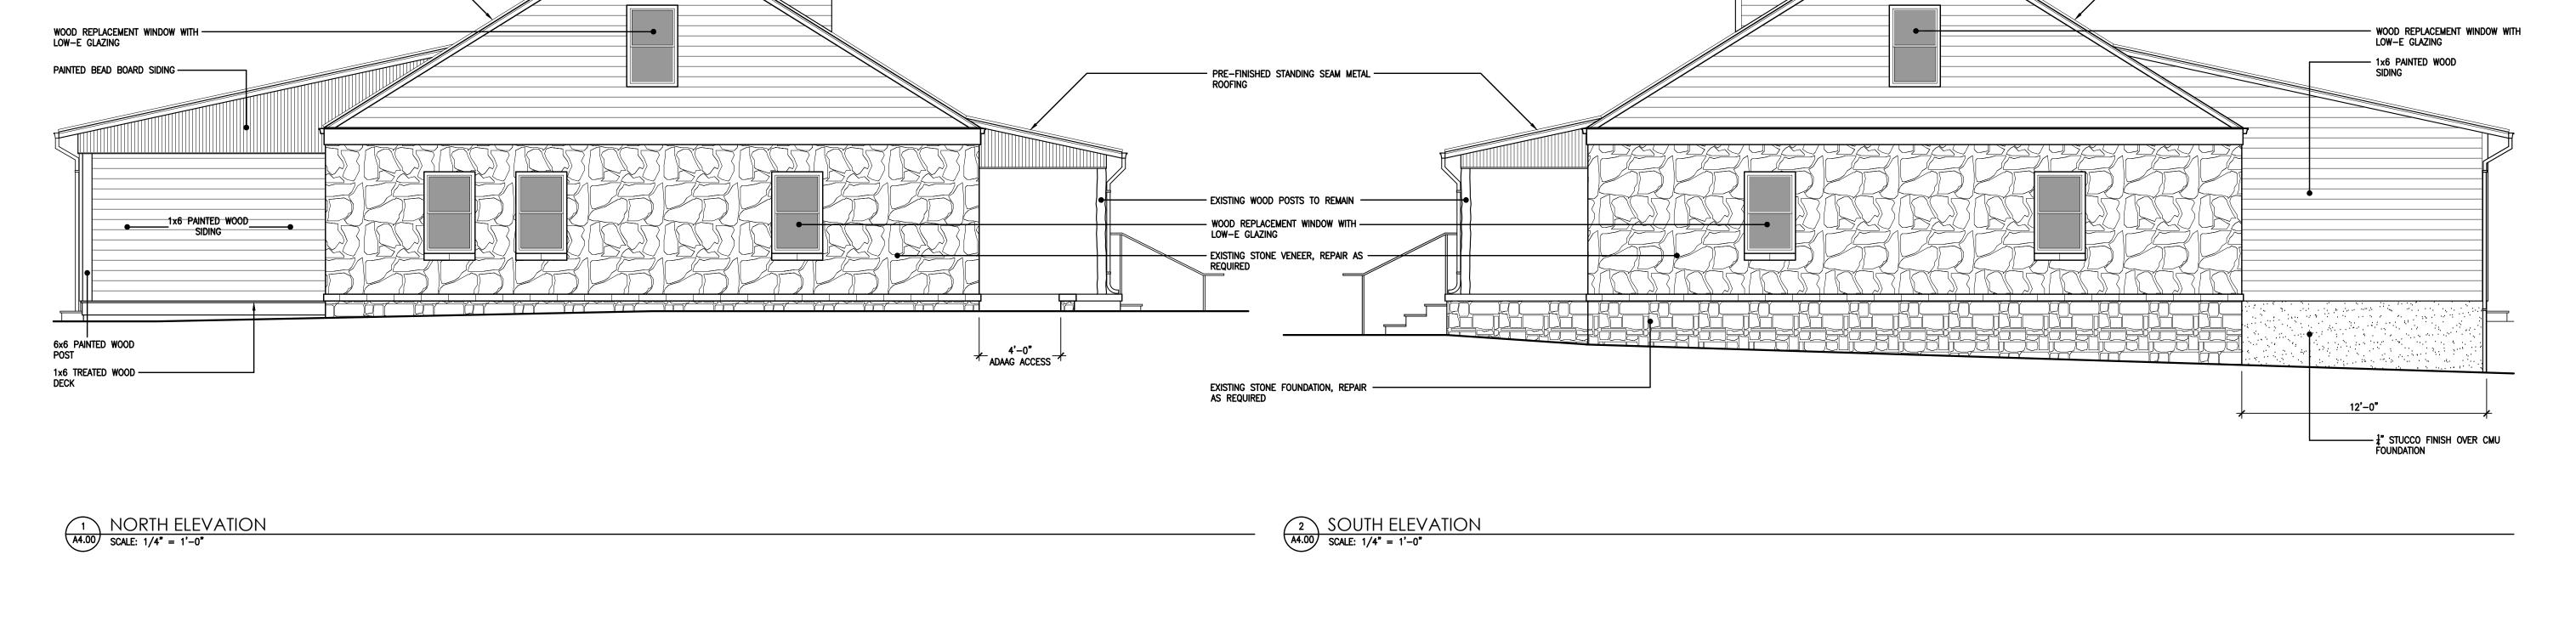

EXISTING STONE CHIMNEY, REPAIR AS -REQUIRED

- 1x6 Painted wood siding -

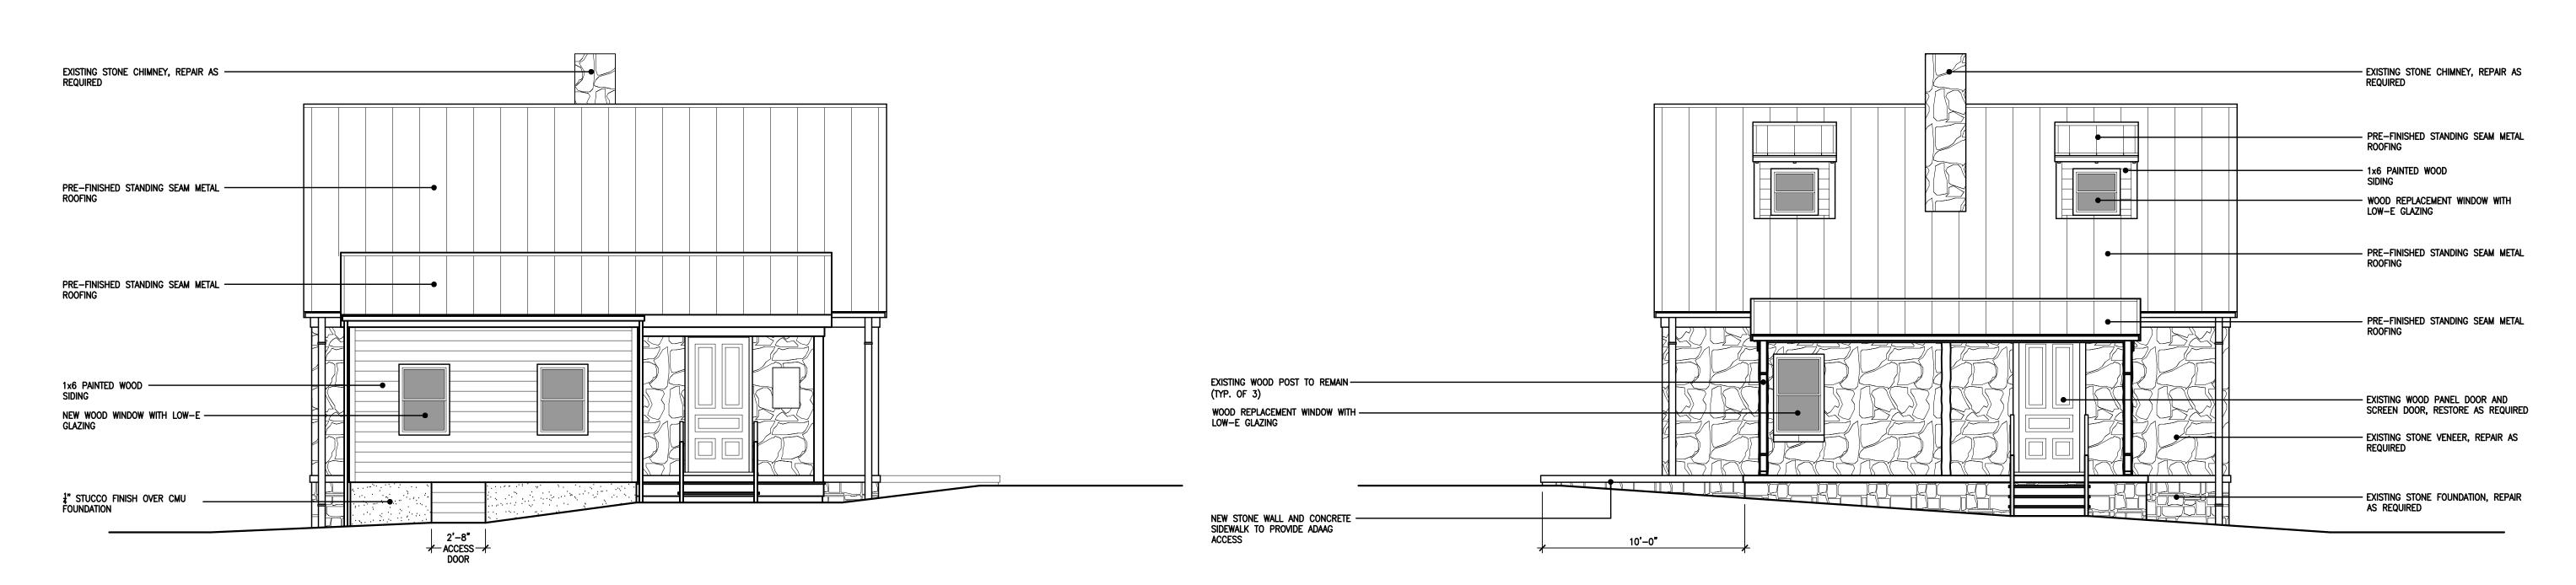

3 EAST ELEVATION
A4.00 SCALE: 1/4" = 1'-0"

1x6 PAINTED WOOD -

PRE-FINISHED STANDING SEAM METAL - ROOFING

4 WEST ELEVATION
A4.00 SCALE: 1/4" = 1'-0"

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By:

PHASE | REVISION DATE

SCHEMATIC DESIGN 01.11.2019

DESIGN DEVELOPMENT 03.08.2019

CONSTRUCTION DOCUMENTS

DESIGN DEVELOPMENT 03.08

CONSTRUCTION DOCUMENTS

JOHN CAROTHERS PROPERTY
HOUSE RESTORATION AND RENOVATION
HUFFINES RIDGE DRIVE
FRANKLIN, TENNESSEE 37067

EXHIBIT

PROJECT NUMBER


03-014-18

SHEET TITLE

BUILDING SECTIONS

SHEET NUMBER

A4.10

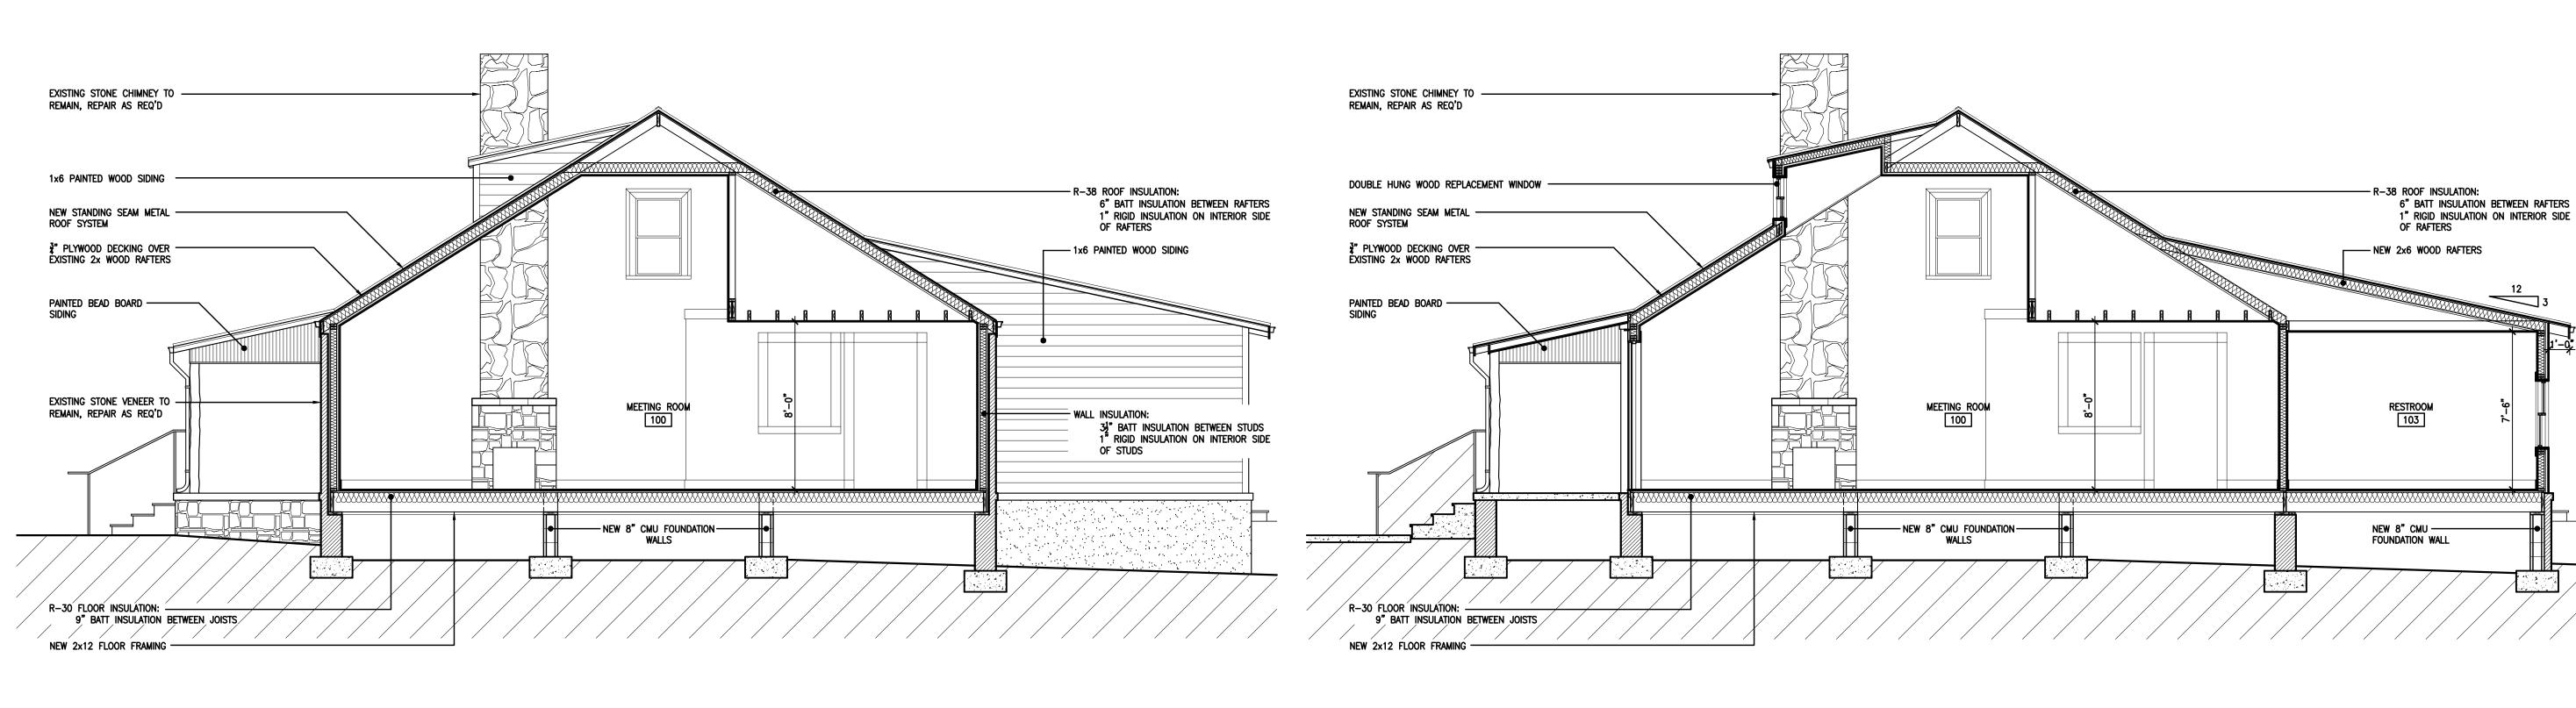


BUILDING SECTION

A4.10 SCALE: 1/4" = 1'-0"

BUILDING SECTION

SCALE: 1/4" = 1'-0"

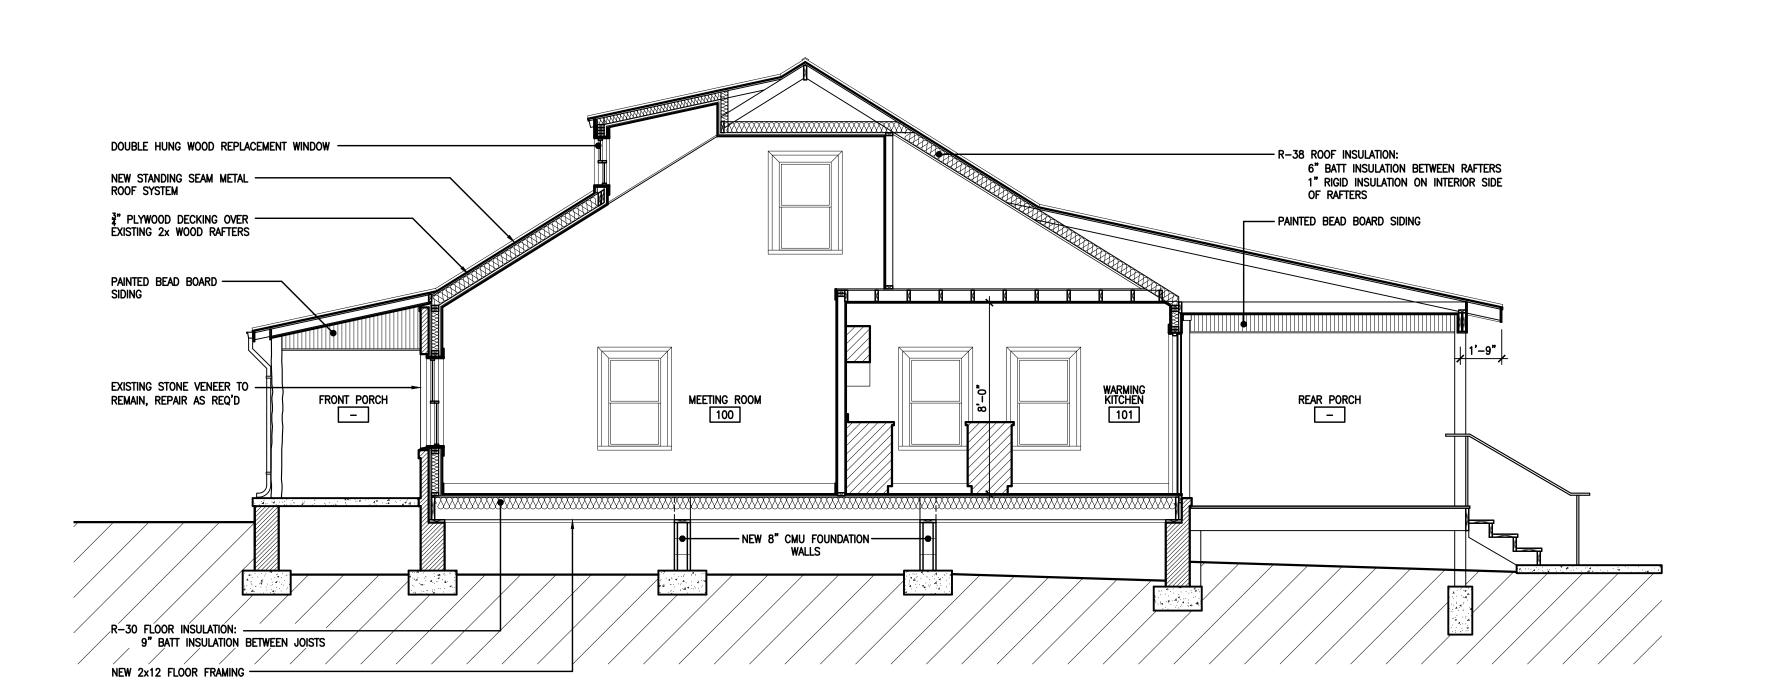

BUILDING SECTION

A4.10 SCALE: 1/4" = 1'-0"


NEW STANDING SEAM METAL — ROOF SYSTEM - R-38 ROOF INSULATION: 6" BATT INSULATION BETWEEN RAFTERS 1x6 PAINTED WOOD SIDING -1" RIGID INSULATION ON INTERIOR SIDE WALL INSULATION: of rafters 3½" BATT INSULATION BETWEEN STUDS 1" RIGID INSULATION ON INTERIOR SIDE 1x12 PAINTED WOOD TRIM -WARMING KITCHEN MEETING ROOM 100 DOUBLE HUNG WOOD REPLACEMENT WINDOW -EXISTING STONE VENEER TO REMAIN -EXISTING STONE FOUNDATION TO REMAIN . R-30 FLOOR INSULATION: -9" BATT INSULATION BETWEEN JOISTS / NEW 2x12 FLOOR FRAMING -

BUILDING SECTION

A4.11) SCALE: 1/4" = 1'-0"

BUILDING SECTION

A4.11 SCALE: 1/4" = 1'-0"

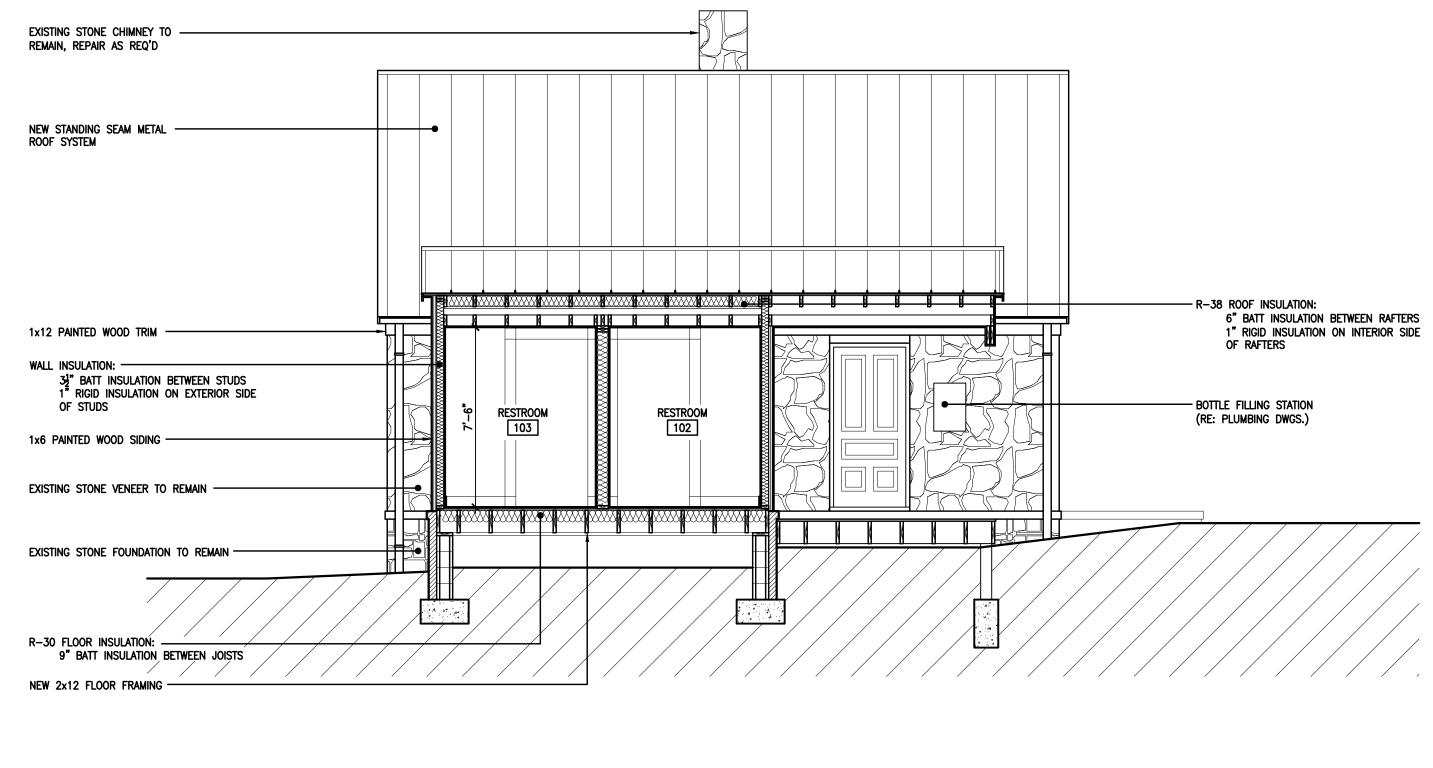

BUILDING SECTION

A4.11 SCALE: 1/4" = 1'-0"

COF Contract No. 2019-00096



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> PHASE | REVISION SCHEMATIC DESIGN DESIGN DEVELOPMENT CONSTRUCTION DOCUMENTS

JOHN CAROTHERS PROPERTY
HOUSE RESTORATION AND RENOVATION

EXHIBIT

PROJECT NUMBER

03-014-18

SHEET TITLE

BUILDING SECTIONS

SHEET NUMBER

A4.1

DESIGN DEVELOPMENT

JOHN CAROTHERS PROPERTY MAINTENANCE BUILDING

HUFFINES RIDGE DRIVE FRANKLIN, TENNESSEE 37067

	INDEX OF D	DRAWINGS:		This drawing is the pand is not to be repart. It is only to specifically identifie Scales as stated drawing only.
	GENERAL (2) G1.00			These plans were personal supervision comply with state administer constructions. By: PHASE REVISION SCHEMATIC DESIGN DEVELOF CONSTRUCTION IN CONSTRUCTION
GENERAL NOTES:	PROJECT INFORMATION:	APPLICABLE BUILDING CODES AND STANDARDS:	VICINITY MAP:	OPERTY
 THE GENERAL CONTRACTOR IS RESPONSIBLE TO SUPPLY ALL SUBCONTRACTORS WITH CONSTRUCTION DRAWINGS AND SPECIFICATIONS NECESSARY TO BID AND/OR CONSTRUCT THIS PROJECT. ALL DIMENSIONS ON THE FLOOR PLANS, UNLESS OTHERWISE NOTED, ARE TAKEN FROM FACES OF STUDS OF EXTERIOR WALLS AND INTERIOR WALLS. THE OWNER SHALL BE RESPONSIBLE FOR NOTIFYING THE GENERAL CONTRACTOR OF ANY ADDITIONAL ITEMS TO BE INSTALLED THAT ARE NOT SHOWN ON THE DRAWINGS. ANY PENETRATIONS OF, OR MODIFICATIONS TO CONCRETE MUST BE COORDINATED WITH ARCHITECT PRIOR TO CONSTRUCTION. IN ACCORDANCE WITH GENERALLY ACCEPTED CONSTRUCTION PRACTICES, THE CONTRACTOR WILL BE SOLELY AND COMPLETELY RESPONSIBLE FOR CONDITIONS OF THE JOB SITE, INCLUDING SAFETY OF ALL PERSONS AND PROPERTY DURING PERFORMANCE OF WORK, THIS REQUIREMENT WILL APPLY CONTINUOUSLY AND SHALL NOT BE LIMITED TO NORMAL WORKING HOURS. THE CONTRACTOR SHALL TAKE ALL NECESSARY PRECAUTIONS TO INSURE THE SAFETY OF THE PUBLIC AND/OR WORK PERSONS ON THE JOB AND TO PREVENT ACCIDENTS OR INJURY TO ANY PERSON ON, ABOUT OF ADJACENT TO THE PREMISES. THE CONTRACTOR SHALL COMPLY WITH ALL LAWS, ORDINANCES, CODES, RULES AND REGULATIONS RELATIVE TO SAFETY AND THE PREVENTION OF ACCIDENTS. WHETHER OR NOT SPECIFICALLY INDICATED ON THE DRAWINGS, ALL CONTRACTORS SHALL BE RESPONSIBLE FOR REMOVING OR DEMOLISHING EXISTING CONSTRUCTION (INCLUDING UTILITIES) WHICH WILL INTERFERE WITH NEW WORK. PRIOR TO THE SHUT—DOWN OR TYING INTO ANY UTILITY, APPROVAL SHALL BE OBTAINED FROM THE OWNER'S REPRESENTATIVE. COORDINATE WITH OWNER'S REPRESENTATIVE, LOCATION OF CONTRACTORS' EQUIPMENT AND MATERIAL STORAGE. 	OCCUPANCY CLASSIFICATION: IBC: STORAGE: GROUP S-1 NFPA: NEW STORAGE: - CHAPTER 42 TYPE OF CONSTRUCTION: IBC: TYPE V (B) NFPA: TYPE V (000) ALLOWABLE NO. OF STORIES: 1 NO. OF STORIES: 1 ALLOWABLE BUILDING HEIGHT: 40'-0" BUILDING HEIGHT: 14'-10" ALLOWABLE BUILDING AREA: 9,000 S.F. BUILDING AREA: 576 S.F.	2018 INTERNATIONAL BUILDING CODE INCLUDING APPENDICES D, G AND K 2018 INTERNATIONAL ENERGY CONSERVATION CODE (FOR BUILDINGS REVIEWED UNDER THE IBC) 2018 INTERNATIONAL FIRE CODE INCLUDING APPENDICES B, C AND D 2018 INTERNATIONAL ELECTRIC CODE 2018 INTERNATIONAL ELECHANICAL CODE 2018 INTERNATIONAL FULL GAS CODE 2018 INTERNATIONAL FULL GAS CODE 2017 ICC A 117.1 ACCESSIBLE AND USEABLE BUILDINGS AND FACILITIES 2018 INTERNATIONAL EXISTING BUILDING CODE 2018 INTERNATIONAL EXISTING BUILDING CODE 2018 INTERNATIONAL RESIDENTIAL CODE INCLUDING APPENDICES G AND J 2009 INTERNATIONAL ENERGY CONSERVATION CODE (FOR BUILDINGS REVIEWED UNDER THE IRC) 2018 INTERNATIONAL SWIMMING POOL AND SPA CODE		JOHN CAROTHERS PR
 9. ALL MECHANICAL WORK SHALL BE PERFORMED BY A LICENSED MECHANICAL CONTRACTOR AND IN ACCORDANCE WITH ALL APPLICABLE CODES AND STANDARDS. 10. ALL PLUMBING WORK SHALL BE PERFORMED BY A LICENSED PLUMBING CONTRACTOR ALL IN ACCORDANCE WITH ALL APPLICABLE CODES AND STANDARDS. 11. ALL ELECTRICAL WORK SHALL BE PERFORMED BY A LICENSED ELECTRICAL CONTRACTOR AND IN ACCORDANCE WITH ALL APPLICABLE CODES AND STANDARDS. 12. ALL STRUCTURAL FRAMING WORK SHALL BE PERFORMED IN ACCORDANCE WITH ALL APPLICABLE CODES AND STANDARDS. 	PROJECT DESCRIPTION: THIS PROJECT INVOLVES THE CONSTRUCTION OF A NEW MAINTENANCE BUILDING FOR THE PARKS DEPARTMENT. THIS BUILDING SHALL INCLUDE A RESTROOM, FURNITURE STORAGE AND EQUIPMENT STORAGE AREAS.	PROFESSIONAL OF RECORD: ARCHITECT: FUSION ARCHITECTURE, PC 116 MAJESTIC LANE FRANKLIN, TENNESSEE 37064 VOICE: 615.454.3916 CONTACT: KYLE M. KRAMER, ARCHITECT EMAIL: kkramer@fusionarchitecture.com	Google	-EX
SYMBOLS LEGEND:	CONSU	JLTANTS:	PROJECT SITE JOHN CAROTHERS HOUSE HUFFINES RIDGE DRIVE FRANKLIN, TENNESSEE 37067 HATCH LEGEND:	
XXX ROOM NUMBER DETAIL TAG X KEY NOTE			PLAN: SPANDREL GLASS INSULATION	PROJECT NUM 03-014-1 SHEET TITLE TITLE SHE SHEET NUMBER G 1.

FUSION ARCHITECTURE, PC


116 MAJESTIC LANE FRANKLIN, TENNESSEE 37064 V: 615.454.3916 W: FUSIONARCHITECTURE.COM

1. DETAILS AND NOTES ON THIS SHEET SHALL GOVERN STANDARD DIMENSIONS ,CLEARANCES, AND MOUNTING LOCATIONS. CONTRACTOR SHALL IMMEDIATELY BRING TO ARCHITECT'S ATTENTION ANY DISCREPENCIES BETWEEN INFORMATION ON THIS SHEET AND ANY OTHER INFORMATION IN

2. ALL NOTES, ABBREVIATIONS AND DETAILS MAY NOTE APPLY.


ARRPEVIATIONS:


ABBREVIATIONS:						
A	AMPERES	F.F.E.	FINISH FLOOR ELEVATION	OPNG.	OPENING	
A.B.	ANCHOR BOLT	F.N.	FIELD NAILING	OPPO.	OPPOSITE	
A.F.F.	ABOVE FINISHED FLOOR	F.O.	FACE OF	P.C.	PRECAST CONCRETE	
A.F.G.	ABOVE FINISHED GRADE AIR CONDITIONING	F.S. F/G	FLOOR SINK FIBERGLASS	P.L. or P	PROPERTY LINE PLASTIC LAMINATE	
ABC	AGGREGATE BASE COURSE	FAB.	FABRICATE	P.O.C.	POINT OF CONNECTION	
ABS	ACRYLONITRILE-BUTADIENE-STYRENE	FACP	FIRE ALARM CONTROL PANEL	PERF.	PERFORATED	
ABV.	ABOVE	FDC	FIRE DEPARTMENT CONNECTION	PERP. or ⊥	PERPENDICULAR	
ACB	ASBESTOS—CEMENT BOARD	FDN.	FOUNDATION	PH or Ø	PHASE	
ACOU.	ACOUSTICAL CEILING TILE	FHC FIN.	FIRE HOSE CABINET FINISH	PL. or FL	PLASTER PLATE	
ADD.	ADDITION or ADDENDUM	FL	FLOOR	PLAS.	PLASTIC	
AG	ABOVE GRADE	FLG.	FLOORING	PLUMB.	PLUMBING	
AHU	AIR HANDLING UNIT	FLUOR.	FLUORESCENT	PLYWD.	PLYWOOD	
AL. or ALUM.	ALUMINUM	FP	FIRE PROOF	PORC.	PORCELAIN	
ALT.	ALTERNATE	FRP	FIBER REINFORCED PLASTIC	PREFAB.	PREFABRICATED	
ASDU	ANNEALED	FTG.	FOOTING	PSF	POUNDS PER SQUARE INCL	
ASPH. AVG	ASPHALT AVERAGE	G.I.	FURNISH GALVANIZED IRON	PSI PTN.	POUNDS PER SQUARE INCHED PARTITION	
AWG	AMERICAN WIRE GAUGE	GA.	GAUGE	PVC	POLYVINYLCLORIDE	
4	ANGLE	GALV.	GALVANIZED	PWR.	POWER	
B.M.	BENCH MARK	GAR.	GARAGE	Q.T.	QUARRY TILE	
B.N.	BOUNDARY NAILING	GFCI	GROUND FAULT CIRCUIT	QTY.	QUANTITY	
B.O.F.	BOTTOM OF FOOTING	GFI	GROUND FAULT INTERRUPTER	RCP	RADIUS REINFORCED CONCRETE PII	
B.U.	BUILT UP	GL	GLASS	R.D.L.	ROOF DRAIN LEADER	
B/C	BACK OF CURB	GLB	GLUE LAMINATED BEAM	R.D.O.	ROOF DRAIN OVERFLOW	
BD.	BOARD	GM	GRADE MARK	R.O.	ROUGH OPENING	
BLDG	BUILDING	GV	GATE VALVE	R.O.W. or	RIGHT OF WAY	
BLK.	BLOCK	GRC	GALVANIZED RIGID TUBING	R/W	DEEDINGS : TO T	
BLKG.	BLOCKING	GYP.	GYPSUM BOARD	REF DE:	REFRIGERATOR	
BM. BR	BEAM BRASS	GYP. BD.	HOSE BIBB	RE:	REFERENCE REINFORCED	
BRG.	BEARING	H.C.	HOLLOW CORE	REQ'D.	REQUIRED	
BRZ	BRONZE	H.M.	HOLLOW METAL	RET.	RETURN	
C.A.P.	CONCRETE ASBESTOS PIPE	н/с	HANDICAPPED	REV.	REVISION	
C.D.	CONSTRUCTION DOCUMENTS	HDBD.	HARDBOARD	RM	ROOM	
C.I.P.	CAST IN PLACE	HDW	HARDWARE	RMV.	REMOVE	
C.J.	CONTROL JOINT CLEAN OUT	HGT. HOR.	HEIGHT HORIZONTAL	S.C.	SOLID CORE SMOKE DETECTOR	
C.U. C.T.	CERAMIC TILE	HTR	HEATER	S.O.V.	SHUT OFF VALVE	
CAB	CABINET	HVAC	"HEATING, VENTILATING &	S/L	SKYLIGHT	
CAM.	CAMBER		AIR CONDITIONING"	s/s	STAINLESS STEEL	
CCTV	CLOSED CIRCUIT TELEVISION	HW	HOT WATER	SC	SELF CLOSING	
СЕМ.	CEMENT	HYD.	HYDRAULIC	SCHED.	SCHEDULE	
CER	CERAMIC	I.C.	INTERCOM OUTLET	SECT.	SECTION SECTION	
CFM CH or □	CUBIC FEET PER MINUTE CHANNEL	I.D.	INSIDE DIAMETER INSIDE FACE	SES	SERVICE ENTRANCE SECTION SHEET	
CKT. BKR.	CIRCUIT BREAKER	ID	IDENTIFICATION	SHT'G.	SHEATHING	
CL or ©	CENTERLINE	IG	ISOLATED GROUND	SIM.	SIMILAR	
CLG.	CEILING	IMC	INTERMEDIATE METALLIC CONDUIT	SPA.	SPACE	
CLKG.	CAULKING	IMPG	IMPREGNATED	SPECS	SPECIFICATIONS	
CLO.	CLOSET	INCL.	"INCLUDE, INCLUSIVE"	SPKR.	SPEAKER	
CLR.	CLEAR CORRUGATED METAL PIPE	INSUL.	INSULATION INTERIOR	SQ.FT. or SF	SQUARE FEET SQUARE INCHES	
CMU	CONCRETE MASONRY UNIT	J-BOX	JUNCTION BOX	STC STC	SOUND TRANSMISSION CLAS	
CNTRD.	CENTERED	JCT	JUNCTION	STD.	STANDARD	
COL.	COLUMN	JST.	JOIST	STL.	STEEL	
COMB.	COMBINATION	JT.	JOINT	SUSP.	SUSPENDED	
CONC.	CONCRETE	K-D KD	KNOCK DOWN KILN DRIED	SYM	SWITCH SYMMETRICAL	
CONT.	CONTINUOUS	KO	KNOCK OUT	SYS.	SYSTEM	
CONTR.	CONTRACTOR	L.E.D.	LIGHT EMITTING DIODE	T & G	TONGUE AND GROOVE	
CU	COPPER	L.FT.	LINEAR FEET	T.B.	THROUGH BOLT	
d	PENNY	LAM	LAMINATE	T.M.B.	TELEPHONE MOUNTING BOA	
D.F.	DRINKING FOUNTAIN	LAT.	LATERAL	T.O.	TOP OF	
D.G.	DECOMPOSED GRANITE	LAV	LAVATORY	T.O.B.	TOP OF BEAM	
D.S.	DOWN SPOUT DISHWASHER	LD.	LEAD LINEAR	T.O.C. T.O.F.	TOP OF CURB TOP OF FOOTING	
DBL.	DOUBLE	LINO.	LINOLEUM	T.O.J.	TOP OF FOOTING	
DEMO	DEMOLITION	LT.	LIGHT	T.O.M.	TOP OF MASONRY	
DIA. or ø	DIAMETER	LTG.	LIGHTING	T.O.S.	TOP OF SLAB-TOP OF STE	
DIAG.	DIAGONAL	LVL	LAMINATED VENEER LUMBER	T.O.W.	TOP OF WALL	
DIM.	DIMENSION DEAD LOAD	M.B.	MACHINE BOLT	T.S.	TUBE STEEL	
DN.	DEAD LOAD DOWN	M.H.	MANHOLE MALLEABLE IRON	T.V.	TELEVISION OUTLET TELEPHONE	
DR.	DOOR	M.O.	MASONRY OPENING	TH.	THRESHOLD	
E.A.	EXPANSION ANCHOR	MAR.	MARBLE	THD.	THREADED	
E.F.	EXHAUST FAN	MAS.	MASONRY	THK.	THICK	
E.J.	EXPANSION JOINT	MAT'L	MATERIAL	THRU	THROUGH	
E.N.	END NAILING	MAX.	MAXIMUM	TLT.	TOILET	
E.W.	EACH WAY	MECH.	MECHANICAL MEDIUM	TRANS.	TRANSFORMER TYPICAL	
EL.	ELEVATION	MED.	MANUFACTURING	UNF.	UNFINISHED	
ELECT.	"ELECTRIC, ELECTRICAL"	MFR.	MANUFACTURER	U.N.O.	UNLESS NOTED OTHERWISE	
ELEV.	ELEVATOR	MIN.	MINIMUM	UR	URINAL	
EMC	ELECTRICAL METALLIC CONDUIT	MISC.	MISCELLANEOUS	V.B.	VAPOR BARRIER	
EMT	ELECTRICAL METALLIC TUBING	MOD	MODULAR	V.I.F.	VERIFY IN FIELD	
ENT	ELECTRICAL NON-METALLIC TUBING	MTL.	METAL	VA	VOLT AMPERE	
EQ.IP.	EQUIPMENT	MUL N.I.C.	MULLION NOT IN CONTRACT	VCT VERT.	VINYL COMPOSITION TILE VERTICAL	
EST.	ESTIMATE	N.T.S.	NOT TO SCALE	V.O.J.	VERIFY ON JOB	
EVAP.	EVAPORATIVE COOLER	NCM	NON-CORROSIVE METAL	W/C	WATER CLOSET	
EWC	ELECTRIC DRINKING COOLER	NFC	NOT FOR CONSTRUCTION	WDW	WINDOW	
EXC	EXCAVATE	NLR.	NAILER	WCT	WAINSCOT	
EXH.	EXHAUST	NO.	NUMBER	WP	WEATHER PROOF	
EXIST.	EXISTING	NOM.	NOMINAL ON CENTER	WT.	WEIGHT	
EXT.	EXTERIOR FIRE ALARM	0.C.	ON CENTER OUTSIDE DIAMETER	W/ W/O	WITH	
F.A. F.C.	FIRE ALARM FAN COIL	O.D. O.H.	OUTSIDE DIAMETER OVER HANG	WD.	WITHOUT	
F.C.O.	FLOOR CLEAN OUT	0.H. 0.I.	ORNAMENTAL IRON	W.I.	WROUGHT IRON	
F.D.	FLOOR DRAIN	0.R.	OUTSIDE RADIUS	YD.	YARD	
F.E.	FIRE EXTINGUISHER	OAI	OUTSIDE AIR INTAKE			
F.F.	FINISH FLOOR	ОН	OVER HEAD			

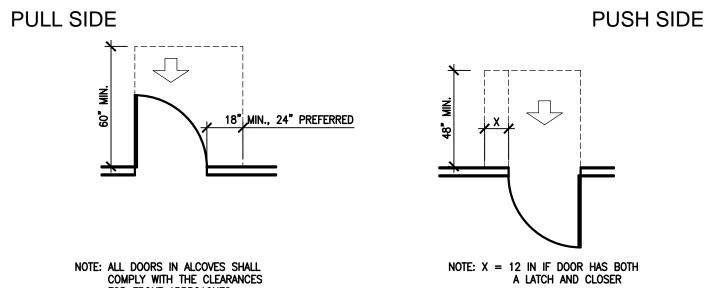



FOR FRONT APPROACHES. FRONT APPROACHES - SWINGING DOORS PULL SIDE **PUSH SIDE**

> NOTE: Y = 48IN MINIMUM IF DOOR HAS NOTE: X = 36IN MINIMUM IF Y = 60IN; BOTH A LATCH AND CLOSER X = 42IN MINIMUM IF Y = 54INHINGE SIDE APPROACHES - SWINGING DOORS

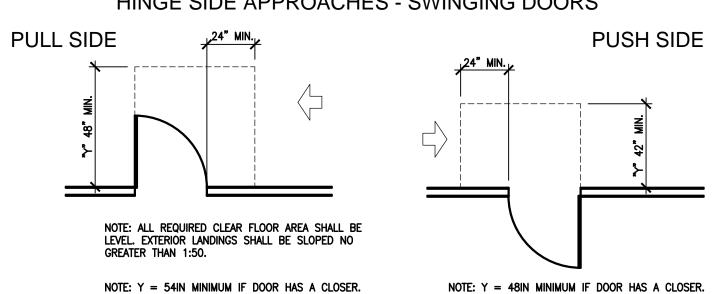

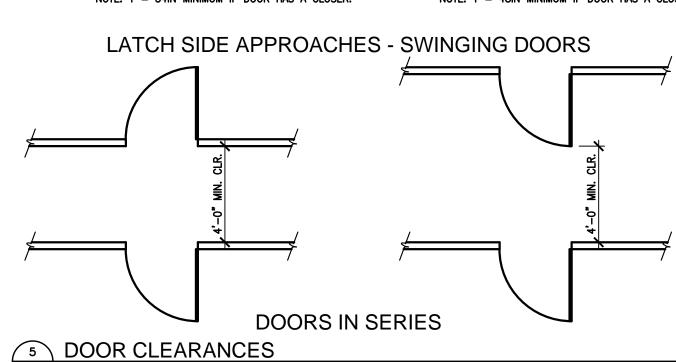

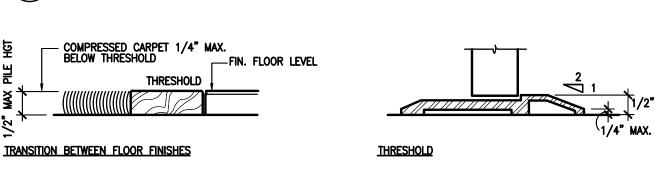

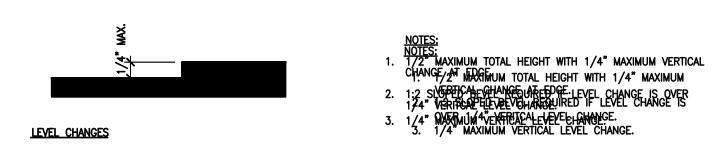


8 THRESHOLD / LEVEL CHANGES G2.00 SCALE: 6" = 1'-0"

G2.00 SCALE: 1/4" = 1'-0"

<u>DETECTABLE WARNING SURFACES INSIDE PROPERTY LINES:</u> DETECTABLE WARNING AREAS SHALL CONSIST OF A REGULARLY SPACED, CONTINUOUS PATTERN OF GROOVES RUNNING PERPENDICULAR TO THE RUN OF A CURB RAMP OR PARALLEL TO THE EDGE BETWEEN A CIRCULATION PATH AND A HAZARDOUS AREA. GROOVES SHALL BE 1/4" WIDE BY 5/8" DEEP SPACED 3" O.C. WARNING AREAS SHALL CONTRAST VÍSUALLY WITH ADJOINING SURFACES, EITHER LIGHT-ON-DARK, OR DARK-ON-LIGHT.

DETECTABLE WARNING SURFACES OUTSIDE PROPERTY LINES: DETECTABLE WARNINGS SHALL CONSIST OF RAISED TRUNCATED DOMES WITH A DIAMETER OF NOMINAL 0.9", A HEIGHT OF NOMINAL 0.2" AND A CENTER-TO-CENTER SPACING OF NOMINAL 2.35" AND SHALL CONTRAST VISUALLY WITH ADJOINING SURFACES, EITHER LIGHT-ON-DARK, OR DARK-ON-LIGHT.

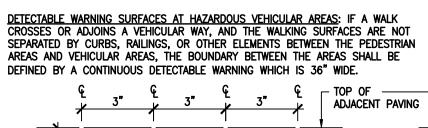



DETECTABLE WARNING SURFACES INSIDE PROPERTY LINES

G2.00 SCALE: 3" = 1'-0"


10 DETECTABLE WARNING SURFACES


DETECTABLE WARNING SURFACES OUTSIDE PROPERTY LINES

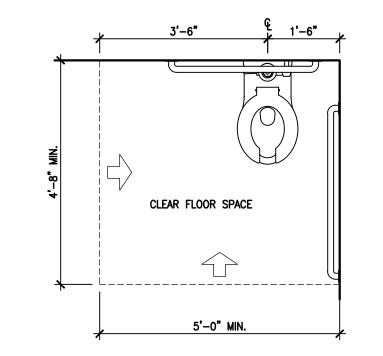


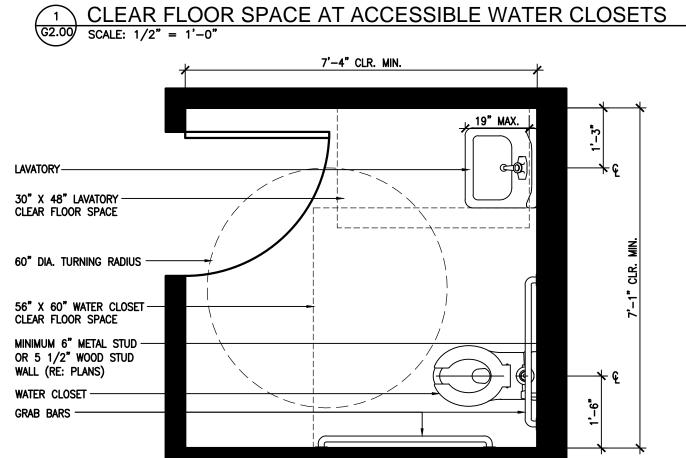



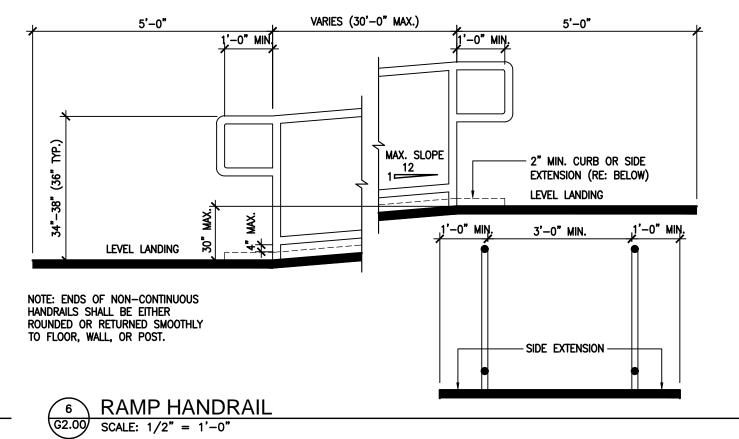


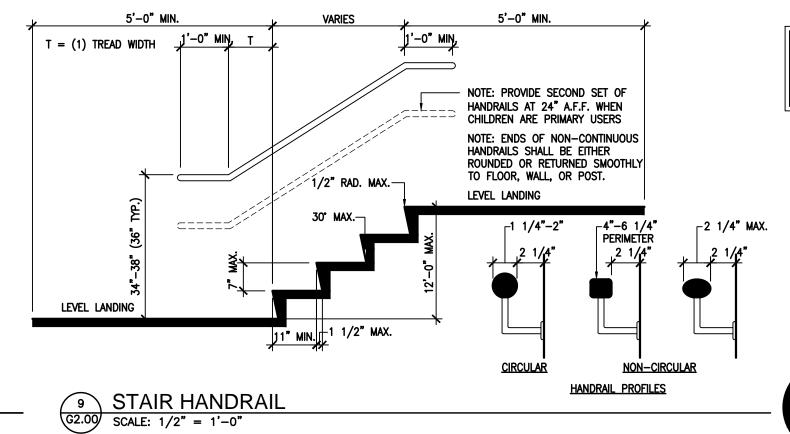


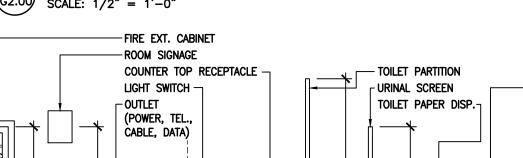

11 STANDARD MOUNTING HEIGHTS

G2.00 SCALE: 1/2" = 1'-0"

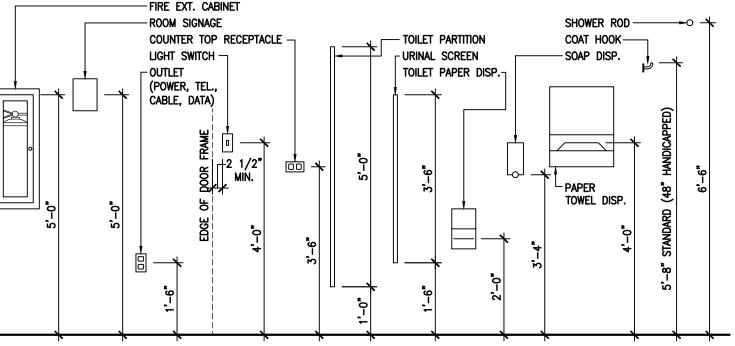


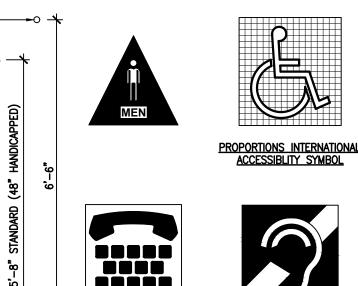





INTERNATIONAL SYMBOL OF ACCESS 16. 0.2 INCH SPACE BETWEEN CELLS.

ALT. DOOR CLEAR FLOOR SPACE 56" MIN. W/ WALL MOUNT W.C. MIN. 42" MIN. LATCH APPROACH 59" MIN. W/ FLOOR MOUNT W.C. MIN. 48" MIN. OTHER APPROACHES

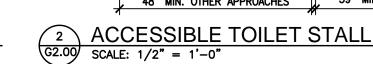

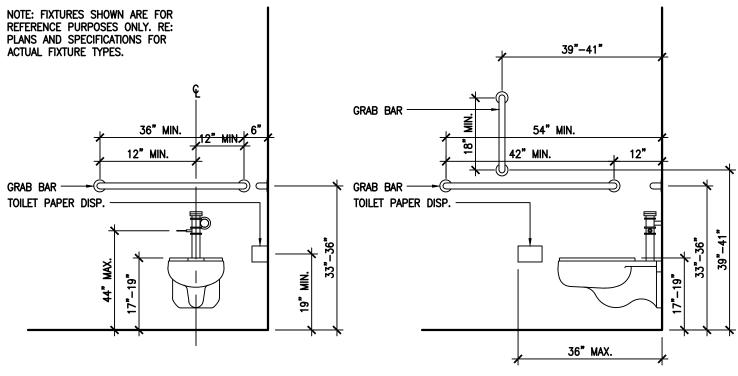

MOUNTING HEIGHTS AT ACCESSIBLE WATER CLOSETS G2.00 SCALE: 1/2" = 1'-0"

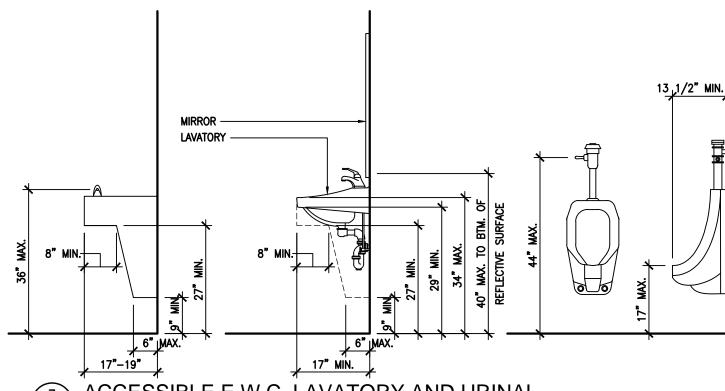

LETTERS AND NUMBERS:

LIGHT BACKGROUND.


ACCESSIBLE E.W.C, LAVATORY AND URINAL

G2.00 SCALE: 1/2" = 1'-0"







INTERNATIONAL ACCESSIBLITY SYMBOL

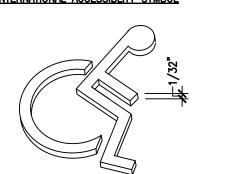

<u>raised</u>

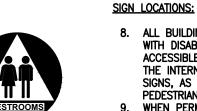

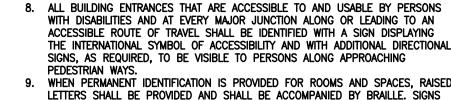

FLOOR, THE MINIMUM CHARACTER HEIGHT SHALL BE 3".

WHEN PERMANENT IDENTIFICATION IS PROVIDED FOR ROOMS AND SPACES, RAISED LETTERS SHALL BE PROVIDED AND SHALL BE ACCOMPANIED BY BRAILLE. SIGNS SHALL BE INSTALLED ON THE WALL ADJACENT TO THE LATCH OUTSIDE OF THE DOOR. WHERE THERE IS NO WALL SPACE ON THE LATCH SIDE, INCLUDING AT LEAF DOORS, SIGNS SHALL BE PLACE ON THE NEAREST ADJACENT WALL, PREFERABLY ON THE RIGHT. MOUNTING HEIGHT SHALL BE 60" ABOVE THE FINISH FLOOR TO THE CENTERLINE OF THE SIGN. MOUNTING LOCATION SHALL BE DETERMINED SO THAT THE PERSON MAY APPROACH WITHIN 3" OF THE SIGNAGE WITHOUT ENCOUNTERING PROTRUDING OBJECTS OR STANDING WITHIN THE SWING OF A DOOR.

LETTERS AND NUMBERS ON SIGNS SHALL BE RAISED 1/32" MINIMUM AND SHALL BE SANS-SERIF UPPERCASE CHARACTERS ACCOMPANIED BY GRADE 2 BRAILLE.

EQUIVALENT VERBAL DESCRIPTION PLACED DIRECLY BELOW THE PICTOGRAM. THE

BORDER DIMENSION OF THE PICTOGRAM SHALL BE A MINIMUM OF 6" IN HEIGHT. 4. LETTERS AND NUMBERS ON SIGNS SHALL HAVE A WIDTH-TO-HEIGHT RATIO OF

BETWEEN 3:5 AND 1:1 AND A STROKE WIDTH-TO-HEIGHT RATIO BETWEEN 1:5

5. CHARACTERS AND SYMBOLS SHALL CONTRAST WITH THEIR BACKGROUND, EITHER

LIGHT CHARACTERS ON A DARK BACKGROUND OR DARK CHARACTERS ON A

6. CHARCTERS AND NUMBERS ON SIGNS SHALL BE SIZED ACCORDING TO THE VIEWING DISTANCE FROM WHICH THEY ARE TO BE READ. THE MINIMUM HEIGHT IS MEASURED USING AN UPPER CASE X. LOWER CASE CHARACTERS ARE PERMITTED.

FOR SIGNS SUSPENDED OR PROJECTED GREATER THAN 80" ABOVE THE FINISH

CONTRACTED GRADE 2 BRAILLE SHALL BE USED WHEREVER BRAILLE SYMBOLS

ARE SPECIFICALLY REQUIRED IN OTHER PORTIONS OF THESE REGULATIONS. DOTS SHALL BE 1/10" ON CENTERS IN EACH CELL WITH 2/10" SPACE BETWEEN

CELLS. DOTS SHALL BE RAISED A MINIMUM OF 1/40" ABOVE THE BACKGROUND.

RAISED CHARACTERS OR SYMBOLS SHALL BE A MINIMUM OF 5/8" HIGH.

PICTORIAL SYMBOL SIGNS (PICTOGRAMS) SHALL BE ACCOMPANIED BY THE

O. ADDITIONAL DIRECTIONAL SIGNS ALONG ACCESSIBLE PATH OF TRAVEL ARE . BUILDINGS REMODELED TO PROVIDE ACCESSIBLE SANITARY FACILITIES FOR PUBLIC USE SHALL HAVE INFORMATION POSTED IN THE LOBBY AS PART OF THE BUILDING DIRECTORY.

INTERNATIONAL SYMBOL OF ACCESSIBILITY:

12. STANDARD USED TO IDENTIFY ACCESSIBLE FACILITIES.

13. WHITE FIGURE ON BLUE BACKGROUND. 14. WHEN ENFORCING AGENCY DETERMINES, IF APPROPRIATE, SPECIAL DESIGNS AND COLORS MAY BE APPROVED.

15. USE CONTRASTED GRADE 2 BRAILLE. DOTS TO BE 0.1 INCH ON CENTER IN

17. DOTS RAISED MINIMUM 0.025 INCH ABOVE BACKGROUND.

SHEET NUMBER

OHN CAROTHERS MAINTENANCE B

COF Contract No. 2019-00096

FUSION

FUSION ARCHITECTURE, PC

FRANKLIN, TENNESSEE 37064

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comply with state and local codes. We will ge

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drawing only.

administer construction.

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DESIGN DEVELOPMENT

CONSTRUCTION DOCUMENTS

PERT NG

S PROI Buildi

DRIVE EE 370

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116 MAJESTIC LANE

V: 615.454.3916

EXHIBIT

PROJECT NUMBER

03-014-18

SHEET TITLE

STANDARDS

INTERNATIONAL TDD SYMBOL

> 12 ACCESSIBLE SIGNAGE G2.00 SCALE: NO SCALE

LEGEND PROPERTY LINE (RE: SURVEY) POWER LINE (RE: SURVEY) IMPERVIOUS CONCRETE PAVING (RE: CIVIL DWGS.) CONCRETE SIDEWALK (RE: CIVIL DWGS.) SEWER MANHOLE WATER VALVE FIRE HYDRANT POWER POLE □ POLE LIGHT W WATER METER GAS COCK AND METER ELECTRICAL METER

SITE PLAN GENERAL NOTES

- 1. COORDINATE ALL WORK SCHEDULING AND COMPLY WITH SAFETY PROCEDURES THAT PROTECT ALL OCCUPANTS IN CONSTRUCTION AREAS. OCCUPANTS IN CONSTRUCTION AREAS.

 2. CONSTRUCTION DEBRIS SHALL BE REMOVED AND/OR STORED AWAY FROM THE BUILDING ON A DAILY BASIS. DISPOSE OF TRASH AS REQUIRED BY ORDINANCE OR CODE.

 3. PROPER SITE DRAINAGE SHALL BE MAINTAINED AT ALL TIMES, DAMAGE CAUSED BY FAILING TO MAINTAIN SITE DRAINAGE SHALL BE THE RESPONSIBILITY OF THE GENERAL CONTRACTOR.

 4. PROVIDE COMPACTED FILL AT RUTS OR HOLES CAUSED BY CONSTRUCTION ACTIVITIES. REPAIR ANY CONCRETE DAMAGED DURING CONSTRUCTION.

 5. ALL NEW PAVING SHALL BE REINFORCED CONCRETE. THICKNESS AND REINFORCING SHALL BE AS DETAILED ON CIVIL DRAWINGS.

 6. ACCESSIBLE PARKING SPACE TO BE DESIGNATED BY BLUE STRIPING AND EITHER A BLUE SYMBOL ON A WHITE BACKGROUND OR A WHITE SYMBOL ON A BLUE BCAKGROUND. ACCESSIBLE PARKING STALLS REQUIRE THE INSTALLATION OF THE PROPER SIGNAGE.

 7. ALL PARKING SPACES SHALL BE LAID OUT IN ACCORDANCE WITH THE TYPICAL DETAIL AS SHOWN ON THIS PLAN, UNLESS OTHERWISE INDICATED ON THIS PLAN.

 8. PRIOR TO INSTALLATION AND POURING OF CONCRETE PAVING, CONTRACTOR SHALL VERIFY AND COORDINATE ALL CONDUIT SIZES AND ROUTES.

 9. REFERENCE LANDSCAPE DRAWINGS FOR PLANTING AND SEEDING SCOPE OF WORK.

- 9. REFERENCE LANDSCAPE DRAWINGS FOR PLANTING AND SEEDING SCOPE OF WORK.

PARKING SUMMARY

SITE PLAN KEYNOTES

1 NEW CONCRETE SIDEWALK

FUSION ARCHITECTURE, PC 116 MAJESTIC LANE FRANKLIN, TENNESSEE 37064

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V: 615.454.3916

COF Contract No. 2019-00096

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administer construction.

PHASE | REVISION SCHEMATIC DESIGN DESIGN DEVELOPMENT 03.08.2019 CONSTRUCTION DOCUMENTS

JOHN CAROTHERS PROF MAINTENANCE BUILDI

EXHIBIT

PROJECT NUMBER


03-014-18


SHEET TITLE

ARCH. SITE PLAN

SHEET NUMBER

A1.00

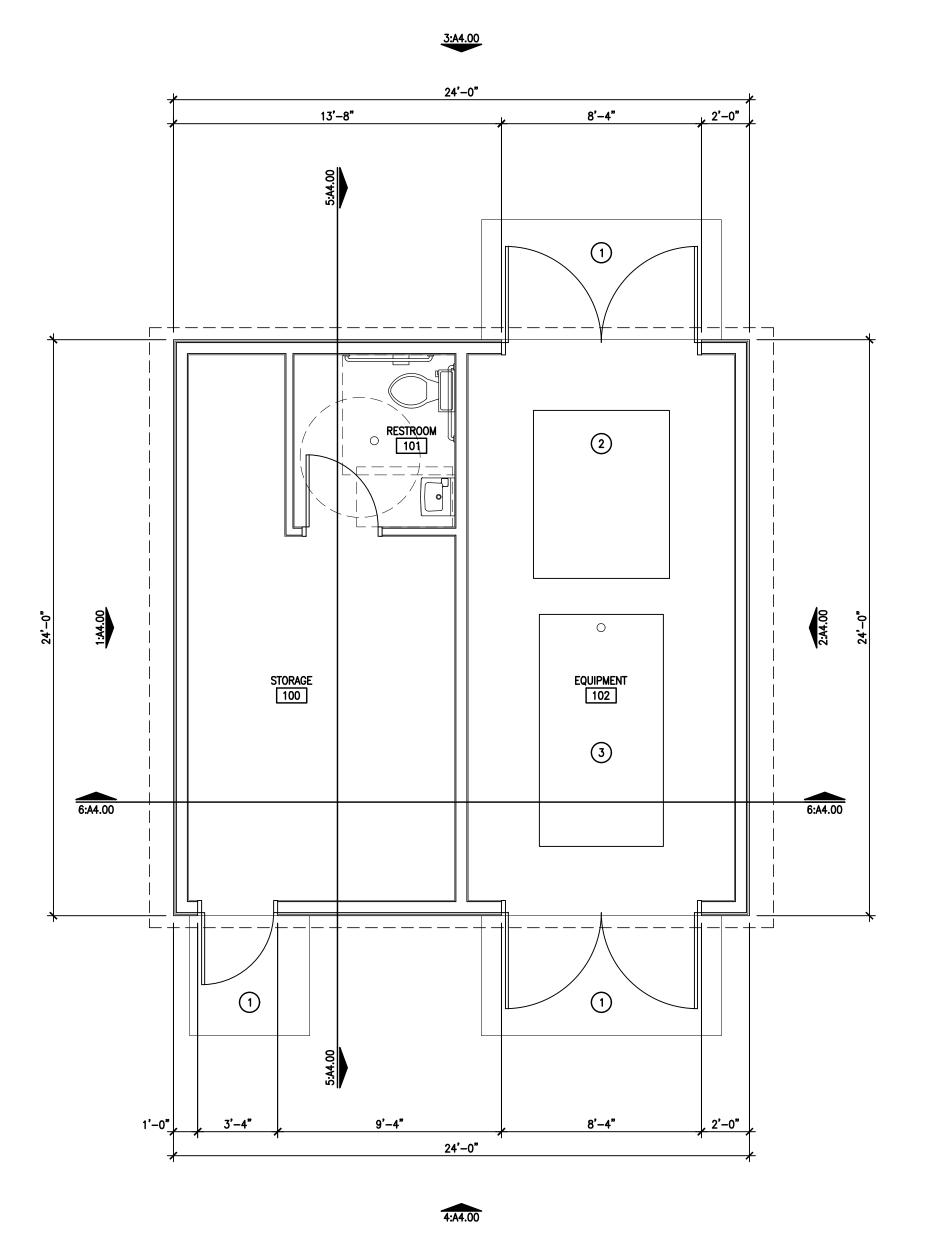


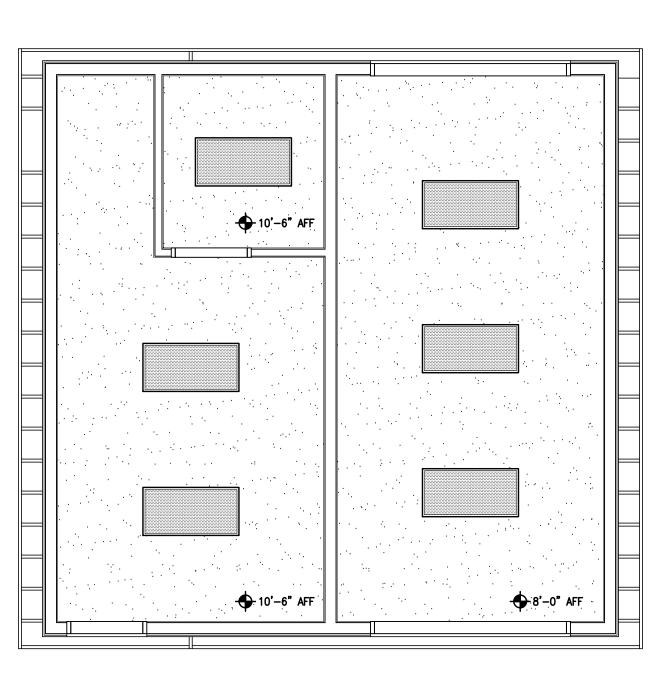

4	4)	4
7.5:12	7.5:12	2.5:12

LEGEND

NEW DOOR AS SCHEDULED

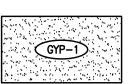

PAINTED GYPSUM BOARD:



2'-0" x 4'-0" LED LIGHT WITH ACRYLIC LENS (RE: ELECTRICAL)

NEW WALL AS SCHEDULED

RECESSED CAN DOWNLIGHT (RE: ELECTRICAL)

EXIT LIGHT (RE: ELECTRICAL)

ELEVATION INDICATES CLEAR HEIGHT FROM FINISHED FLOOR TO FINISHED CEILING. ALL CEILING HEIGHTS = 9'-0" U.N.O.

GENERAL NOTES

- 1. INTERIOR FINISHES SHALL COMPLY WITH NFPA 101:36.3.3 (0-75) FLAMESPREAD WITH SMOKE DEVELOPMENT OF (0-450).
- 2. LOOSELY HANGING FURNISHINGS AND DECORATIONS SHALL BE FLAME RESISTANT AS DEMONSTRATED BY TESTING IN ACCORDANCE WITH NFPA 701.
- 3. ALL DIMENSIONS, UNLESS NOTED OTHERWISE, ARE TAKEN FROM FACE OF FRAMING.
- 4. INSULATION ASSEMBLIES SHALL MEET THE REQUIREMENTS OF SECTION 708, IBC, 2018 EDITION.

KEYNOTES

- 1 CONCRETE LANDING
- 2 LAWN MOWER
- 3 ALL TERRAIN VEHICLE
- 4) PRE-FINISHED STANDING SEAM METAL ROOF
- 6
- 7 -

- 10 -

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PHASE | REVISION SCHEMATIC DESIGN 03.08.2019

DESIGN DEVELOPMENT CONSTRUCTION DOCUMENTS

JOHN CAROTHERS PROF MAINTENANCE BUILDI

EXHIBIT

PROJECT NUMBER

03-014-18

SHEET TITLE

ARCH. PLANS

SHEET NUMBER

A2.10









NORTH ELEVATION


SCALE: 1/4" = 1'-0"

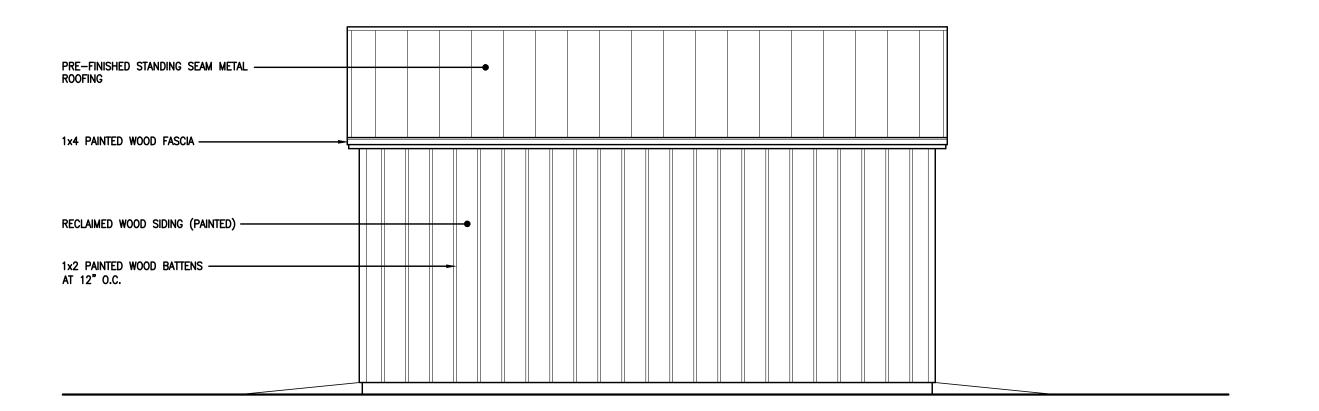


2 SOUTH ELEVATION SCALE: 1/4" = 1'-0"

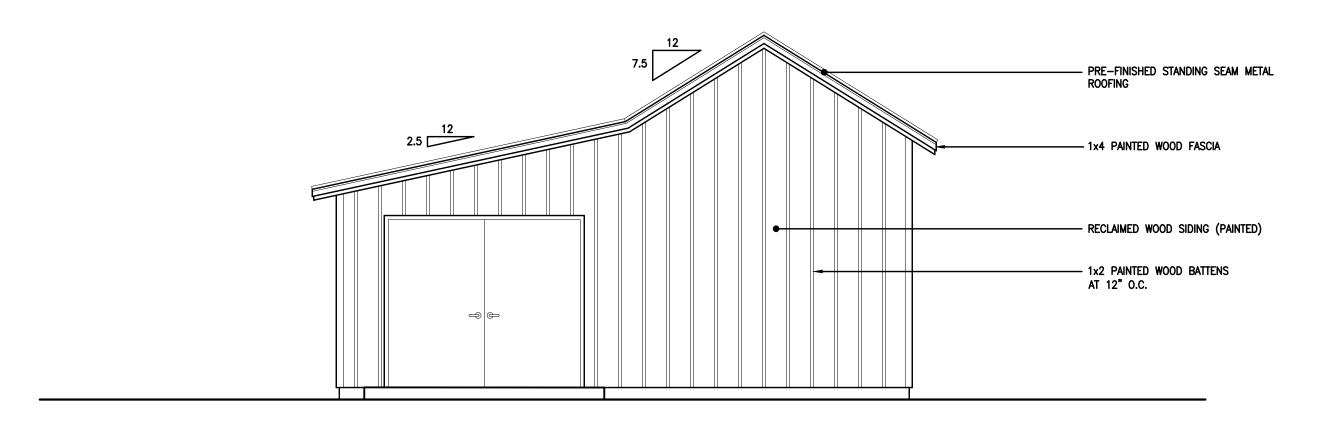


3 EAST ELEVATION
A4.00 SCALE: 1/4" = 1'-0"

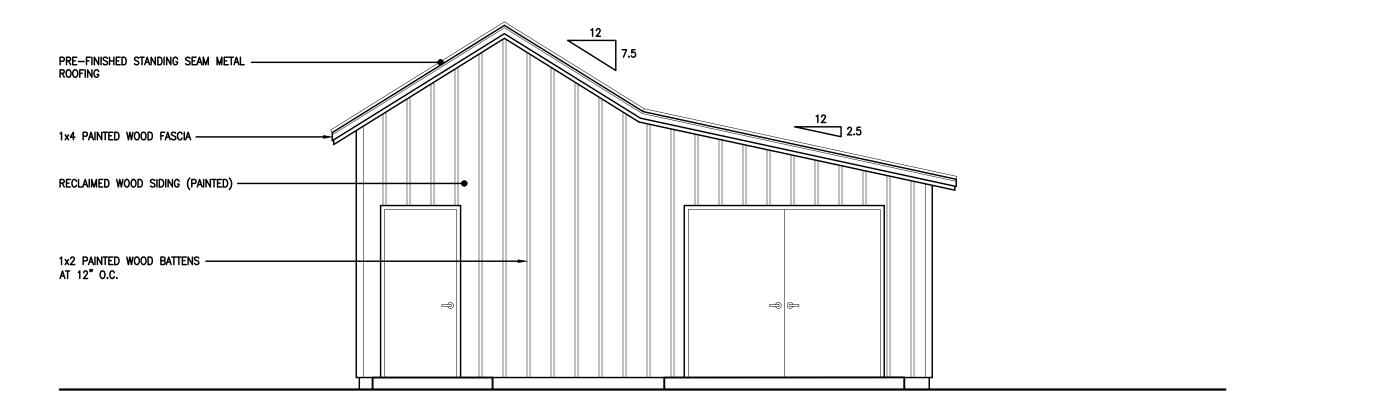

4 WEST ELEVATION
A4.00 SCALE: 1/4" = 1'-0"

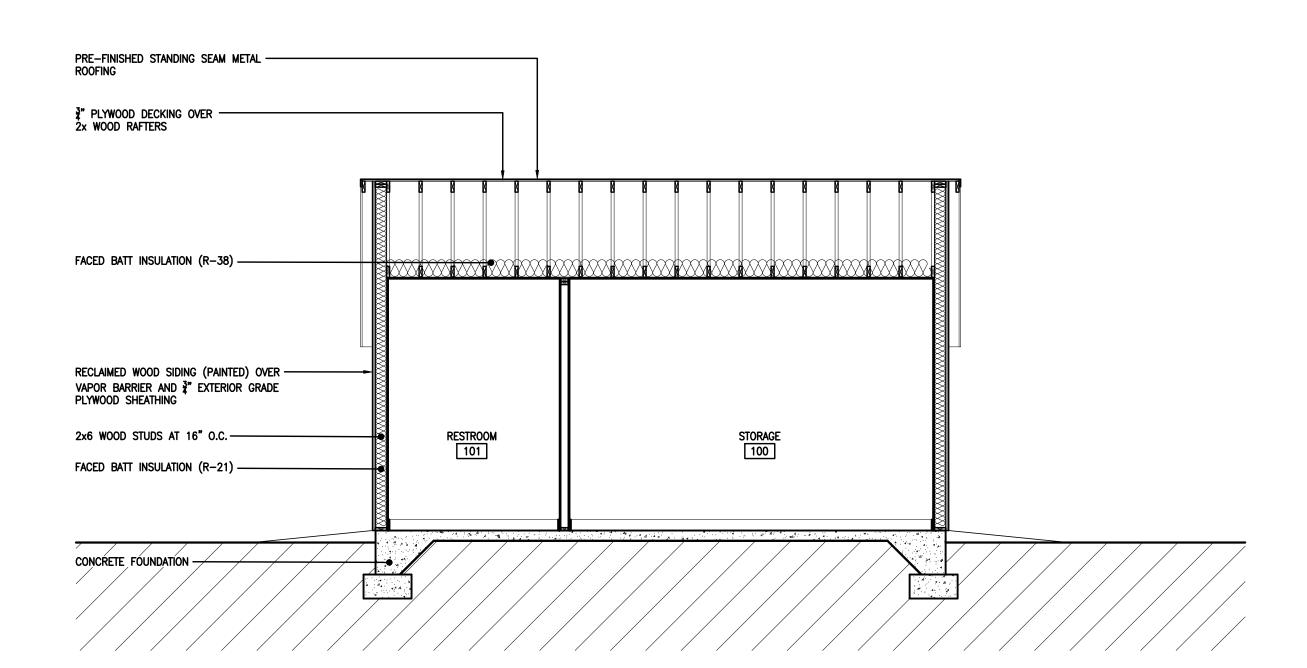

5 BUILDING SECTION
A4.00 SCALE: 1/4" = 1'-0"

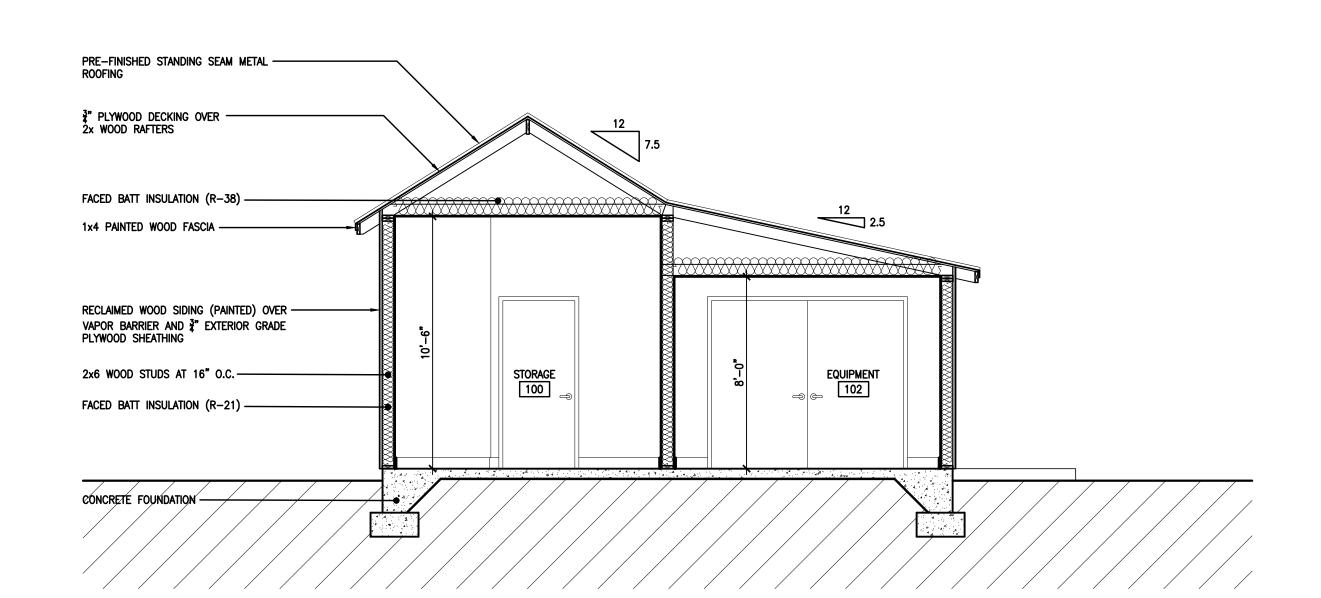

6 BUILDING SECTION
A4.00 SCALE: 1/4" = 1'-0"

COF Contract No. 2019-00096



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PHASE REVISION		DATE
SCHEMATIC DESIGN	01.	11.2019
DESIGN DEVELOPMENT	03.0	08.2019
CONSTRUCTION DOCUMENTS		_

CONSTRUCTION DOCUMENTS

HUFFINES RIDGE DRIVE FRANKLIN, TENNESSEE 3706 JOHN CAROTHERS PROF MAINTENANCE BUILDI

EXHIBIT

PROJECT NUMBER

03-014-18

SHEET TITLE

ELEVS AND SECTIONS

SHEET NUMBER


A4.00

DESIGN DEVELOPMENT

JOHN CAROTHERS PROPERTY TRAILHEAD SHELTER

HUFFINES RIDGE DRIVE FRANKLIN, TENNESSEE 37067

	INDEX OF DRAWINGS:							
	GENERAL (2) G1.00							
GENERAL NOTES:	PROJECT INFORMATION:	APPLICABLE BUILDING CODES AND STANDARDS:	VICINITY MAP:					
 THE GENERAL CONTRACTOR IS RESPONSIBLE TO SUPPLY ALL SUBCONTRACTORS WITH CONSTRUCTION DRAWINGS AND SPECIFICATIONS NECESSARY TO BID AND/OR CONSTRUCT THIS PROJECT. ALL DIMENSIONS ON THE FLOOR PLANS, UNLESS OTHERWISE NOTED, ARE TAKEN FROM FACES OF STUDS OF EXTERIOR WALLS AND INTERIOR WALLS. THE OWNER SHALL BE RESPONSIBLE FOR NOTIFYING THE GENERAL CONTRACTOR OF ANY ADDITIONAL ITEMS TO BE INSTALLED THAT ARE NOT SHOWN ON THE DRAWINGS. ANY PENETRATIONS OF, OR MODIFICATIONS TO CONCRETE MUST BE COORDINATED WITH ARCHITECT PRIOR TO CONSTRUCTION. IN ACCORDANCE WITH GENERALLY ACCEPTED CONSTRUCTION PRACTICES, THE CONTRACTOR WILL BE SOLELY AND COMPLETELY RESPONSIBLE FOR CONDITIONS OF THE JOB SITE, INCLUDING SAFETY OF ALL PERSONS AND PROPERTY DURING PERFORMANCE OF WORK. THIS REQUIREMENT WILL APPLY CONTINUOUSLY AND SHALL NOT BE LIMITED TO NORMAL WORKING HOURS. THE CONTRACTOR SHALL TAKE ALL NECESSARY PRECAUTIONS TO INSURE THE SAFETY OF THE PUBLIC AND/OR WORK PERSONS ON THE JOB AND TO PREVENT ACCIDENTS OR INJURY TO ANY PERSON ON, ABOUT OR ADJACENT TO THE PREWISES. THE CONTRACTOR SHALL COMPLY WITH ALL LAWS, ORDINANCES, CODES, RULES AND REGULATIONS RELATIVE TO SAFETY AND THE PREVENTION OF ACCIDENTS. WHETHER OR NOT SPECIFICALLY INDICATED ON THE DRAWINGS, ALL CONTRACTORS SHALL BE RESPONSIBLE FOR REMOVING OR DEMOLISHING EXISTING CONSTRUCTION (INCLUDING UTILITIES) WHICH WILL INTERFERE WITH NEW WORK. PRIOR TO THE SHUT-DOWN OR TYING INTO ANY UTILITY, APPROVAL SHALL BE OBTAINED FROM THE OWNER'S REPRESENTATIVE. COORDINATE WITH OWNER'S REPRESENTATIVE, LOCATION OF CONTRACTORS' EQUIPMENT AND MATERIAL STORAGE. 	OCCUPANCY CLASSIFICATION: IBC: UTILITY: GROUP U NFPA: SPECIAL STRUCTURES: — CHAPTER 11 TYPE OF CONSTRUCTION: IBC: TYPE V (B) NFPA: TYPE V (000) ALLOWABLE NO. OF STORIES: 1 NO. OF STORIES: 1 ALLOWABLE BUILDING HEIGHT: 40'-0" BUILDING HEIGHT: 12'-1" ALLOWABLE BUILDING AREA: 5,000 S.F. BUILDING AREA: 150 S.F.	2018 INTERNATIONAL BUILDING CODE INCLUDING APPENDICES D, G AND K 2018 INTERNATIONAL ENERGY CONSERVATION CODE (FOR BUILDINGS REVIEWED UNDER THE IBC) 2018 INTERNATIONAL FIRE CODE INCLUDING APPENDICES B, C AND D 2018 NEPA LIFE SAFETY CODE 101 2017 NATIONAL ELECTRIC CODE 2018 INTERNATIONAL PLUMBING CODE 2018 INTERNATIONAL MECHANICAL CODE 2018 INTERNATIONAL FUEL GAS CODE 2017 ICC A 117.1 ACCESSIBLE AND USEABLE BUILDINGS AND FACILITIES 2018 INTERNATIONAL EXISTING BUILDING CODE 2018 INTERNATIONAL EXISTING BUILDING APPENDICES G AND J 2009 INTERNATIONAL ERERGY CONSERVATION CODE (FOR BUILDINGS REVIEWED UNDER THE IRC) 2018 INTERNATIONAL PROPERTY MAINTENANCE CODE 2018 INTERNATIONAL SWIMMING POOL AND SPA CODE						
9. ALL MECHANICAL WORK SHALL BE PERFORMED BY A LICENSED MECHANICAL CONTRACTOR AND IN ACCORDANCE WITH ALL APPLICABLE CODES AND STANDARDS.	PROJECT DESCRIPTION:	PROFESSIONAL OF RECORD:	VeaScal Springs					
 ALL PLUMBING WORK SHALL BE PERFORMED BY A LICENSED PLUMBING CONTRACTOR ALL IN ACCORDANCE WITH ALL APPLICABLE CODES AND STANDARDS. ALL ELECTRICAL WORK SHALL BE PERFORMED BY A LICENSED ELECTRICAL CONTRACTOR AND IN ACCORDANCE WITH ALL APPLICABLE CODES AND STANDARDS. ALL STRUCTURAL FRAMING WORK SHALL BE PERFORMED IN ACCORDANCE WITH ALL APPLICABLE CODES AND STANDARDS. 	THIS PROJECT INVOLVES THE CONSTRUCTION OF AN OPEN TRAILHEAD SHELTER STRUCTURE.	ARCHITECT: FUSION ARCHITECTURE, PC 116 MAJESTIC LANE FRANKLIN, TENNESSEE 37064 VOICE: 615.454.3916 CONTACT: KYLE M. KRAMER, ARCHITECT EMAIL: kkramer@fusionarchitecture.com	PROJECT SITE N JOHN CAROTHERS HOUSE HUFFINES RIDES DRIVE FRANKLIN, TENNESSEE 37067					
SYMBOLS LEGEND:	CONS	ULTANTS:	HATCH LEGEND:					
DETAIL TAG XXX KEY NOTE			PLAN: SPANDREL GLASS INSULATION PLYWOOD BRICK BRICK BRICK C.M.U. GYP. BD. / M.D.F. / SAND CLEAR GLASS STEEL					

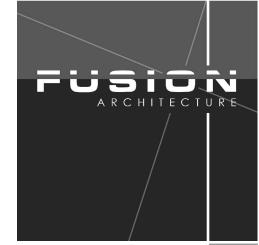

FUSION ARCHITECTURE, PC

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personal supervision, and to the best of our know comply with state and local codes. We will ge

SCHEMATIC DESIGN

EXHIBIT

PROJECT NUMBER

03-014-18


SHEET TITLE TITLE SHEET

1. DETAILS AND NOTES ON THIS SHEET SHALL GOVERN STANDARD DIMENSIONS ,CLEARANCES, AND MOUNTING LOCATIONS. CONTRACTOR SHALL IMMEDIATELY BRING TO ARCHITECT'S ATTENTION ANY DISCREPENCIES BETWEEN INFORMATION ON THIS SHEET AND ANY OTHER INFORMATION IN


2. ALL NOTES, ABBREVIATIONS AND DETAILS MAY NOTE APPLY.

ABBREVIATIONS:


			BREVIATIONS:		
A	AMPERES	F.F.E.	FINISH FLOOR ELEVATION	OPNG.	OPENING
A.B.	ANCHOR BOLT	F.N.	FIELD NAILING	OPPO.	OPPOSITE
A.F.F.	ABOVE FINISHED FLOOR	F.0.	FACE OF	P.C.	PRECAST CONCRETE
A.F.G.	ABOVE FINISHED GRADE	F.S.	FLOOR SINK	P.L. or P	PROPERTY LINE
A/C ABC	AIR CONDITIONING AGGREGATE BASE COURSE	F/G FAB.	FIBERGLASS FABRICATE	P.LAM. P.O.C.	PLASTIC LAMINATE POINT OF CONNECTION
ABS	ACRYLONITRILE—BUTADIENE—STYRENE		FIRE ALARM CONTROL PANEL	PERF.	PERFORATED
ABV.	ABOVE	FDC	FIRE DEPARTMENT CONNECTION	PERP. or ⊥	PERPENDICULAR
ACB	ASBESTOS-CEMENT BOARD	FDN.	FOUNDATION PH or Ø		PHASE
ACOU.	ACOUSTIC	FHC	FIRE HOSE CABINET	PL.	PLASTER
ACT	ACOUSTICAL CEILING TILE	FIN.	FINISH	PL. or FL	PLATE
ADD.	ADDITION or ADDENDUM ABOVE GRADE	FL FLG.	FLOOR FLOORING	PLAS. PLUMB.	PLASTIC PLUMBING
AHU	AIR HANDLING UNIT	FLUOR.	FLUORESCENT	PLYWD.	PLYWOOD
AL. or ALUM.		FP	FIRE PROOF	PORC.	PORCELAIN
ALT.	ALTERNATE	FRP	FIBER REINFORCED PLASTIC	PREFAB.	PREFABRICATED
ANL	ANNEALED	FTG.	FOOTING	PSF	POUNDS PER SQUARE FOO
ASPH.	ASPHALT	FURN.	FURNISH	PSI	POUNDS PER SQUARE INCH
AVG	AVERAGE	G.I.	GALVANIZED IRON	PTN.	PARTITION
AWG	AMERICAN WIRE GAUGE ANGLE	GALV.	GAUGE GALVANIZED	PVC PWR.	POLYVINYLCLORIDE POWER
B.M.	BENCH MARK	GAR.	GARAGE	Q.T.	QUARRY TILE
B.N.	BOUNDARY NAILING	GFCI	GROUND FAULT CIRCUIT	QTY.	QUANTITY
B.O.	BOTTOM OF		INTERRUPTER	R	RADIUS
B.O.F.	BOTTOM OF FOOTING	GFI	GROUND FAULT INTERRUPTER	RCP	REINFORCED CONCRETE PI
B.U. B/C	BUILT UP BACK OF CURB	GL GLB	GLASS GLUE LAMINATED BEAM	R.D.L. R.D.O.	ROOF DRAIN LEADER ROOF DRAIN OVERFLOW
BD.	BOARD	GM	GRADE MARK	R.O.	ROUGH OPENING
BLDG	BUILDING	GV	GATE VALVE	R.O.W. or	RIGHT OF WAY
BLK.	BLOCK	GRC	GALVANIZED RIGID TUBING	R/W	
BLKG.	BLOCKING	GYP.	GYPSUM	REF	REFRIGERATOR
BM.	BEAM	GYP. BD.	GYPSUM BOARD	RE:	REFERENCE
BR	BRASS	H.B.	HOSE BIBB	REINF.	REINFORCED
BRG. BRZ	BEARING BRONZE	H.C. H.M.	HOLLOW CORE HOLLOW METAL	REQ'D.	REQUIRED RETURN
C.A.P.	CONCRETE ASBESTOS PIPE	H/C	HANDICAPPED	REV.	REVISION
C.D.	CONSTRUCTION DOCUMENTS	HDBD.	HARDBOARD	RM	ROOM
C.I.P.	CAST IN PLACE	HDW	HARDWARE	RMV.	REMOVE
C.J.	CONTROL JOINT	HGT.	HEIGHT	S.C.	SOLID CORE
C.O.	CLEAN OUT	HOR.	HORIZONTAL	S.D.	SMOKE DETECTOR
C.T.	CERAMIC TILE	HTR	HEATER	S.O.V.	SHUT OFF VALVE
CAB.	CABINET CAMBER	HVAC	"HEATING, VENTILATING & AIR CONDITIONING"	S/L S/S	SKYLIGHT STAINLESS STEEL
CCTV	CLOSED CIRCUIT TELEVISION	HW	HOT WATER	SC	SELF CLOSING
CEM.	CEMENT	HYD.	HYDRAULIC	SCHED.	SCHEDULE
CER	CERAMIC	I.C.	INTERCOM OUTLET	SECT.	SECTION
CFM	CUBIC FEET PER MINUTE	I.D.	INSIDE DIAMETER	SES	SERVICE ENTRANCE SECTIO
CH or C	CHANNEL	I.F.	INSIDE FACE	SH	SHEET
CKT. BKR.	CIRCUIT BREAKER CENTERLINE	ID IG	IDENTIFICATION ISOLATED GROUND	SHT'G.	SHEATHING SIMILAR
CLG.	CEILING	IMC	INTERMEDIATE METALLIC CONDUIT	SPA.	SPACE
CLKG.	CAULKING	IMPG	IMPREGNATED	SPECS	SPECIFICATIONS
CLO.	CLOSET	INCL.	"INCLUDE, INCLUSIVE"	SPKR.	SPEAKER
CLR.	CLEAR	INSUL.	INSULATION	SQ.FT. or SF	SQUARE FEET
CMP	CORRUGATED METAL PIPE	INT.	INTERIOR	SQ. IN.	SQUARE INCHES
CMU	CONCRETE MASONRY UNIT	J-BOX	JUNCTION BOX	STC	SOUND TRANSMISSION CLAS
ONTOD	CENTERED	JCT	JUNCTION JOIST	STD.	STANDARD
CNTRD.	COLLIMN	JST			CIFFI
COL.	COLUMN COMBINATION	JST. JT.	JOINT		STEEL SUSPENDED
		JST. JT. K-D		SUSP.	
COL.	COMBINATION	JT.	JOINT	SUSP.	SUSPENDED
COL. COMB. CONC. CONST. CONT.	COMBINATION CONCRETE CONSTRUCTION CONTINUOUS	JT. K-D KD KO	JOINT KNOCK DOWN KILN DRIED KNOCK OUT	SUSP. SW SYM SYS.	SUSPENDED SWITCH SYMMETRICAL SYSTEM
COL. COMB. CONC. CONST. CONT. CONTR.	COMBINATION CONCRETE CONSTRUCTION CONTINUOUS CONTRACTOR	JT. K-D KD KO L.E.D.	JOINT KNOCK DOWN KILN DRIED KNOCK OUT LIGHT EMITTING DIODE	SUSP. SW SYM SYS. T & G	SUSPENDED SWITCH SYMMETRICAL SYSTEM TONGUE AND GROOVE
COL. COMB. CONC. CONST. CONT. CONTR. CU	COMBINATION CONCRETE CONSTRUCTION CONTINUOUS CONTRACTOR COPPER	JT. K-D KD KO L.E.D. L.FT.	JOINT KNOCK DOWN KILN DRIED KNOCK OUT LIGHT EMITTING DIODE LINEAR FEET	SUSP. SW SYM SYS. T & G T.B.	SUSPENDED SWITCH SYMMETRICAL SYSTEM TONGUE AND GROOVE THROUGH BOLT
COL. COMB. CONC. CONST. CONT. CONTR.	COMBINATION CONCRETE CONSTRUCTION CONTINUOUS CONTRACTOR	JT. K-D KD KO L.E.D.	JOINT KNOCK DOWN KILN DRIED KNOCK OUT LIGHT EMITTING DIODE	SUSP. SW SYM SYS. T & G	SUSPENDED SWITCH SYMMETRICAL SYSTEM TONGUE AND GROOVE THROUGH BOLT
COL. COMB. CONC. CONST. CONT. CONTR. CU d	COMBINATION CONCRETE CONSTRUCTION CONTINUOUS CONTRACTOR COPPER PENNY	JT. K-D KD KO L.E.D. L.FT. LAM	JOINT KNOCK DOWN KILN DRIED KNOCK OUT LIGHT EMITTING DIODE LINEAR FEET LAMINATE	SUSP. SW SYM SYS. T & G T.B. T.M.B.	SUSPENDED SWITCH SYMMETRICAL SYSTEM TONGUE AND GROOVE THROUGH BOLT TELEPHONE MOUNTING BOA
COL. COMB. CONC. CONST. CONTR. CONTR. CU d D.F.	COMBINATION CONCRETE CONSTRUCTION CONTINUOUS CONTRACTOR COPPER PENNY DRINKING FOUNTAIN	JT. K-D KD KO L.E.D. L.FT. LAM LAT.	JOINT KNOCK DOWN KILN DRIED KNOCK OUT LIGHT EMITTING DIODE LINEAR FEET LAMINATE LATERAL	SUSP. SW SYM SYS. T & G T.B. T.M.B. T.O.	SUSPENDED SWITCH SYMMETRICAL SYSTEM TONGUE AND GROOVE THROUGH BOLT TELEPHONE MOUNTING BOA TOP OF
COL. COMB. CONC. CONST. CONT. CONTR. CU d D.F. D.G. D.S. D/W	COMBINATION CONCRETE CONSTRUCTION CONTINUOUS CONTRACTOR COPPER PENNY DRINKING FOUNTAIN DECOMPOSED GRANITE DOWN SPOUT DISHWASHER	JT. K-D KD KO L.E.D. L.FT. LAM LAT. LAV LD.	JOINT KNOCK DOWN KILN DRIED KNOCK OUT LIGHT EMITTING DIODE LINEAR FEET LAMINATE LATERAL LAVATORY LEAD LINEAR	SUSP. SW SYM SYS. T & G T.B. T.M.B. T.O. T.O.B. T.O.C. T.O.F.	SUSPENDED SWITCH SYMMETRICAL SYSTEM TONGUE AND GROOVE THROUGH BOLT TELEPHONE MOUNTING BOATOP OF TOP OF BEAM TOP OF CURB TOP OF FOOTING
COL. COMB. CONC. CONST. CONTR. CU d D.F. D.G. D.S. D/W DBL.	COMBINATION CONCRETE CONSTRUCTION CONTINUOUS CONTRACTOR COPPER PENNY DRINKING FOUNTAIN DECOMPOSED GRANITE DOWN SPOUT DISHWASHER DOUBLE	JT. K-D KD KO L.E.D. L.FT. LAM LAT. LAV LD. LIN.	JOINT KNOCK DOWN KILN DRIED KNOCK OUT LIGHT EMITTING DIODE LINEAR FEET LAMINATE LATERAL LAVATORY LEAD LINEAR LINOLEUM	SUSP. SW SYM SYS. T & G T.B. T.M.B. T.O. T.O.B. T.O.C. T.O.F. T.O.J.	SUSPENDED SWITCH SYMMETRICAL SYSTEM TONGUE AND GROOVE THROUGH BOLT TELEPHONE MOUNTING BOA TOP OF TOP OF BEAM TOP OF CURB TOP OF FOOTING TOP OF JOIST
COL. COMB. CONC. CONST. CONT. CONTR. CU d D.F. D.G. D.S. D/W DBL. DEMO	COMBINATION CONCRETE CONSTRUCTION CONTINUOUS CONTRACTOR COPPER PENNY DRINKING FOUNTAIN DECOMPOSED GRANITE DOWN SPOUT DISHWASHER DOUBLE DEMOLITION	JT. K-D KD KO L.E.D. L.FT. LAM LAT. LAV LD. LIN. LINO. LT.	JOINT KNOCK DOWN KILN DRIED KNOCK OUT LIGHT EMITTING DIODE LINEAR FEET LAMINATE LATERAL LAVATORY LEAD LINEAR LINOLEUM LIGHT	SUSP. SW SYM SYS. T & G T.B. T.M.B. T.O. T.O.B. T.O.C. T.O.F. T.O.J. T.O.M.	SUSPENDED SWITCH SYMMETRICAL SYSTEM TONGUE AND GROOVE THROUGH BOLT TELEPHONE MOUNTING BOA TOP OF TOP OF BEAM TOP OF CURB TOP OF FOOTING TOP OF JOIST TOP OF MASONRY
COL. COMB. CONC. CONST. CONTR. CU d D.F. D.G. D.S. D/W DBL.	COMBINATION CONCRETE CONSTRUCTION CONTINUOUS CONTRACTOR COPPER PENNY DRINKING FOUNTAIN DECOMPOSED GRANITE DOWN SPOUT DISHWASHER DOUBLE	JT. K-D KD KO L.E.D. L.FT. LAM LAT. LAV LD. LIN.	JOINT KNOCK DOWN KILN DRIED KNOCK OUT LIGHT EMITTING DIODE LINEAR FEET LAMINATE LATERAL LAVATORY LEAD LINEAR LINOLEUM	SUSP. SW SYM SYS. T & G T.B. T.M.B. T.O. T.O.B. T.O.C. T.O.F. T.O.J.	SUSPENDED SWITCH SYMMETRICAL SYSTEM TONGUE AND GROOVE THROUGH BOLT TELEPHONE MOUNTING BOA TOP OF TOP OF BEAM TOP OF CURB TOP OF FOOTING TOP OF JOIST TOP OF MASONRY
COL. COMB. CONC. CONST. CONT. CONTR. CU d D.F. D.G. D.S. D/W DBL. DEMO DIA. or Ø	COMBINATION CONCRETE CONSTRUCTION CONTINUOUS CONTRACTOR COPPER PENNY DRINKING FOUNTAIN DECOMPOSED GRANITE DOWN SPOUT DISHWASHER DOUBLE DEMOLITION DIAMETER	JT. K-D KD KO L.E.D. L.FT. LAM LAT. LAV LD. LIN. LINO. LT. LTG.	JOINT KNOCK DOWN KILN DRIED KNOCK OUT LIGHT EMITTING DIODE LINEAR FEET LAMINATE LATERAL LAVATORY LEAD LINEAR LINOLEUM LIGHTING	SUSP. SW SYM SYS. T & G T.B. T.M.B. T.O. T.O.B. T.O.C. T.O.F. T.O.J. T.O.M. T.O.S.	SUSPENDED SWITCH SYMMETRICAL SYSTEM TONGUE AND GROOVE THROUGH BOLT TELEPHONE MOUNTING BOA TOP OF TOP OF BEAM TOP OF CURB TOP OF FOOTING TOP OF JOIST TOP OF MASONRY TOP OF SLAB—TOP OF STE
COL. COMB. CONC. CONST. CONTR. CU d D.F. D.G. D.S. D/W DBL. DEMO DIA. or Ø DIAG.	COMBINATION CONCRETE CONSTRUCTION CONTINUOUS CONTRACTOR COPPER PENNY DRINKING FOUNTAIN DECOMPOSED GRANITE DOWN SPOUT DISHWASHER DOUBLE DEMOLITION DIAMETER DIAGONAL	JT. K-D KD KO L.E.D. L.FT. LAM LAT. LAV LD. LINO. LT. LTG. LVL	JOINT KNOCK DOWN KILN DRIED KNOCK OUT LIGHT EMITTING DIODE LINEAR FEET LAMINATE LATERAL LAVATORY LEAD LINEAR LINOLEUM LIGHT LIGHTING LAMINATED VENEER LUMBER	SUSP. SW SYM SYS. T & G T.B. T.M.B. T.O. T.O.B. T.O.C. T.O.F. T.O.J. T.O.M. T.O.S. T.O.W.	SUSPENDED SWITCH SYMMETRICAL SYSTEM TONGUE AND GROOVE THROUGH BOLT TELEPHONE MOUNTING BOA TOP OF TOP OF BEAM TOP OF CURB TOP OF FOOTING TOP OF JOIST TOP OF MASONRY TOP OF SLAB—TOP OF STE TOP OF WALL
COL. COMB. CONC. CONST. CONT. CONTR. CU d D.F. D.G. D.S. D/W DBL. DEMO DIA. or Ø DIAG. DIM. DL DN.	COMBINATION CONCRETE CONSTRUCTION CONTINUOUS CONTRACTOR COPPER PENNY DRINKING FOUNTAIN DECOMPOSED GRANITE DOWN SPOUT DISHWASHER DOUBLE DEMOLITION DIAMETER DIAGONAL DIMENSION DEAD LOAD DOWN	JT. K-D KD KO L.E.D. L.FT. LAM LAT. LAV LD. LINO. LT. LTG. LVL M.B. M.H.	JOINT KNOCK DOWN KILN DRIED KNOCK OUT LIGHT EMITTING DIODE LINEAR FEET LAMINATE LATERAL LAVATORY LEAD LINEAR LINOLEUM LIGHT LIGHTING LAMINATED VENEER LUMBER MACHINE BOLT MANHOLE MALLEABLE IRON	SUSP. SW SYM SYS. T & G T.B. T.M.B. T.O. T.O.B. T.O.C. T.O.F. T.O.J. T.O.M. T.O.S. T.O.W. T.S. T.V. TEL.	SUSPENDED SWITCH SYMMETRICAL SYSTEM TONGUE AND GROOVE THROUGH BOLT TELEPHONE MOUNTING BOA TOP OF TOP OF BEAM TOP OF CURB TOP OF FOOTING TOP OF JOIST TOP OF MASONRY TOP OF SLAB—TOP OF STE TOP OF WALL TUBE STEEL TELEVISION OUTLET TELEPHONE
COL. COMB. CONC. CONST. CONT. CONTR. CU d D.F. D.G. D.S. D/W DBL. DEMO DIA. or Ø DIAG. DIM. DL DN. DR	COMBINATION CONCRETE CONSTRUCTION CONTINUOUS CONTRACTOR COPPER PENNY DRINKING FOUNTAIN DECOMPOSED GRANITE DOWN SPOUT DISHWASHER DOUBLE DEMOLITION DIAMETER DIAGONAL DIMENSION DEAD LOAD DOWN DOOR	JT. K-D KD KO L.E.D. L.FT. LAM LAT. LAV LD. LIN. LINO. LT. LTG. LVL M.B. M.H. M.I.	JOINT KNOCK DOWN KILN DRIED KNOCK OUT LIGHT EMITTING DIODE LINEAR FEET LAMINATE LATERAL LAVATORY LEAD LINEAR LINOLEUM LIGHT LIGHTING LAMINATED VENEER LUMBER MACHINE BOLT MANHOLE MASONRY OPENING	SUSP. SW SYM SYS. T & G T.B. T.M.B. T.O. T.O.B. T.O.C. T.O.F. T.O.J. T.O.M. T.O.S. T.O.W. T.S. T.V. TEL. TH.	SUSPENDED SWITCH SYMMETRICAL SYSTEM TONGUE AND GROOVE THROUGH BOLT TELEPHONE MOUNTING BOA TOP OF TOP OF BEAM TOP OF CURB TOP OF FOOTING TOP OF JOIST TOP OF MASONRY TOP OF SLAB—TOP OF STE TOP OF WALL TUBE STEEL TELEVISION OUTLET TELEPHONE THRESHOLD
COL. COMB. CONC. CONST. CONT. CONTR. CU d D.F. D.G. D.S. D/W DBL. DEMO DIA. or Ø DIAG. DIM. DL DN. DR E.A.	COMBINATION CONCRETE CONSTRUCTION CONTINUOUS CONTRACTOR COPPER PENNY DRINKING FOUNTAIN DECOMPOSED GRANITE DOWN SPOUT DISHWASHER DOUBLE DEMOLITION DIAMETER DIAGONAL DIMENSION DEAD LOAD DOWN DOOR EXPANSION ANCHOR	JT. K-D KD KO L.E.D. L.FT. LAM LAT. LAV LD. LIN. LINO. LT. LTG. LVL M.B. M.H. M.O. MAR.	JOINT KNOCK DOWN KILN DRIED KNOCK OUT LIGHT EMITTING DIODE LINEAR FEET LAMINATE LATERAL LAVATORY LEAD LINEAR LINOLEUM LIGHT LIGHTING LAMINATED VENEER LUMBER MACHINE BOLT MANHOLE MALLEABLE IRON MASONRY OPENING MARBLE	SUSP. SW SYM SYS. T & G T.B. T.M.B. T.O. T.O.B. T.O.C. T.O.F. T.O.J. T.O.M. T.O.S. T.O.W. T.S. T.V. TEL. TH. THD.	SUSPENDED SWITCH SYMMETRICAL SYSTEM TONGUE AND GROOVE THROUGH BOLT TELEPHONE MOUNTING BOA TOP OF TOP OF BEAM TOP OF CURB TOP OF FOOTING TOP OF JOIST TOP OF MASONRY TOP OF SLAB—TOP OF STE TOP OF WALL TUBE STEEL TELEVISION OUTLET TELEPHONE THRESHOLD THREADED
COL. COMB. CONC. CONST. CONT. CONTR. CU d D.F. D.G. D.S. D/W DBL. DEMO DIA. or Ø DIAG. DIM. DL DN. DR	COMBINATION CONCRETE CONSTRUCTION CONTINUOUS CONTRACTOR COPPER PENNY DRINKING FOUNTAIN DECOMPOSED GRANITE DOWN SPOUT DISHWASHER DOUBLE DEMOLITION DIAMETER DIAGONAL DIMENSION DEAD LOAD DOWN DOOR	JT. K-D KD KO L.E.D. L.FT. LAM LAT. LAV LD. LIN. LINO. LT. LTG. LVL M.B. M.H. M.I.	JOINT KNOCK DOWN KILN DRIED KNOCK OUT LIGHT EMITTING DIODE LINEAR FEET LAMINATE LATERAL LAVATORY LEAD LINEAR LINOLEUM LIGHT LIGHTING LAMINATED VENEER LUMBER MACHINE BOLT MANHOLE MASONRY OPENING	SUSP. SW SYM SYS. T & G T.B. T.M.B. T.O. T.O.B. T.O.C. T.O.F. T.O.J. T.O.M. T.O.S. T.O.W. T.S. T.V. TEL. TH.	SUSPENDED SWITCH SYMMETRICAL SYSTEM TONGUE AND GROOVE THROUGH BOLT TELEPHONE MOUNTING BOA TOP OF TOP OF BEAM TOP OF CURB TOP OF FOOTING TOP OF JOIST TOP OF MASONRY TOP OF SLAB—TOP OF STE TOP OF WALL TUBE STEEL TELEVISION OUTLET TELEPHONE THRESHOLD
COL. COMB. CONC. CONST. CONT. CONTR. CU d D.F. D.G. D.S. D/W DBL. DEMO DIA. or Ø DIAG. DIM. DL DN. DR E.A. E.F.	COMBINATION CONCRETE CONSTRUCTION CONTINUOUS CONTRACTOR COPPER PENNY DRINKING FOUNTAIN DECOMPOSED GRANITE DOWN SPOUT DISHWASHER DOUBLE DEMOLITION DIAMETER DIAGONAL DIMENSION DEAD LOAD DOWN DOOR EXPANSION ANCHOR EXHAUST FAN	JT. K-D KD KO L.E.D. L.FT. LAM LAT. LAV LD. LINO. LT. LTG. LVL M.B. M.H. M.I. M.O. MAR. MAS.	JOINT KNOCK DOWN KILN DRIED KNOCK OUT LIGHT EMITTING DIODE LINEAR FEET LAMINATE LATERAL LAVATORY LEAD LINEAR LINOLEUM LIGHT LIGHTING LAMINATED VENEER LUMBER MACHINE BOLT MANHOLE MALLEABLE IRON MASONRY MASONRY	SUSP. SW SYM SYS. T & G T.B. T.M.B. T.O. T.O.B. T.O.C. T.O.F. T.O.J. T.O.M. T.O.S. T.O.W. T.S. T.V. TEL. TH. THD. THK.	SUSPENDED SWITCH SYMMETRICAL SYSTEM TONGUE AND GROOVE THROUGH BOLT TELEPHONE MOUNTING BOA TOP OF TOP OF BEAM TOP OF CURB TOP OF FOOTING TOP OF JOIST TOP OF MASONRY TOP OF SLAB-TOP OF STE TOP OF WALL TUBE STEEL TELEVISION OUTLET TELEPHONE THRESHOLD THREADED THICK
COL. COMB. CONC. CONST. CONT. CONTR. CU d D.F. D.G. D.S. D/W DBL. DEMO DIA. or Ø DIAG. DIM. DL DN. DR E.A. E.F. E.J.	COMBINATION CONCRETE CONSTRUCTION CONTINUOUS CONTRACTOR COPPER PENNY DRINKING FOUNTAIN DECOMPOSED GRANITE DOWN SPOUT DISHWASHER DOUBLE DEMOLITION DIAMETER DIAGONAL DIMENSION DEAD LOAD DOWN DOOR EXPANSION ANCHOR EXHAUST FAN EXPANSION JOINT	JT. K-D KD KO L.E.D. L.FT. LAM LAT. LAV LD. LIN. LINO. LT. LTG. LVL M.B. M.H. M.I. M.O. MAR. MAS. MAT'L	JOINT KNOCK DOWN KILN DRIED KNOCK OUT LIGHT EMITTING DIODE LINEAR FEET LAMINATE LATERAL LAVATORY LEAD LINEAR LINOLEUM LIGHT LIGHTING LAMINATED VENEER LUMBER MACHINE BOLT MANHOLE MALLEABLE IRON MASONRY OPENING MATERIAL	SUSP. SW SYM SYS. T & G T.B. T.M.B. T.O. T.O.B. T.O.C. T.O.F. T.O.J. T.O.M. T.O.S. T.O.W. T.S. T.V. TEL. TH. THD. THK. THRU	SUSPENDED SWITCH SYMMETRICAL SYSTEM TONGUE AND GROOVE THROUGH BOLT TELEPHONE MOUNTING BOA TOP OF TOP OF BEAM TOP OF CURB TOP OF FOOTING TOP OF JOIST TOP OF MASONRY TOP OF SLAB—TOP OF STE TOP OF WALL TUBE STEEL TELEVISION OUTLET TELEPHONE THRESHOLD THREADED THICK THROUGH
COL. COMB. CONC. CONST. CONT. CONTR. CU d D.F. D.G. D.S. D/W DBL. DEMO DIAG. DIM. DL DN. DR E.A. E.F. E.J. E.N. E.W. EA.	COMBINATION CONCRETE CONSTRUCTION CONTINUOUS CONTRACTOR COPPER PENNY DRINKING FOUNTAIN DECOMPOSED GRANITE DOWN SPOUT DISHWASHER DOUBLE DEMOLITION DIAMETER DIAGONAL DIMENSION DEAD LOAD DOWN DOOR EXPANSION ANCHOR EXHAUST FAN EXPANSION JOINT END NAILING EACH	JT. K-D KD KO L.E.D. L.FT. LAM LAT. LAV LD. LINO. LT. LTG. LVL M.B. M.H. M.I. M.O. MAR. MAS. MAT'L MAX. MECH. MED.	JOINT KNOCK DOWN KILN DRIED KNOCK OUT LIGHT EMITTING DIODE LINEAR FEET LAMINATE LATERAL LAVATORY LEAD LINEAR LINOLEUM LIGHT LIGHTING LAMINATED VENEER LUMBER MACHINE BOLT MANHOLE MALLEABLE IRON MASONRY OPENING MASONRY MATERIAL MAXIMUM MECHANICAL MEDIUM	SUSP. SW SYM SYS. T & G T.B. T.M.B. T.O. T.O.B. T.O.C. T.O.F. T.O.J. T.O.W. T.S. T.V. TEL. TH. THD. THK. THRU TLT. TRANS. TYP.	SUSPENDED SWITCH SYMMETRICAL SYSTEM TONGUE AND GROOVE THROUGH BOLT TELEPHONE MOUNTING BOA TOP OF TOP OF BEAM TOP OF CURB TOP OF FOOTING TOP OF JOIST TOP OF SLAB—TOP OF STE TOP OF WALL TUBE STEEL TELEVISION OUTLET TELEPHONE THRESHOLD THREADED THICK THROUGH TOILET TRANSFORMER TYPICAL
COL. COMB. CONC. CONST. CONT. CONTR. CU d D.F. D.G. D.S. D/W DBL. DEMO DIA. or Ø DIAG. DIM. DL DN. DR E.A. E.F. E.J. E.W. EA. EL	COMBINATION CONCRETE CONSTRUCTION CONTINUOUS CONTRACTOR COPPER PENNY DRINKING FOUNTAIN DECOMPOSED GRANITE DOWN SPOUT DISHWASHER DOUBLE DEMOLITION DIAMETER DIAGONAL DIMENSION DEAD LOAD DOWN DOOR EXPANSION ANCHOR EXHAUST FAN EXPANSION JOINT END NAILING EACH ELEVATION	JT. K-D KD KO L.E.D. L.FT. LAM LAT. LAV LD. LINO. LT. LTG. LVL M.B. M.H. M.I. M.O. MAR. MAS. MAT'L MAX. MECH. MFG.	JOINT KNOCK DOWN KILN DRIED KNOCK OUT LIGHT EMITTING DIODE LINEAR FEET LAMINATE LATERAL LAVATORY LEAD LINEAR LINOLEUM LIGHT LIGHTING LAMINATED VENEER LUMBER MACHINE BOLT MANHOLE MALLEABLE IRON MASONRY OPENING MARBLE MASONRY MATERIAL MAXIMUM MECHANICAL MEDIUM MANUFACTURING	SUSP. SW SYM SYS. T & G T.B. T.M.B. T.O. T.O.B. T.O.C. T.O.F. T.O.J. T.O.M. T.O.S. T.O.W. T.S. T.V. TEL. TH. THD. THK. THRU TLT. TRANS. TYP. UNF.	SUSPENDED SWITCH SYMMETRICAL SYSTEM TONGUE AND GROOVE THROUGH BOLT TELEPHONE MOUNTING BOA TOP OF BEAM TOP OF CURB TOP OF FOOTING TOP OF JOIST TOP OF MASONRY TOP OF SLAB—TOP OF STE TOP OF WALL TUBE STEEL TELEVISION OUTLET TELEPHONE THRESHOLD THREADED THICK THROUGH TOILET TRANSFORMER TYPICAL UNFINISHED
COL. COMB. CONC. CONST. CONT. CONTR. CU d D.F. D.G. D.S. D/W DBL. DEMO DIA. or Ø DIAG. DIM. DL DN. DR E.A. E.F. E.J. E.W. EA. EL ELECT.	COMBINATION CONCRETE CONSTRUCTION CONTINUOUS CONTRACTOR COPPER PENNY DRINKING FOUNTAIN DECOMPOSED GRANITE DOWN SPOUT DISHWASHER DOUBLE DEMOLITION DIAMETER DIAGONAL DIMENSION DEAD LOAD DOWN DOOR EXPANSION ANCHOR EXPANSION JOINT END NAILING EACH WAY EACH ELEVATION "ELECTRIC, ELECTRICAL"	JT. K-D KD KO L.E.D. L.FT. LAM LAT. LAV LD. LIN. LINO. LT. LTG. LVL M.B. M.H. M.I. M.O. MAR. MAS. MAT'L MAX. MECH. MFG. MFG.	JOINT KNOCK DOWN KILN DRIED KNOCK OUT LIGHT EMITTING DIODE LINEAR FEET LAMINATE LATERAL LAVATORY LEAD LINEAR LINOLEUM LIGHT LIGHTING LAMINATED VENEER LUMBER MACHINE BOLT MANHOLE MALLEABLE IRON MASONRY OPENING MARBLE MASONRY MATERIAL MAXIMUM MECHANICAL MEDIUM MANUFACTURING MANUFACTURING MANUFACTURING MANUFACTURING	SUSP. SW SYM SYS. T & G T.B. T.M.B. T.O. T.O.B. T.O.C. T.O.F. T.O.J. T.O.M. T.O.S. T.O.W. T.S. T.V. TEL. TH. THD. THK. THRU TLT. TRANS. TYP. UNF.	SUSPENDED SWITCH SYMMETRICAL SYSTEM TONGUE AND GROOVE THROUGH BOLT TELEPHONE MOUNTING BOA TOP OF TOP OF BEAM TOP OF CURB TOP OF FOOTING TOP OF MASONRY TOP OF SLAB-TOP OF STE TOP OF WALL TUBE STEEL TELEVISION OUTLET TELEPHONE THRESHOLD THREADED THICK THROUGH TOILET TRANSFORMER TYPICAL UNFINISHED UNLESS NOTED OTHERWISE
COL. COMB. CONC. CONST. CONT. CU d D.F. D.G. D.S. D/W DBL. DEMO DIA. or Ø DIAG. DIM. DR E.A. E.F. E.J. E.N. E.W. EA. EL ELECT. ELEEV.	COMBINATION CONCRETE CONSTRUCTION CONTINUOUS CONTRACTOR COPPER PENNY DRINKING FOUNTAIN DECOMPOSED GRANITE DOWN SPOUT DISHWASHER DOUBLE DEMOLITION DIAMETER DIAGONAL DIMENSION DEAD LOAD DOWN DOOR EXPANSION ANCHOR EXHAUST FAN EXPANSION JOINT END NAILING EACH WAY EACH ELEVATION "ELECTRIC, ELECTRICAL" ELEVATOR	JT. K-D KD KO L.E.D. L.FT. LAM LAT. LAV LD. LINO. LT. LTG. LVL M.B. M.H. M.I. M.O. MAR. MAS. MAT'L MAX. MECH. MFG. MFR. MIN.	JOINT KNOCK DOWN KILN DRIED KNOCK OUT LIGHT EMITTING DIODE LINEAR FEET LAMINATE LATERAL LAVATORY LEAD LINEAR LINOLEUM LIGHT LIGHTING LAMINATED VENEER LUMBER MACHINE BOLT MANHOLE MALLEABLE IRON MASONRY OPENING MARBLE MASONRY MATERIAL MAXIMUM MECHANICAL MEDIUM MANUFACTURING MANUFACTURING MANUFACTURING MANUFACTURING MANUFACTURING MANUFACTURING MANUFACTURING MANUFACTURING MANUFACTURING MINIMUM	SUSP. SW SYM SYS. T & G T.B. T.M.B. T.O. T.O.B. T.O.C. T.O.F. T.O.J. T.O.W. T.S. T.V. TEL. TH. THD. THK. THRU TLT. TRANS. TYP. UNF. U.N.O.	SUSPENDED SWITCH SYMMETRICAL SYSTEM TONGUE AND GROOVE THROUGH BOLT TELEPHONE MOUNTING BOA TOP OF TOP OF BEAM TOP OF CURB TOP OF FOOTING TOP OF JOIST TOP OF SLAB—TOP OF STE TOP OF WALL TUBE STEEL TELEVISION OUTLET TELEPHONE THRESHOLD THREADED THICK THROUGH TOILET TRANSFORMER TYPICAL UNFINISHED UNLESS NOTED OTHERWISE URINAL
COL. COMB. CONC. CONST. CONTR. CU d D.F. D.G. D.S. D/W DBL. DEMO DIA. or Ø DIM. DL DN. DR E.A. E.F. E.J. E.N. E.W. EA. EL ELECT.	COMBINATION CONCRETE CONSTRUCTION CONTINUOUS CONTRACTOR COPPER PENNY DRINKING FOUNTAIN DECOMPOSED GRANITE DOWN SPOUT DISHWASHER DOUBLE DEMOLITION DIAMETER DIAGONAL DIMENSION DEAD LOAD DOWN DOOR EXPANSION ANCHOR EXPANSION JOINT END NAILING EACH WAY EACH ELEVATION "ELECTRIC, ELECTRICAL"	JT. K-D KD KO L.E.D. L.FT. LAM LAT. LAV LD. LIN. LINO. LT. LTG. LVL M.B. M.H. M.I. M.O. MAR. MAS. MAT'L MAX. MECH. MFG. MFG.	JOINT KNOCK DOWN KILN DRIED KNOCK OUT LIGHT EMITTING DIODE LINEAR FEET LAMINATE LATERAL LAVATORY LEAD LINEAR LINOLEUM LIGHT LIGHTING LAMINATED VENEER LUMBER MACHINE BOLT MANHOLE MALLEABLE IRON MASONRY OPENING MARBLE MASONRY MATERIAL MAXIMUM MECHANICAL MEDIUM MANUFACTURING MANUFACTURING MANUFACTURING MANUFACTURING	SUSP. SW SYM SYS. T & G T.B. T.M.B. T.O. T.O.B. T.O.C. T.O.F. T.O.J. T.O.M. T.O.S. T.O.W. T.S. T.V. TEL. TH. THD. THK. THRU TLT. TRANS. TYP. UNF.	SUSPENDED SWITCH SYMMETRICAL SYSTEM TONGUE AND GROOVE THROUGH BOLT TELEPHONE MOUNTING BOA TOP OF TOP OF BEAM TOP OF CURB TOP OF FOOTING TOP OF MASONRY TOP OF SLAB-TOP OF STE TOP OF WALL TUBE STEEL TELEVISION OUTLET TELEPHONE THRESHOLD THREADED THICK THROUGH TOILET TRANSFORMER TYPICAL UNFINISHED UNLESS NOTED OTHERWISE
COL. COMB. CONC. CONST. CONT. CONTR. CU d D.F. D.G. D.S. D/W DBL. DEMO DIA. or Ø DIAG. DIM. DL DN. DR E.A. E.F. E.J. E.N. E.W. EA. ELECT. ELEV. EMC	COMBINATION CONCRETE CONSTRUCTION CONTINUOUS CONTRACTOR COPPER PENNY DRINKING FOUNTAIN DECOMPOSED GRANITE DOWN SPOUT DISHWASHER DOUBLE DEMOLITION DIAMETER DIAGONAL DIMENSION DEAD LOAD DOWN DOOR EXPANSION ANCHOR EXHAUST FAN EXPANSION JOINT END NAILING EACH WAY EACH ELEVATION "ELECTRICAL METALLIC CONDUIT	JT. K-D KD KO L.E.D. L.FT. LAM LAT. LAV LD. LINO. LT. LTG. LVL M.B. M.H. M.I. M.O. MAR. MAS. MAT'L MED. MFG. MFR. MIN. MISC.	JOINT KNOCK DOWN KILN DRIED KNOCK OUT LIGHT EMITTING DIODE LINEAR FEET LAMINATE LATERAL LAVATORY LEAD LINEAR LINOLEUM LIGHT LIGHTING LAMINATED VENEER LUMBER MACHINE BOLT MANHOLE MALLEABLE IRON MASONRY OPENING MARBLE MASONRY MATERIAL MAXIMUM MECHANICAL MEDIUM MANUFACTURER MINIMUM MISCELLANEOUS	SUSP. SW SYM SYS. T & G T.B. T.M.B. T.O. T.O.B. T.O.C. T.O.F. T.O.J. T.O.W. T.O.S. T.O.W. T.S. T.V. TEL. TH. THD. THK. THRU TLT. TRANS. TYP. UNF. U.N.O. UR	SUSPENDED SWITCH SYMMETRICAL SYSTEM TONGUE AND GROOVE THROUGH BOLT TELEPHONE MOUNTING BOA TOP OF TOP OF BEAM TOP OF FOOTING TOP OF JOIST TOP OF MASONRY TOP OF SLAB—TOP OF STE TOP OF WALL TUBE STEEL TELEVISION OUTLET TELEPHONE THRESHOLD THREADED THICK THROUGH TOILET TRANSFORMER TYPICAL UNFINISHED URINAL VAPOR BARRIER
COL. COMB. CONC. CONST. CONT. CONTR. CU d D.F. D.G. D.S. D/W DBL. DEMO DIA. or Ø DIAG. DIM. DL DN. E.A. E.F. E.J. E.W. EA. EL ELECT. ELECV. EMC EMT	COMBINATION CONCRETE CONSTRUCTION CONTINUOUS CONTRACTOR COPPER PENNY DRINKING FOUNTAIN DECOMPOSED GRANITE DOWN SPOUT DISHWASHER DOUBLE DEMOLITION DIAMETER DIAGONAL DIMENSION DEAD LOAD DOWN DOOR EXPANSION ANCHOR EXPANSION JOINT END NAILING EACH WAY EACH ELEVATION TELECTRICAL METALLIC CONDUIT ELECTRICAL METALLIC TUBING	JT. K-D KD KO L.E.D. L.FT. LAM LAT. LAV LD. LIN. LINO. LT. LTG. LVL M.B. M.H. M.I. M.O. MAR. MAS. MAT'L MAX. MECH. MFG. MIN. MISC. MOD	JOINT KNOCK DOWN KILN DRIED KNOCK OUT LIGHT EMITTING DIODE LINEAR FEET LAMINATE LATERAL LAVATORY LEAD LINEAR LINOLEUM LIGHT LIGHTING LAMINATED VENEER LUMBER MACHINE BOLT MANHOLE MALLEABLE IRON MASONRY OPENING MARBLE MASONRY MATERIAL MAXIMUM MECHANICAL MEDIUM MANUFACTURING MANUFACTURING MISCELLANEOUS MODULAR	SUSP. SW SYM SYS. T & G T.B. T.M.B. T.O. T.O.B. T.O.C. T.O.F. T.O.J. T.O.M. T.O.S. T.O.W. T.S. T.V. TEL. TH. THD. THK. THRU TLT. TRANS. TYP. UNF. U.N.O. UR V.B. V.I.F.	SUSPENDED SWITCH SYMMETRICAL SYSTEM TONGUE AND GROOVE THROUGH BOLT TELEPHONE MOUNTING BOA TOP OF TOP OF BEAM TOP OF CURB TOP OF FOOTING TOP OF JOIST TOP OF MASONRY TOP OF SLAB—TOP OF STE TOP OF WALL TUBE STEEL TELEVISION OUTLET TELEPHONE THREADED THICK THROUGH TOILET TRANSFORMER TYPICAL UNFINISHED UNLESS NOTED OTHERWISE URINAL VAPOR BARRIER
COL. COMB. CONC. CONST. CONT. CONTR. CU d D.F. D.G. D.S. D/W DBL. DEMO DIA. or Ø DIAG. DIM. DL DN. E.A. E.F. E.J. E.J. E.W. EA. ELECT. ELECT. ELECT. EMC EMT EQ. EQUIP.	COMBINATION CONCRETE CONSTRUCTION CONTINUOUS CONTRACTOR COPPER PENNY DRINKING FOUNTAIN DECOMPOSED GRANITE DOWN SPOUT DISHWASHER DOUBLE DEMOLITION DIAMETER DIAGONAL DIMENSION DEAD LOAD DOWN DOOR EXPANSION ANCHOR EXHAUST FAN EXPANSION JOINT END NAILING EACH WAY EACH ELEVATION "ELECTRIC, ELECTRICAL" ELECTRICAL METALLIC TUBING EQUIPMENT	JT. K-D KD KO L.E.D. L.FT. LAM LAT. LAV LD. LINO. LT. LTG. LVL M.B. M.H. M.I. M.O. MAR. MAS. MAT'L MAX. MECH. MFG. MIN. MISC. MOD MTL. MUL N.I.C.	JOINT KNOCK DOWN KILN DRIED KNOCK OUT LIGHT EMITTING DIODE LINEAR FEET LAMINATE LATERAL LAVATORY LEAD LINEAR LINOLEUM LIGHT LIGHTING LAMINATED VENEER LUMBER MACHINE BOLT MANHOLE MALLEABLE IRON MASONRY OPENING MARBLE MASONRY MATERIAL MAXIMUM MECHANICAL MEDIUM MISCELLANEOUS MODULAR METAL MULLION NOT IN CONTRACT	SUSP. SW SYM SYS. T & G T.B. T.M.B. T.O. T.O.B. T.O.C. T.O.F. T.O.J. T.O.M. T.O.S. T.O.W. T.S. T.V. TEL. TH. THD. THK. THRU TLT. TRANS. TYP. UNF. U.N.O. UR V.B. V.I.F. VA	SUSPENDED SWITCH SYMMETRICAL SYSTEM TONGUE AND GROOVE THROUGH BOLT TELEPHONE MOUNTING BOA TOP OF BEAM TOP OF CURB TOP OF FOOTING TOP OF JOIST TOP OF MASONRY TOP OF SLAB—TOP OF STE TOP OF WALL TUBE STEEL TELEVISION OUTLET TELEPHONE THRESHOLD THREADED THICK THROUGH TOILET TRANSFORMER TYPICAL UNFINISHED UNLESS NOTED OTHERWISE URINAL VAPOR BARRIER VERIFY IN FIELD VOLT AMPERE VINYL COMPOSITION TILE VERTICAL
COL. COMB. CONC. CONST. CONTR. CU d D.F. D.G. D.S. D/W DBL. DEMO DIA. or Ø DIAG. DIM. DL DN. DR E.A. E.F. E.J. E.N. E.W. EA. ELECT. ELEV. EMC EMT EQ. EQUIP. EST.	COMBINATION CONCRETE CONSTRUCTION CONTINUOUS CONTRACTOR COPPER PENNY DRINKING FOUNTAIN DECOMPOSED GRANITE DOWN SPOUT DISHWASHER DOUBLE DEMOLITION DIAMETER DIAGONAL DIMENSION DEAD LOAD DOWN DOOR EXPANSION ANCHOR EXPANSION ANCHOR EXHAUST FAN EXPANSION JOINT END NAILING EACH WAY EACH ELEVATION "ELECTRICAL METALLIC TUBING EQUIPMENT EQUIPMENT EQUIPMENT ESTIMATE	JT. K-D KD KO L.E.D. L.FT. LAM LAT. LAV LD. LIN. LINO. LT. LTG. LVL M.B. M.H. M.I. M.O. MAR. MAS. MAT'L MAX. MECH. MFG. MFR. MIN. MISC. MOD MTL. MUL N.T.S.	JOINT KNOCK DOWN KILN DRIED KNOCK OUT LIGHT EMITTING DIODE LINEAR FEET LAMINATE LATERAL LAVATORY LEAD LINEAR LINOLEUM LIGHT LIGHTING LAMINATED VENEER LUMBER MACHINE BOLT MANHOLE MALLEABLE IRON MASONRY OPENING MARBLE MASONRY MATERIAL MAXIMUM MECHANICAL MEDIUM MANUFACTURING MANUFACTURING MISCELLANEOUS MODULAR METAL MULLION NOT IN CONTRACT NOT TO SCALE	SUSP. SW SYM SYS. T & G T.B. T.M.B. T.O. T.O.B. T.O.C. T.O.F. T.O.J. T.O.W. T.O.S. T.V. TEL. TH. THD. THK. THRU TLT. TRANS. TYP. UNF. UNF. UNF. VA VCT VERT. V.O.J.	SUSPENDED SWITCH SYMMETRICAL SYSTEM TONGUE AND GROOVE THROUGH BOLT TELEPHONE MOUNTING BOY TOP OF TOP OF BEAM TOP OF CURB TOP OF FOOTING TOP OF MASONRY TOP OF SLAB-TOP OF STI TOP OF WALL TUBE STEEL TELEVISION OUTLET TELEPHONE THREADED THICK THROUGH TOILET TRANSFORMER TYPICAL UNFINISHED UNLESS NOTED OTHERWISE URINAL VAPOR BARRIER VERIFY IN FIELD VOLT AMPERE VINYL COMPOSITION TILE VERIFY ON JOB
COL. COMB. CONC. CONST. CONT. CU d D.F. D.G. D.S. D/W DBL. DEMO DIA. or Ø DIAG. DIM. DL E.A. E.F. E.J. E.N. E.W. EA. ELECT. ELECT. ELEV. EMC EMT ENT EQ. EQUIP.	COMBINATION CONCRETE CONSTRUCTION CONTINUOUS CONTRACTOR COPPER PENNY DRINKING FOUNTAIN DECOMPOSED GRANITE DOWN SPOUT DISHWASHER DOUBLE DEMOLITION DIAMETER DIAGONAL DIMENSION DEAD LOAD DOWN DOOR EXPANSION ANCHOR EXHAUST FAN EXPANSION JOINT END NAILING EACH WAY EACH ELEVATION "ELECTRICAL METALLIC CONDUIT ELECTRICAL METALLIC TUBING EQUAL EQUIPMENT ESTIMATE EVAPORATIVE COOLER	JT. K-D KD KO L.E.D. L.FT. LAM LAT. LAV LD. LINO. LT. LTG. LVL M.B. M.H. M.I. M.O. MAR. MAS. MAT'L MAX. MECH. MED. MFG. MFR. MIN. MISC. MOD MTL. MUL N.I.C. N.T.S. NCM	JOINT KNOCK DOWN KILN DRIED KNOCK OUT LIGHT EMITTING DIODE LINEAR FEET LAMINATE LATERAL LAVATORY LEAD LINEAR LINOLEUM LIGHT LIGHTING LAMINATED VENEER LUMBER MACHINE BOLT MANHOLE MALLEABLE IRON MASONRY OPENING MARBLE MASONRY MATERIAL MAXIMUM MECHANICAL MEDIUM MINIMUM MISCELLANEOUS MODULAR METAL MULLION NOT TO SCALE NON—CORROSIVE METAL	SUSP. SW SYM SYS. T & G T.B. T.M.B. T.O. T.O.B. T.O.C. T.O.F. T.O.J. T.O.W. T.O.S. T.O.W. T.S. T.V. TEL. TH. THD. THK. THRU TLT. TRANS. TYP. UNF. UNF. UNF. VA VCT VERT. V.O.J. W/C	SUSPENDED SWITCH SYMMETRICAL SYSTEM TONGUE AND GROOVE THROUGH BOLT TELEPHONE MOUNTING BOX TOP OF TOP OF BEAM TOP OF CURB TOP OF FOOTING TOP OF SLAB—TOP OF STI TOP OF WALL TUBE STEEL TELEVISION OUTLET TELEPHONE THREADED THICK THROUGH TOILET TRANSFORMER TYPICAL UNFINISHED UNILESS NOTED OTHERWISE URINAL VAPOR BARRIER VERIFY IN FIELD VERTICAL VERIFY ON JOB WATER CLOSET
COL. COMB. CONC. CONST. CONTR. CU d D.F. D.G. D.S. D/W DBL. DEMO DIA. or Ø DIAG. DIM. DL DN. DR E.A. E.F. E.J. E.N. E.W. EA. ELECT. ELEV. EMC EMT EQ. EQUIP. EST.	COMBINATION CONCRETE CONSTRUCTION CONTINUOUS CONTRACTOR COPPER PENNY DRINKING FOUNTAIN DECOMPOSED GRANITE DOWN SPOUT DISHWASHER DOUBLE DEMOLITION DIAMETER DIAGONAL DIMENSION DEAD LOAD DOWN DOOR EXPANSION ANCHOR EXPANSION ANCHOR EXHAUST FAN EXPANSION JOINT END NAILING EACH WAY EACH ELEVATION "ELECTRICAL METALLIC TUBING EQUIPMENT EQUIPMENT EQUIPMENT ESTIMATE	JT. K-D KD KO L.E.D. L.FT. LAM LAT. LAV LD. LIN. LINO. LT. LTG. LVL M.B. M.H. M.I. M.O. MAR. MAS. MAT'L MAX. MECH. MFG. MFR. MIN. MISC. MOD MTL. MUL N.T.S.	JOINT KNOCK DOWN KILN DRIED KNOCK OUT LIGHT EMITTING DIODE LINEAR FEET LAMINATE LATERAL LAVATORY LEAD LINEAR LINOLEUM LIGHT LIGHTING LAMINATED VENEER LUMBER MACHINE BOLT MANHOLE MALLEABLE IRON MASONRY OPENING MARBLE MASONRY MATERIAL MAXIMUM MECHANICAL MEDIUM MANUFACTURING MANUFACTURING MISCELLANEOUS MODULAR METAL MULLION NOT IN CONTRACT NOT TO SCALE	SUSP. SW SYM SYS. T & G T.B. T.M.B. T.O. T.O.B. T.O.C. T.O.F. T.O.J. T.O.W. T.O.S. T.V. TEL. TH. THD. THK. THRU TLT. TRANS. TYP. UNF. UNF. UNF. VA VCT VERT. V.O.J.	SUSPENDED SWITCH SYMMETRICAL SYSTEM TONGUE AND GROOVE THROUGH BOLT TELEPHONE MOUNTING BOY TOP OF TOP OF BEAM TOP OF CURB TOP OF FOOTING TOP OF MASONRY TOP OF SLAB-TOP OF STI TOP OF WALL TUBE STEEL TELEVISION OUTLET TELEPHONE THREADED THICK THROUGH TOILET TRANSFORMER TYPICAL UNFINISHED UNLESS NOTED OTHERWISE URINAL VAPOR BARRIER VERIFY IN FIELD VOLT AMPERE VINYL COMPOSITION TILE VERIFY ON JOB
COL. COMB. CONC. CONST. CONT. CONTR. CU d D.F. D.G. D.S. D/W DBL. DEMO DIA. or Ø DIAG. DIM. DL DN. E.A. E.F. E.J. E.N. E.W. EA. ELECT. ELECT. ELECT. ELECT. ELECT. EMC EMT ENT EQ. EQUIP. EST. EVAP. EVAP.	COMBINATION CONCRETE CONSTRUCTION CONTINUOUS CONTRACTOR COPPER PENNY DRINKING FOUNTAIN DECOMPOSED GRANITE DOWN SPOUT DISHWASHER DOUBLE DEMOLITION DIAMETER DIAGONAL DIMENSION DEAD LOAD DOWN DOOR EXPANSION ANCHOR EXHAUST FAN EXPANSION JOINT END NAILING EACH WAY EACH ELEVATION "ELECTRICAL METALLIC TUBING EQUAL EQUIPMENT ESTIMATE EVAPORATIVE COOLER ELECTRICA DINIKING COOLER	JT. K-D KD KO L.E.D. L.FT. LAM LAT. LAV LD. LINO. LT. LTG. LVL M.B. M.H. M.I. M.O. MAR. MAS. MAT'L MED. MFG. MFR. MIN. MISC. MUL N.I.C. N.T.S. NCM NFC	JOINT KNOCK DOWN KILN DRIED KNOCK OUT LIGHT EMITTING DIODE LINEAR FEET LAMINATE LATERAL LAVATORY LEAD LINEAR LINOLEUM LIGHT LIGHTING LAMINATED VENEER LUMBER MACHINE BOLT MANHOLE MALLEABLE IRON MASONRY OPENING MARBLE MASONRY MATERIAL MAXIMUM MECHANICAL MEDIUM MINIMUM MISCELLANEOUS MODULAR METAL MULLION NOT IN CONTRACT NOT TO SCALE NON—CORROSIVE METAL NOT FOR CONSTRUCTION	SUSP. SW SYM SYS. T & G T.B. T.M.B. T.O. T.O.B. T.O.C. T.O.F. T.O.J. T.O.W. T.O.S. T.O.W. T.S. T.V. TEL. TH. THD. THK. THRU TLT. TRANS. TYP. UNF. UNF. UNO. UR V.B. V.I.F. VA VCT VERT. V.O.J. W/C WDW	SUSPENDED SWITCH SYMMETRICAL SYSTEM TONGUE AND GROOVE THROUGH BOLT TELEPHONE MOUNTING BOX TOP OF TOP OF BEAM TOP OF FOOTING TOP OF JOIST TOP OF MASONRY TOP OF SLAB—TOP OF STI TOP OF WALL TUBE STEEL TELEVISION OUTLET TELEPHONE THRESHOLD THREADED THICK THROUGH TOILET TRANSFORMER TYPICAL UNFINISHED UNLESS NOTED OTHERWISE URINAL VAPOR BARRIER VERIFY IN FIELD VOLT AMPERE VINYL COMPOSITION TILE VERTICAL VERIFY ON JOB WATER CLOSET WINDOW
COL. COMB. CONC. CONST. CONTR. CU d D.F. D.G. D.S. D/W DBL. DEMO DIA. or Ø DIAG. DIM. DL DN. DR E.A. E.F. E.J. E.N. E.W. EA. ELECT. ELEV. EMC EMT EQ. EQUIP. EST. EVAP.	COMBINATION CONCRETE CONSTRUCTION CONTINUOUS CONTRACTOR COPPER PENNY DRINKING FOUNTAIN DECOMPOSED GRANITE DOWN SPOUT DISHWASHER DOUBLE DEMOLITION DIAMETER DIAGONAL DIMENSION DEAD LOAD DOWN DOOR EXPANSION ANCHOR EXPANSION ANCHOR EXHAUST FAN EXPANSION JOINT END NAILING EACH WAY EACH ELEVATION "ELECTRICAL METALLIC TUBING EQUAL EQUIPMENT ESTIMATE EVAPORATIVE COOLER ELECTRIC DRINKING COOLER EXCAVATE	JT. K-D KD KO L.E.D. L.FT. LAM LAT. LAV LD. LINO. LT. LTG. LVL M.B. M.H. M.I. M.O. MAR. MAS. MAT'L MAX. MECH. MED. MFG. MFR. MIN. MISC. MOD MTL. N.I.C. N.T.S. NCM NFC NLR.	JOINT KNOCK DOWN KILN DRIED KNOCK OUT LIGHT EMITTING DIODE LINEAR FEET LAMINATE LATERAL LAVATORY LEAD LINEAR LINOLEUM LIGHT LIGHTING LAMINATED VENEER LUMBER MACHINE BOLT MANHOLE MALLEABLE IRON MASONRY OPENING MARBLE MASONRY MATERIAL MAXIMUM MECHANICAL MEDIUM MANUFACTURING MANUFACTURING MANUFACTURING MANUFACTURING MODULAR METAL MULLION NOT IN CONTRACT NOT TO SCALE NON—CORROSIVE METAL NOT FOR CONSTRUCTION NAILER	SUSP. SW SYM SYS. T & G T.B. T.M.B. T.O. T.O.B. T.O.C. T.O.F. T.O.J. T.O.W. T.O.S. T.O.W. T.S. T.V. TEL. TH. THD. THK. THRU TLT. TRANS. TYP. UNF. UNF. UNF. VA VCT VERT. V.O.J. W/C WDW WCT	SUSPENDED SWITCH SYMMETRICAL SYSTEM TONGUE AND GROOVE THROUGH BOLT TELEPHONE MOUNTING BOA TOP OF TOP OF BEAM TOP OF CURB TOP OF FOOTING TOP OF JOIST TOP OF MASONRY TOP OF SLAB—TOP OF STE TOP OF WALL TUBE STEEL TELEVISION OUTLET TELEPHONE THREADED THICK THROUGH TOILET TRANSFORMER TYPICAL UNFINISHED UNLESS NOTED OTHERWISE URINAL VAPOR BARRIER VERIFY IN FIELD VOLT AMPERE VINYL COMPOSITION TILE VERTICAL VERIFY ON JOB WATER CLOSET WINDOW
COL. COMB. CONC. CONST. CONTR. CU d D.F. D.G. D.S. D/W DBL. DEMO DIA. or Ø DIAG. DIM. DL DN. E.A. E.F. E.J. E.N. E.W. EA. ELECT. ELECT. ELECT. ELEV. EMC EMT EQ. EQUIP. EST. EVAP. EWC EXIST. EXIST. EXIST. EXIST. EXIST.	COMBINATION CONCRETE CONSTRUCTION CONTINUOUS CONTRACTOR COPPER PENNY DRINKING FOUNTAIN DECOMPOSED GRANITE DOWN SPOUT DISHWASHER DOUBLE DEMOLITION DIAMETER DIAGONAL DIMENSION DEAD LOAD DOWN DOOR EXPANSION ANCHOR EXHAUST FAN EXPANSION JOINT END NAILING EACH WAY EACH ELEVATION "ELECTRIC, ELECTRICAL" ELEVATOR ELECTRICAL METALLIC TUBING EQUIPMENT ESTIMATE EVAPORATIVE COOLER EXCAVATE EXTERIOR	JT. K-D KD KO L.E.D. L.FT. LAM LAT. LAV LD. LINO. LT. LTG. LVL M.B. M.H. M.I. M.O. MAR. MAS. MAT'L MAX. MECH. MED. MFG. MFR. MIN. MISC. MOD MTL. N.I.C. N.T.S. NCM NFC NLR. NO. NOM. O.C.	JOINT KNOCK DOWN KILN DRIED KNOCK OUT LIGHT EMITTING DIODE LINEAR FEET LAMINATE LATERAL LAVATORY LEAD LINEAR LINOLEUM LIGHT LIGHTING LAMINATED VENEER LUMBER MACHINE BOLT MANHOLE MALLEABLE IRON MASONRY OPENING MARBLE MASONRY MATERIAL MAXIMUM MECHANICAL MEDIUM MISCELLANEOUS MODULAR MISCELLANEOUS MODULAR METAL MULLION NOT IN CONTRACT NOT TO SCALE NON—CORROSIVE METAL NOT FOR CONSTRUCTION NAILER NUMBER NOMINAL ON CENTER	SUSP. SW SYM SYS. T & G T.B. T.M.B. T.O. T.O.B. T.O.C. T.O.F. T.O.J. T.O.W. T.O.S. T.O.W. T.S. T.V. TEL. TH. THD. THK. THRU TLT. TRANS. TYP. UNF. UNF. UNF. VA VCT VERT. V.O.J. W/C WDW WCT WP WT. W/	SUSPENDED SWITCH SYMMETRICAL SYSTEM TONGUE AND GROOVE THROUGH BOLT TELEPHONE MOUNTING BOA TOP OF BEAM TOP OF CURB TOP OF FOOTING TOP OF JOIST TOP OF SLAB—TOP OF STE TOP OF WALL TUBE STEEL TELEVISION OUTLET TELEPHONE THRESHOLD THREADED THICK THROUGH TOILET TRANSFORMER TYPICAL UNFINISHED UNLESS NOTED OTHERWISE URINAL VAPOR BARRIER VERIFY IN FIELD VOLT AMPERE VINYL COMPOSITION TILE VERTICAL VERIFY ON JOB WATER CLOSET WINDOW WAINSCOT WEATHER PROOF
COL. COMB. CONC. CONST. CONTR. CU d D.F. D.G. D.S. D/W DBL. DEMO DIA. or Ø DIAG. DIM. DL DN. DR E.A. E.F. E.J. E.N. E.W. EA. ELECT. ELEV. EMC EMT ENT EQ. EQUIP. EST. EVAP. EXC EXT. EXT. F.A.	COMBINATION CONCRETE CONSTRUCTION CONTINUOUS CONTRACTOR COPPER PENNY DRINKING FOUNTAIN DECOMPOSED GRANITE DOWN SPOUT DISHWASHER DOUBLE DEMOLITION DIAMETER DIAGONAL DIMENSION DEAD LOAD DOWN DOOR EXPANSION ANCHOR EXHAUST FAN EXPANSION JOINT END NAILING EACH WAY EACH ELEVATION "ELECTRICAL METALLIC CONDUIT ELECTRICAL METALLIC TUBING EQUAL EQUIPMENT ESTIMATE EVAPORATIVE COOLER EXCAVATE EXHAUST EXHAUST EXHAUST EXHAUST ESTIMATE EVAPORATIVE COOLER ELECTRIC DRINKING COOLER EXCAVATE EXHAUST EXTERIOR FIRE ALARM	JT. K-D KD KO L.E.D. L.FT. LAM LAT. LAV LD. LIN. LINO. LT. LTG. LVL M.B. M.H. M.I. M.O. MAR. MAS. MAT'L MAX. MECH. MED. MFG. MFR. MIN. MISC. MOD MTL. MUL N.I.C. N.T.S. NCM NFC NLR. NO. NOM. O.C. O.D.	KNOCK DOWN KILN DRIED KNOCK OUT LIGHT EMITTING DIODE LINEAR FEET LAMINATE LATERAL LAVATORY LEAD LINEAR LINOLEUM LIGHT LIGHTING LAMINATED VENEER LUMBER MACHINE BOLT MANHOLE MALLEABLE IRON MASONRY OPENING MARBLE MASONRY MATERIAL MAXIMUM MECHANICAL MEDIUM MISCELLANEOUS MODULAR MISCELLANEOUS MODULAR METAL MULLION NOT TO SCALE NON-CORROSIVE METAL NOT FOR CONSTRUCTION NAILER NUMBER NUMBER NOMINAL ON CENTER OUTSIDE DIAMETER	SUSP. SW SYM SYS. T & G T.B. T.M.B. T.O. T.O.B. T.O.C. T.O.F. T.O.J. T.O.W. T.S. T.V. TEL. TH. THD. THK. THRU TLT. TRANS. TYP. UNF. UNF. UNO. UR V.B. V.I.F. VA VCT VERT. V.O.J. W/C WDW WCT WP WT. W/O	SUSPENDED SWITCH SYMMETRICAL SYSTEM TONGUE AND GROOVE THROUGH BOLT TELEPHONE MOUNTING BOA TOP OF TOP OF BEAM TOP OF CURB TOP OF FOOTING TOP OF JOIST TOP OF MASONRY TOP OF SLAB-TOP OF STE TOP OF WALL TUBE STEEL TELEVISION OUTLET TELEPHONE THRESHOLD THREADED THICK THROUGH TOILET TRANSFORMER TYPICAL UNFINISHED UNLESS NOTED OTHERWISE URINAL VAPOR BARRIER VERIFY IN FIELD VOLT AMPERE VINYL COMPOSITION TILE VERTICAL VERIFY ON JOB WATER CLOSET WINDOW WAINSCOT WEATHER PROOF WEIGHT WITH WITHOUT
COL. COMB. CONC. CONST. CONT. CU d D.F. D.G. D.S. D/W DBL. DEMO DIA. or Ø DIAG. DIM. DL DN. E.A. E.F. E.J. E.N. E.W. EA. ELECT. ELEV. EMC EMT ENT EQ. EQUIP. EST. EVAP. EXC EXT. F.A. F.A. F.A. F.A. F.A. F.A.	COMBINATION CONCRETE CONSTRUCTION CONTINUOUS CONTRACTOR COPPER PENNY DRINKING FOUNTAIN DECOMPOSED GRANITE DOWN SPOUT DISHWASHER DOUBLE DEMOLITION DIAMETER DIAGONAL DIMENSION DEAD LOAD DOWN DOOR EXPANSION ANCHOR EXHAUST FAN EXPANSION JOINT END NAILING EACH WAY EACH ELEVATION "ELECTRIC, ELECTRICAL" ELECTRICAL METALLIC TUBING EQUAL EQUIPMENT ESTIMATE EVAPORATIVE COOLER ELECTRIC DRINKING COOLER EXCAVATE EXHAUST EXISTING EXTERIOR FIRE ALARM FAN COIL	JT. K-D KD KO L.E.D. L.FT. LAM LAT. LAV LD. LIN. LINO. LT. LTG. LVL M.B. M.H. M.I. M.O. MAR. MAS. MAT'L MAS. MECH. MED. MFG. MFR. MIN. MISC. MOD MTL. N.I.C. N.T.S. NCM NFC NLR. NO. NOM. O.C. O.D. O.H.	KNOCK DOWN KILN DRIED KNOCK OUT LIGHT EMITTING DIODE LINEAR FEET LAMINATE LATERAL LAVATORY LEAD LINEAR LINOLEUM LIGHT LIGHTING LAMINATED VENEER LUMBER MACHINE BOLT MANHOLE MALLEABLE IRON MASONRY OPENING MARBLE MASONRY MATERIAL MAXIMUM MECHANICAL MEDIUM MISCELLANEOUS MODULAR METAL MULLION NOT IN CONTRACT NOT TO SCALE NON—CORROSIVE METAL NOT FOR CONSTRUCTION NAILER NUMBER NOMINAL ON CENTER OUTSIDE DIAMETER OVER HANG	SUSP. SW SYM SYS. T & G T.B. T.M.B. T.O. T.O.B. T.O.C. T.O.F. T.O.J. T.O.W. T.O.S. T.O.W. T.S. T.V. TEL. TH. THD. THK. THRU TLT. TRANS. TYP. UNF. UNF. UNO. UR V.B. V.I.F. VA VCT VERT. V.O.J. W/C WDW WCT WP WT. W/O WD.	SUSPENDED SWITCH SYMMETRICAL SYSTEM TONGUE AND GROOVE THROUGH BOLT TELEPHONE MOUNTING BOA TOP OF TOP OF BEAM TOP OF CURB TOP OF FOOTING TOP OF JOIST TOP OF SLAB—TOP OF STE TOP OF WALL TUBE STEEL TELEVISION OUTLET TELEPHONE THRESHOLD THREADED THICK THROUGH TOILET TRANSFORMER TYPICAL UNFINISHED UNLESS NOTED OTHERWISE URINAL VAPOR BARRIER VERIFY IN FIELD VOLT AMPERE VINYL COMPOSITION TILE VERTICAL VERIFY ON JOB WATER CLOSET WINDOW WAINSCOT WEATHER PROOF WEIGHT WITH WITHOUT
COL. COMB. CONC. CONST. CONT. CONTR. CU d D.F. D.G. D.S. D/W DBL. DEMO DIA. or Ø DIAG. DIM. DL DN. DR E.A. E.F. E.J. E.N. E.W. EA. ELECT. ELECT. ELECT. ELECT. ELECT. ELECT. EXY. EXT. F.A. F.C. F.C. F.C. CONTR. CONTR.	COMBINATION CONCRETE CONSTRUCTION CONTINUOUS CONTRACTOR COPPER PENNY DRINKING FOUNTAIN DECOMPOSED GRANITE DOWN SPOUT DISHWASHER DOUBLE DEMOLITION DIAMETER DIAGONAL DIMENSION DEAD LOAD DOWN DOOR EXPANSION ANCHOR EXHAUST FAN EXPANSION JOINT END NAILING EACH WAY EACH ELEVATION "ELECTRIC, ELECTRICAL" ELECTRICAL METALLIC TUBING EQUAL EQUIPMENT ESTIMATE EVAPORATIVE COOLER EXCAVATE EXHAUST EXHAUST EXHAUST EXHAUST ESTIMATE EVAPORATIVE COOLER ELECTRIC DRINKING COOLER EXCAVATE EXHAUST EXISTING EXTERIOR FIRE ALARM FAN COIL FLOOR CLEAN OUT	JT. K-D KD KO L.E.D. L.FT. LAM LAT. LAV LD. LINO. LT. LTG. LVL M.B. M.H. M.I. M.O. MAR. MAS. MAT'L MAS. MECH. MED. MFG. MFR. MIN. MISC. MOD MTL. N.I.C. N.T.S. NCM NFC NLR. NO. NOM. O.C. O.D. O.H. O.I.	JOINT KNOCK DOWN KILN DRIED KNOCK OUT LIGHT EMITTING DIODE LINEAR FEET LAMINATE LATERAL LAVATORY LEAD LINEAR LINOLEUM LIGHT LIGHTING LAMINATED VENEER LUMBER MACHINE BOLT MANHOLE MALLEABLE IRON MASONRY OPENING MARBLE MASONRY MATERIAL MAXIMUM MECHANICAL MEDIUM MANUFACTURING MANUFACTURING MANUFACTURER MINIMUM MISCELLANEOUS MODULAR METAL MULLION NOT IN CONTRACT NOT TO SCALE NON—CORROSIVE METAL NOT FOR CONSTRUCTION NAILER NUMBER NOMINAL ON CENTER OUTSIDE DIAMETER OVER HANG ORNAMENTAL IRON	SUSP. SW SYM SYS. T & G T.B. T.M.B. T.O. T.O.B. T.O.C. T.O.F. T.O.J. T.O.W. T.O.S. T.O.W. T.S. T.V. TEL. TH. THD. THK. THRU TLT. TRANS. TYP. UNF. UNF. UNF. UNF. VA VCT VERT. V.O.J. W/C WDW WCT WP WT. W/ W/O WD. W.I.	SUSPENDED SWITCH SYMMETRICAL SYSTEM TONGUE AND GROOVE THROUGH BOLT TELEPHONE MOUNTING BOA TOP OF TOP OF BEAM TOP OF CURB TOP OF FOOTING TOP OF JOIST TOP OF MASONRY TOP OF SLAB—TOP OF STE TOP OF WALL TUBE STEEL TELEVISION OUTLET TELEPHONE THRESHOLD THREADED THICK THROUGH TOILET TRANSFORMER TYPICAL UNFINISHED UNLESS NOTED OTHERWISE URINAL VAPOR BARRIER VERIFY IN FIELD VOLT AMPERE VINYL COMPOSITION TILE VERTICAL VERIFY ON JOB WATER CLOSET WINDOW WAINSCOT WEATHER PROOF WEIGHT WITH WITHOUT WOOD WROUGHT IRON
COL. COMB. CONC. CONST. CONT. CU d D.F. D.G. D.S. D/W DBL. DEMO DIA. or Ø DIAG. DIM. DL DN. DR E.A. E.F. E.J. E.N. E.W. EA. ELECT. ELEV. EMC EMT ENT EQ. EQUIP. EST. EVAP. EXT. EXT. F.A. F.A. F.A. F.A. F.A. F.A. F.A.	COMBINATION CONCRETE CONSTRUCTION CONTINUOUS CONTRACTOR COPPER PENNY DRINKING FOUNTAIN DECOMPOSED GRANITE DOWN SPOUT DISHWASHER DOUBLE DEMOLITION DIAMETER DIAGONAL DIMENSION DEAD LOAD DOWN DOOR EXPANSION ANCHOR EXHAUST FAN EXPANSION JOINT END NAILING EACH WAY EACH ELEVATION "ELECTRIC, ELECTRICAL" ELECTRICAL METALLIC TUBING EQUAL EQUIPMENT ESTIMATE EVAPORATIVE COOLER ELECTRIC DRINKING COOLER EXCAVATE EXHAUST EXISTING EXTERIOR FIRE ALARM FAN COIL	JT. K-D KD KO L.E.D. L.FT. LAM LAT. LAV LD. LIN. LINO. LT. LTG. LVL M.B. M.H. M.I. M.O. MAR. MAS. MAT'L MAS. MECH. MED. MFG. MFR. MIN. MISC. MOD MTL. N.I.C. N.T.S. NCM NFC NLR. NO. NOM. O.C. O.D. O.H.	KNOCK DOWN KILN DRIED KNOCK OUT LIGHT EMITTING DIODE LINEAR FEET LAMINATE LATERAL LAVATORY LEAD LINEAR LINOLEUM LIGHT LIGHTING LAMINATED VENEER LUMBER MACHINE BOLT MANHOLE MALLEABLE IRON MASONRY OPENING MARBLE MASONRY MATERIAL MAXIMUM MECHANICAL MEDIUM MISCELLANEOUS MODULAR METAL MULLION NOT IN CONTRACT NOT TO SCALE NON—CORROSIVE METAL NOT FOR CONSTRUCTION NAILER NUMBER NOMINAL ON CENTER OUTSIDE DIAMETER OVER HANG	SUSP. SW SYM SYS. T & G T.B. T.M.B. T.O. T.O.B. T.O.C. T.O.F. T.O.J. T.O.W. T.O.S. T.O.W. T.S. T.V. TEL. TH. THD. THK. THRU TLT. TRANS. TYP. UNF. UNF. UNO. UR V.B. V.I.F. VA VCT VERT. V.O.J. W/C WDW WCT WP WT. W/O WD.	SUSPENDED SWITCH SYMMETRICAL SYSTEM TONGUE AND GROOVE THROUGH BOLT TELEPHONE MOUNTING BOA TOP OF TOP OF BEAM TOP OF CURB TOP OF JOIST TOP OF SLAB—TOP OF STE TOP OF WALL TUBE STEEL TELEVISION OUTLET TELEPHONE THREADED THICK THROUGH TOILET TRANSFORMER TYPICAL UNFINISHED UNLESS NOTED OTHERWISE URINAL VAPOR BARRIER VERIFY IN FIELD VOLT AMPERE VINYL COMPOSITION TILE VERTICAL VERIFY ON JOB WATER CLOSET WINDOW WAINSCOT WEATHER PROOF WEIGHT WITHOUT WOOD
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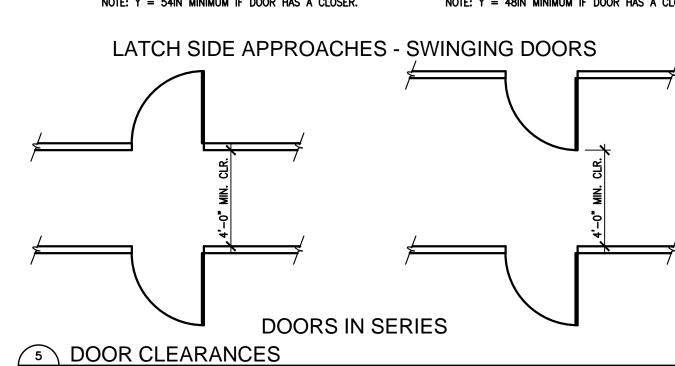


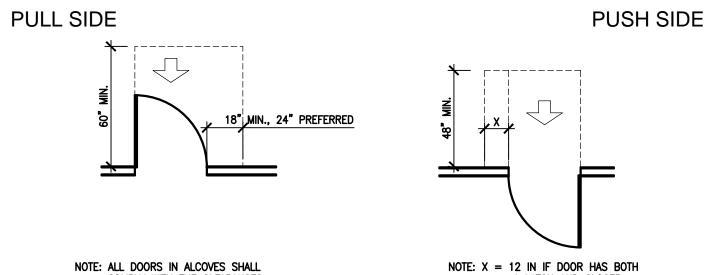
COMPLY WITH THE CLEARANCES FOR FRONT APPROACHES.

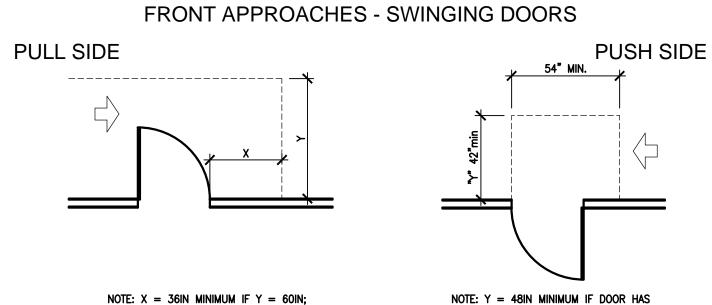


X = 42IN MINIMUM IF Y = 54INBOTH A LATCH AND CLOSER HINGE SIDE APPROACHES - SWINGING DOORS



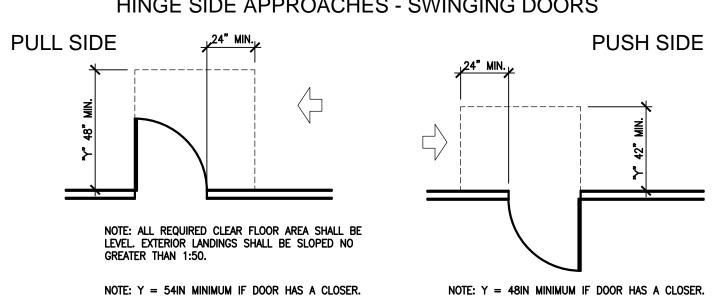

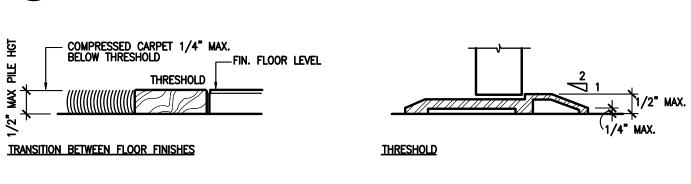

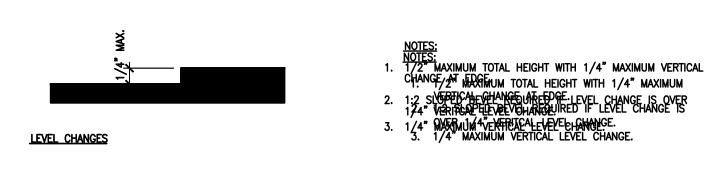


8 THRESHOLD / LEVEL CHANGES G2.00 SCALE: 6" = 1'-0"

G2.00 SCALE: 1/4" = 1'-0"

<u>DETECTABLE WARNING SURFACES INSIDE PROPERTY LINES:</u> DETECTABLE WARNING AREAS SHALL CONSIST OF A REGULARLY SPACED, CONTINUOUS PATTERN OF GROOVES RUNNING PERPENDICULAR TO THE RUN OF A CURB RAMP OR PARALLEL TO THE EDGE BETWEEN A CIRCULATION PATH AND A HAZARDOUS AREA. GROOVES SHALL BE 1/4" WIDE BY 5/8" DEEP SPACED 3" O.C. WARNING AREAS SHALL CONTRAST VÍSUALLY WITH ADJOINING SURFACES, EITHER LIGHT-ON-DARK, OR DARK-ON-LIGHT.


DETECTABLE WARNING SURFACES OUTSIDE PROPERTY LINES: DETECTABLE WARNINGS SHALL CONSIST OF RAISED TRUNCATED DOMES WITH A DIAMETER OF NOMINAL 0.9", A HEIGHT OF NOMINAL 0.2" AND A CENTER-TO-CENTER SPACING OF NOMINAL 2.35" AND SHALL CONTRAST VISUALLY WITH ADJOINING SURFACES, EITHER LIGHT-ON-DARK, OR DARK-ON-LIGHT.

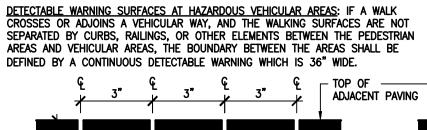


DETECTABLE WARNING SURFACES INSIDE PROPERTY LINES

G2.00 SCALE: 3" = 1'-0"


DETECTABLE WARNING SURFACES OUTSIDE PROPERTY LINES 10 DETECTABLE WARNING SURFACES

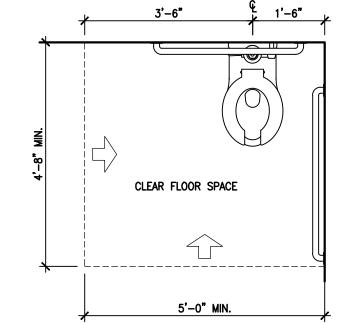


1 CLEAR FLOOR SPACE AT ACCESSIBLE WATER CLOSETS

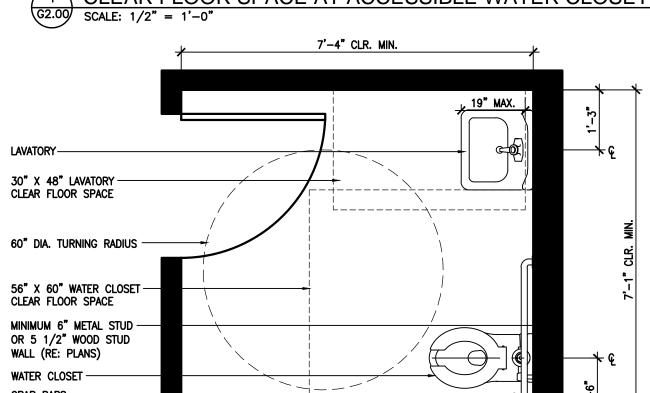

STANDARD ACCESSIBLE SINGLE FIXTURE TOILET G2.00 SCALE: 1/2" = 1'-0"

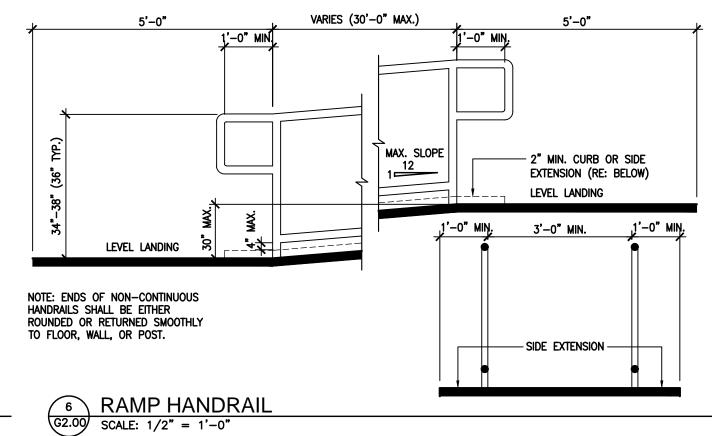


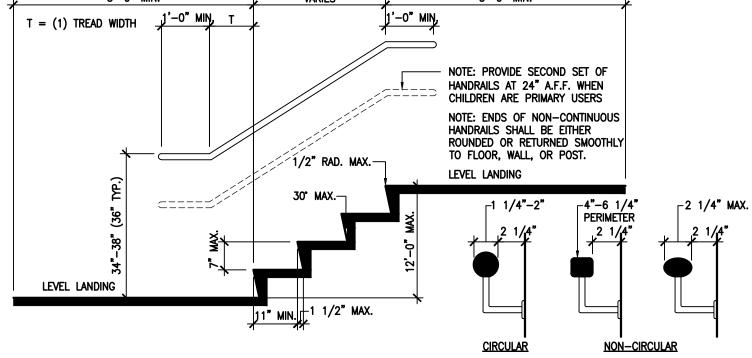

9 STAIR HANDRAIL G2.00 SCALE: 1/2" = 1'-0"

(11) STANDARD MOUNTING HEIGHTS


G2.00 SCALE: 1/2" = 1'-0"

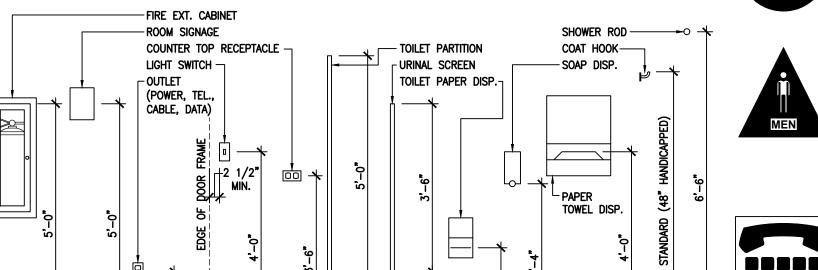


HANDRAIL PROFILES

ALT. DOOR CLEAR FLOOR SPACE 56" MIN. W/ WALL MOUNT W.C. MIN. 42" MIN. LATCH APPROACH 59" MIN. W/ FLOOR MOUNT W.C. MIN. 48" MIN. OTHER APPROACHES

2 ACCESSIBLE TOILET STALL G2.00 SCALE: 1/2" = 1'-0"

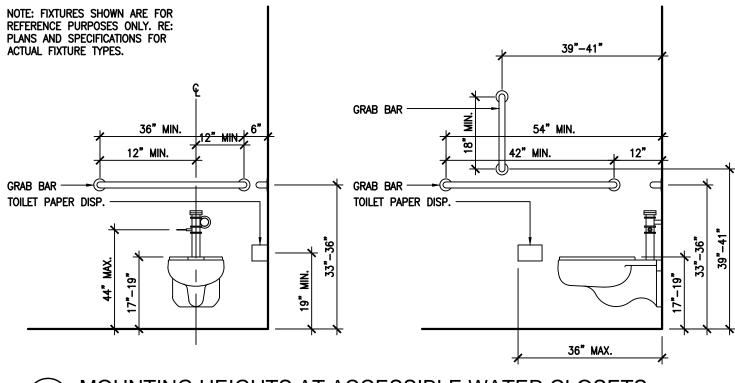


MOUNTING HEIGHTS AT ACCESSIBLE WATER CLOSETS

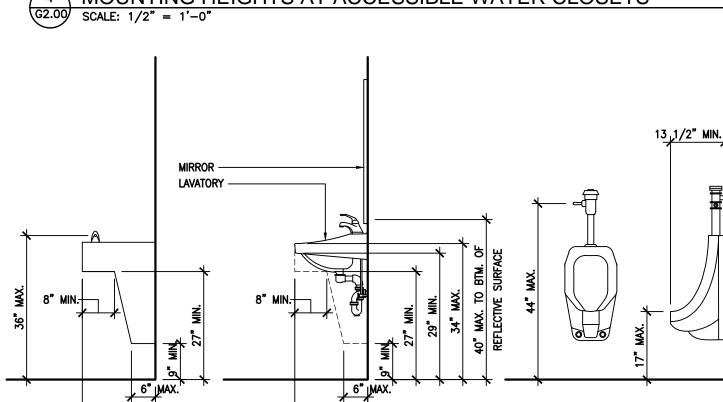

17"-19" ACCESSIBLE E.W.C, LAVATORY AND URINAL

G2.00 SCALE: 1/2" = 1'-0"

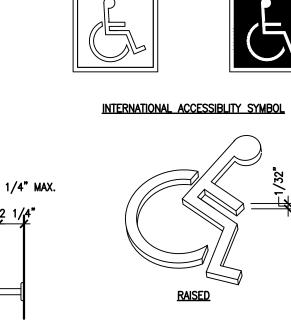

INTERNATIONAL TDD SYMBOL







INTERNATIONAL SYMBOL OF ACCESS 16. 0.2 INCH SPACE BETWEEN CELLS.

12 ACCESSIBLE SIGNAGE

G2.00 SCALE: NO SCALE

LETTERS AND NUMBERS:

LETTERS AND NUMBERS ON SIGNS SHALL BE RAISED 1/32" MINIMUM AND SHALL BE SANS-SERIF UPPERCASE CHARACTERS ACCOMPANIED BY GRADE 2 BRAILLE. RAISED CHARACTERS OR SYMBOLS SHALL BE A MINIMUM OF 5/8" HIGH. PICTORIAL SYMBOL SIGNS (PICTOGRAMS) SHALL BE ACCOMPANIED BY THE EQUIVALENT VERBAL DESCRIPTION PLACED DIRECLY BELOW THE PICTOGRAM. THE BORDER DIMENSION OF THE PICTOGRAM SHALL BE A MINIMUM OF 6" IN HEIGHT.

4. LETTERS AND NUMBERS ON SIGNS SHALL HAVE A WIDTH—TO—HEIGHT RATIO OF BETWEEN 3:5 AND 1:1 AND A STROKE WIDTH-TO-HEIGHT RATIO BETWEEN 1:5

5. CHARACTERS AND SYMBOLS SHALL CONTRAST WITH THEIR BACKGROUND, EITHER LIGHT CHARACTERS ON A DARK BACKGROUND OR DARK CHARACTERS ON A LIGHT BACKGROUND.

6. CHARCTERS AND NUMBERS ON SIGNS SHALL BE SIZED ACCORDING TO THE VIEWING DISTANCE FROM WHICH THEY ARE TO BE READ. THE MINIMUM HEIGHT IS MEASURED USING AN UPPER CASE X. LOWER CASE CHARACTERS ARE PERMITTED. FOR SIGNS SUSPENDED OR PROJECTED GREATER THAN 80" ABOVE THE FINISH FLOOR. THE MINIMUM CHARACTER HEIGHT SHALL BE 3". CONTRACTED GRADE 2 BRAILLE SHALL BE USED WHEREVER BRAILLE SYMBOLS ARE SPECIFICALLY REQUIRED IN OTHER PORTIONS OF THESE REGULATIONS. DOTS SHALL BE 1/10" ON CENTERS IN EACH CELL WITH 2/10" SPACE BETWEEN CELLS. DOTS SHALL BE RAISED A MINIMUM OF 1/40" ABOVE THE BACKGROUND.

SIGN LOCATIONS:

8. ALL BUILDING ENTRANCES THAT ARE ACCESSIBLE TO AND USABLE BY PERSONS WITH DISABILITIES AND AT EVERY MAJOR JUNCTION ALONG OR LEADING TO AN ACCESSIBLE ROUTE OF TRAVEL SHALL BE IDENTIFIED WITH A SIGN DISPLAYING THE INTERNATIONAL SYMBOL OF ACCESSIBILITY AND WITH ADDITIONAL DIRECTIONAL SIGNS, AS REQUIRED, TO BE VISIBLE TO PERSONS ALONG APPROACHING PEDESTRIAN WAYS.

WHEN PERMANENT IDENTIFICATION IS PROVIDED FOR ROOMS AND SPACES. RAISED LETTERS SHALL BE PROVIDED AND SHALL BE ACCOMPANIED BY BRAILLE. SIGNS SHALL BE INSTALLED ON THE WALL ADJACENT TO THE LATCH OUTSIDE OF THE DOOR. WHERE THERE IS NO WALL SPACE ON THE LATCH SIDE, INCLUDING AT LEAF DOORS, SIGNS SHALL BE PLACE ON THE NEAREST ADJACENT WALL, PREFERABLY ON THE RIGHT. MOUNTING HEIGHT SHALL BE 60" ABOVE THE FINISH FLOOR TO THE CENTERLINE OF THE SIGN. MOUNTING LOCATION SHALL BE DETERMINED SO THAT THE PERSON MAY APPROACH WITHIN 3" OF THE SIGNAGE WITHOUT ENCOUNTERING PROTRUDING OBJECTS OR STANDING WITHIN THE SWING OF A DOOR.

D. ADDITIONAL DIRECTIONAL SIGNS ALONG ACCESSIBLE PATH OF TRAVEL ARE . BUILDINGS REMODELED TO PROVIDE ACCESSIBLE SANITARY FACILITIES FOR PUBLIC USE SHALL HAVE INFORMATION POSTED IN THE LOBBY AS PART OF THE BUILDING DIRECTORY.

INTERNATIONAL SYMBOL OF ACCESSIBILITY:

12. STANDARD USED TO IDENTIFY ACCESSIBLE FACILITIES.

13. WHITE FIGURE ON BLUE BACKGROUND. 14. WHEN ENFORCING AGENCY DETERMINES, IF APPROPRIATE, SPECIAL DESIGNS AND COLORS MAY BE APPROVED.

15. USE CONTRASTED GRADE 2 BRAILLE. DOTS TO BE 0.1 INCH ON CENTER IN

17. DOTS RAISED MINIMUM 0.025 INCH ABOVE BACKGROUND.

EXHIBIT

FUSION

FUSION ARCHITECTURE, PC

FRANKLIN, TENNESSEE 37064

W: FUSIONARCHITECTURE.COM

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Scales as stated hereon are valid on th

specifically identified herein.

administer construction.

PHASE | REVISION SCHEMATIC DESIGN

DESIGN DEVELOPMENT

PERT

SOTHERS PROPE HEAD SHELTER

AILHE

DRIVE EE 3700

HUFFINES RIDGE DRANKLIN, TENNESSE

CONSTRUCTION DOCUMENTS

drawing only.

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These plans were prepared in this office under

03.08.2019

personal supervision, and to the best of our know

comply with state and local codes. We will ge

116 MAJESTIC LANE

V: 615.454.3916


PROJECT NUMBER


03-014-18

SHEET TITLE

STANDARDS

SHEET NUMBER

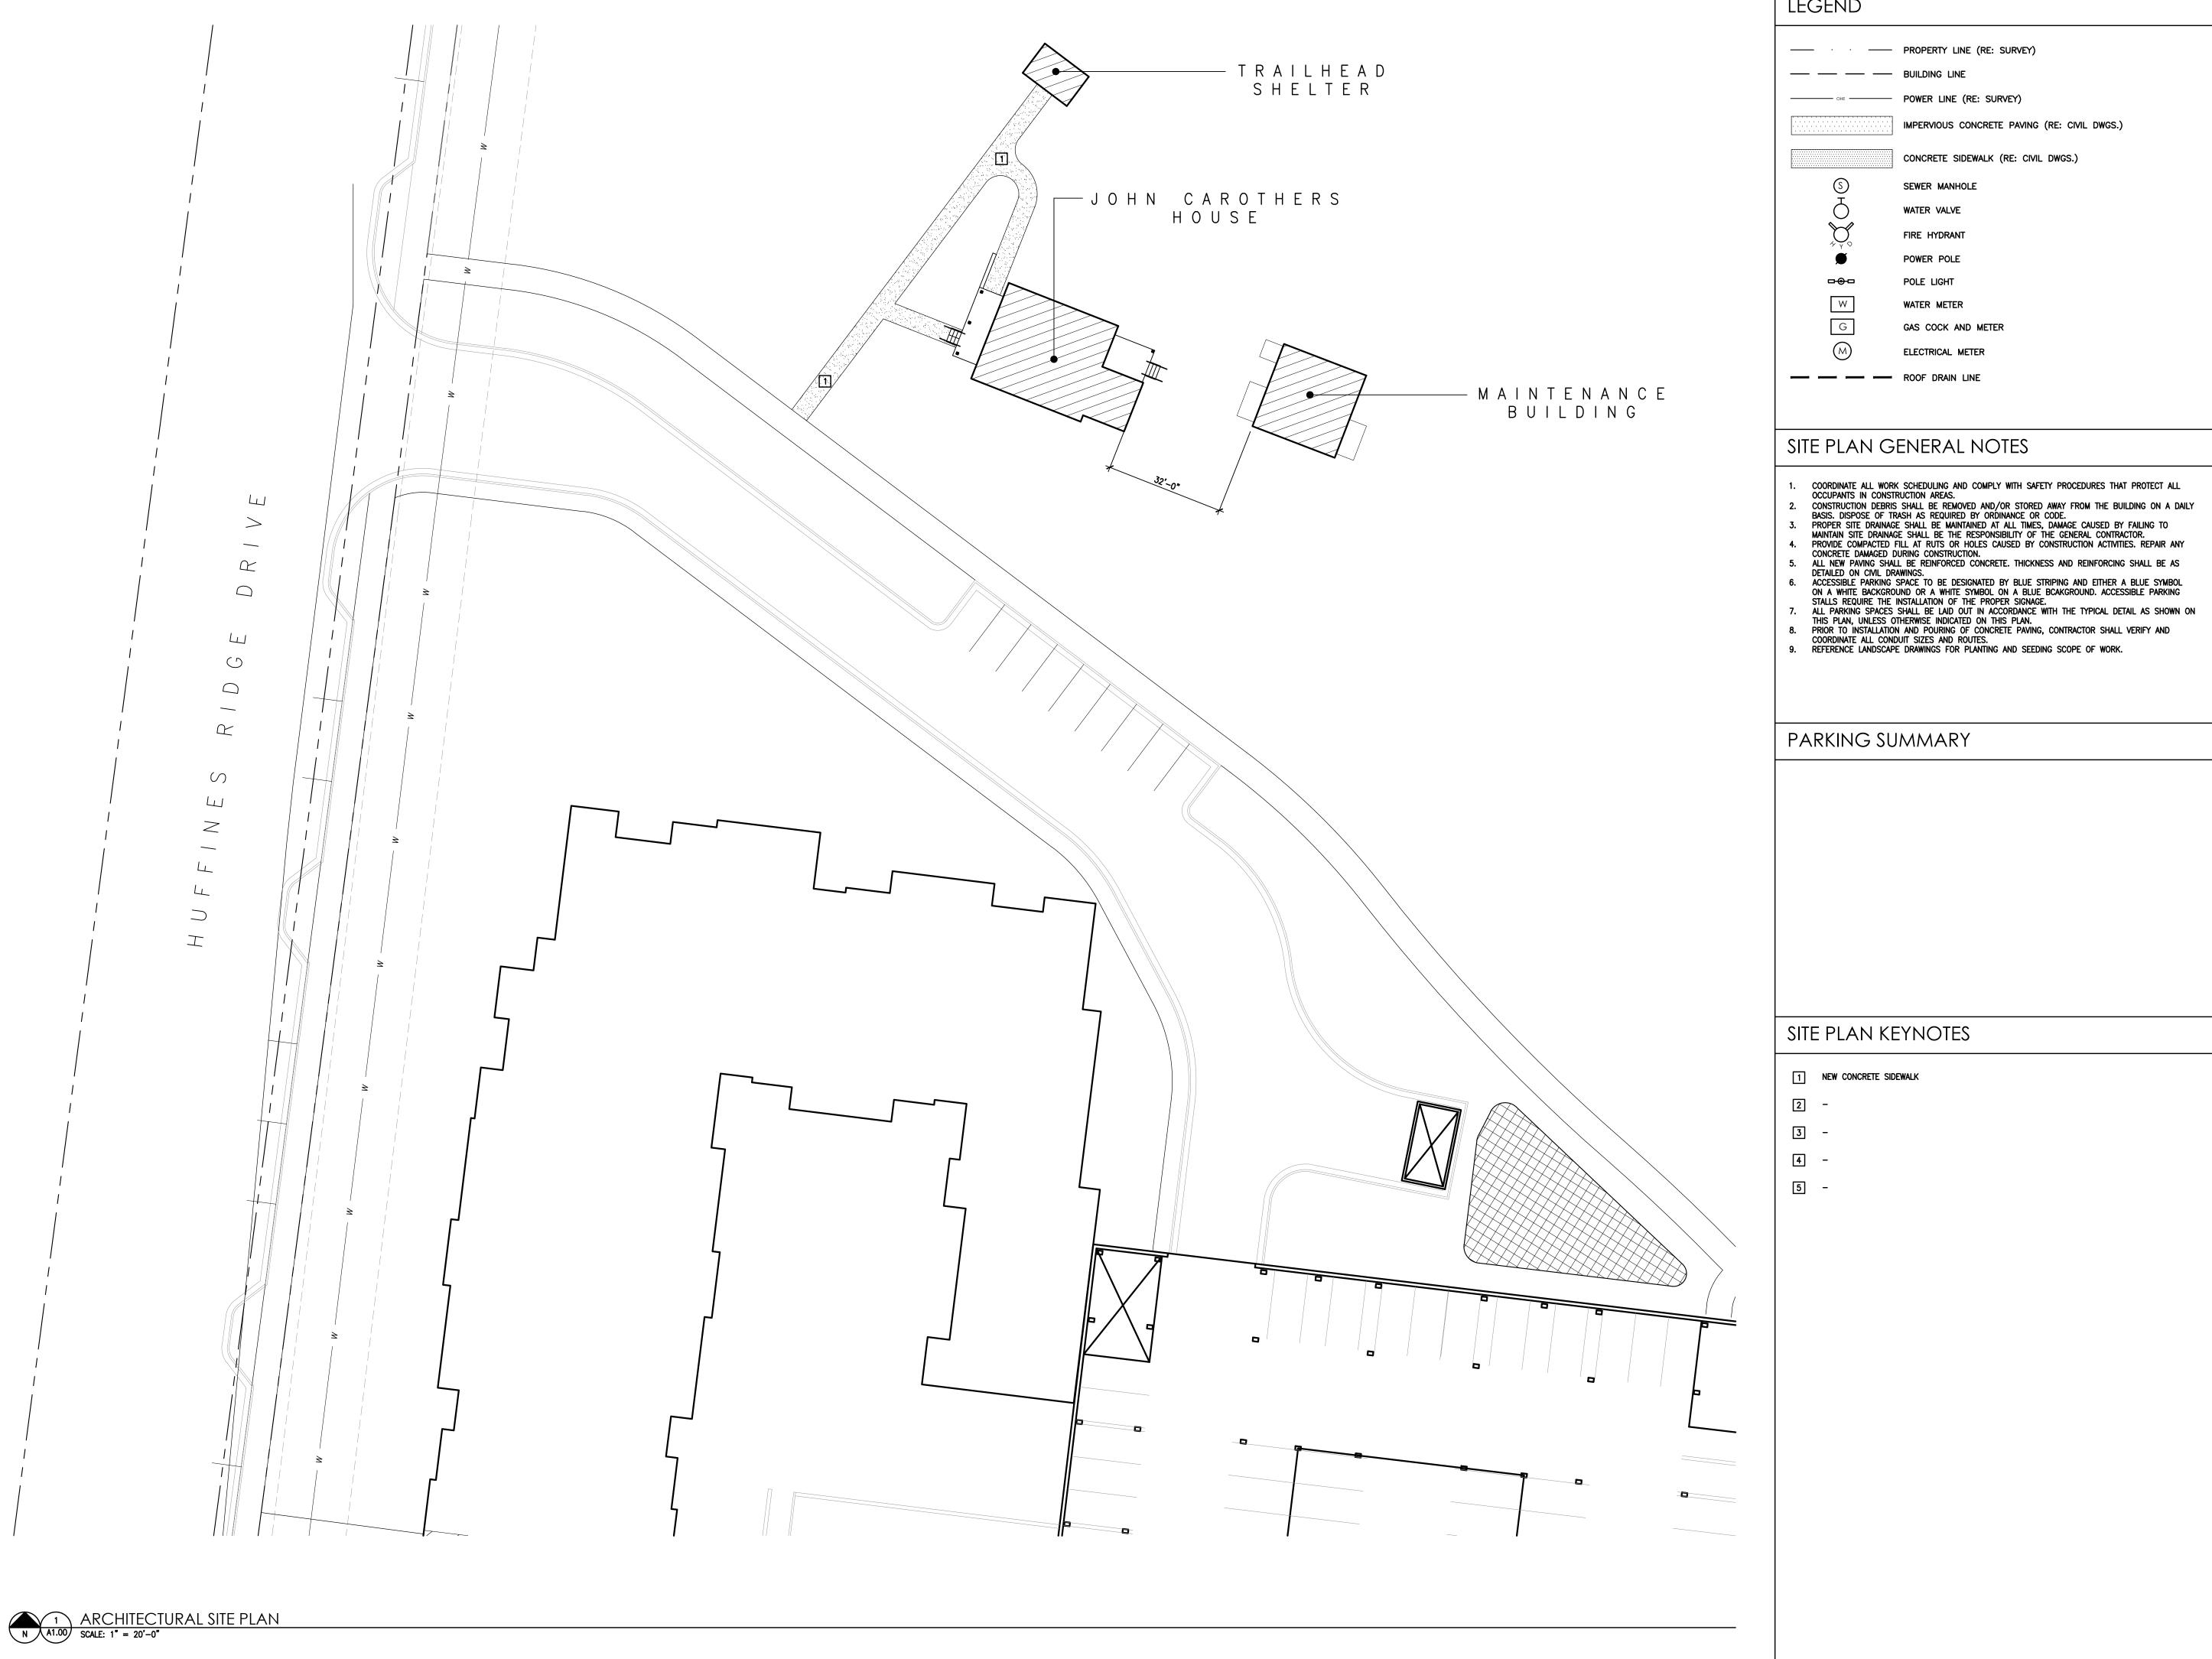

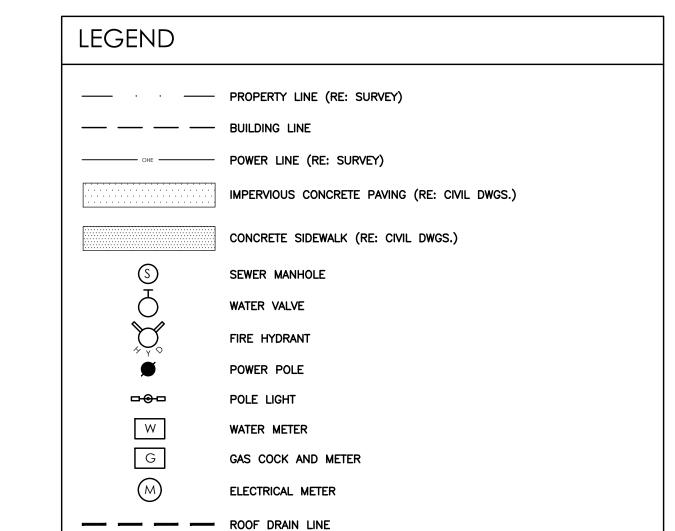

SITE PLAN GENERAL NOTES

- COORDINATE ALL WORK SCHEDULING AND COMPLY WITH SAFETY PROCEDURES THAT PROTECT ALL OCCUPANTS IN CONSTRUCTION AREAS.

- 9. REFERENCE LANDSCAPE DRAWINGS FOR PLANTING AND SEEDING SCOPE OF WORK.

PARKING SUMMARY

SITE PLAN KEYNOTES

- 1 NEW CONCRETE SIDEWALK



FUSION ARCHITECTURE, PC

116 MAJESTIC LANE FRANKLIN, TENNESSEE 37064 V: 615.454.3916 W: FUSIONARCHITECTURE.COM

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administer construction.

PHASE | REVISION SCHEMATIC DESIGN DESIGN DEVELOPMENT 03.08.2019 CONSTRUCTION DOCUMENTS

JOHN CAROTHERS PROP TRAILHEAD SHELTER

EXHIBIT

PROJECT NUMBER


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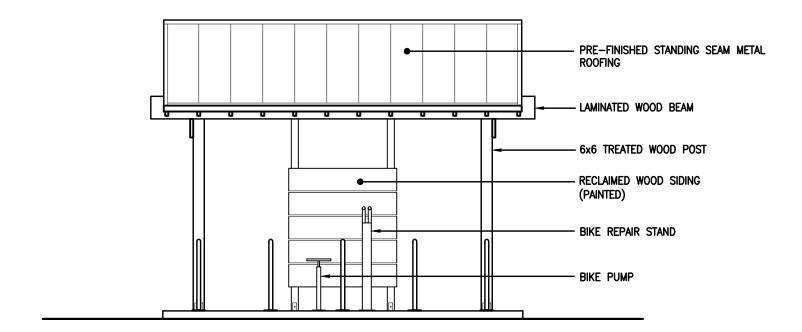
SHEET TITLE

ARCH. SITE PLAN

SHEET NUMBER


A1.00



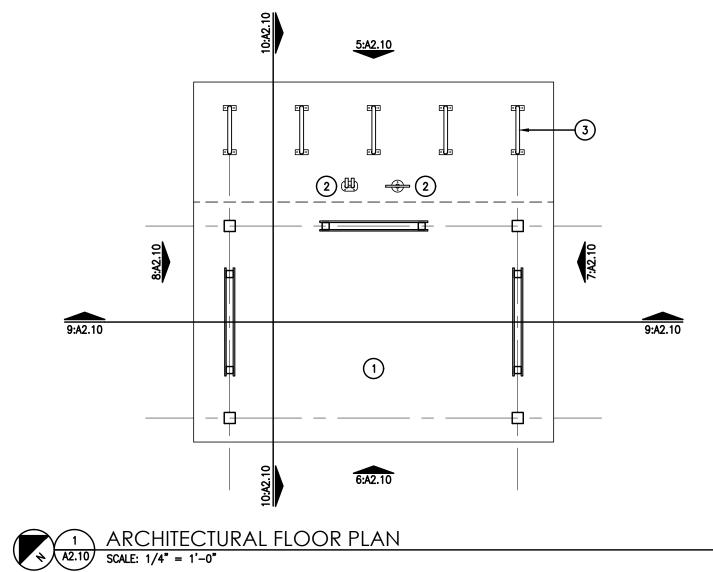


5 NORTH ELEVATION

A2.10 SCALE: 1/4" = 1'-0"

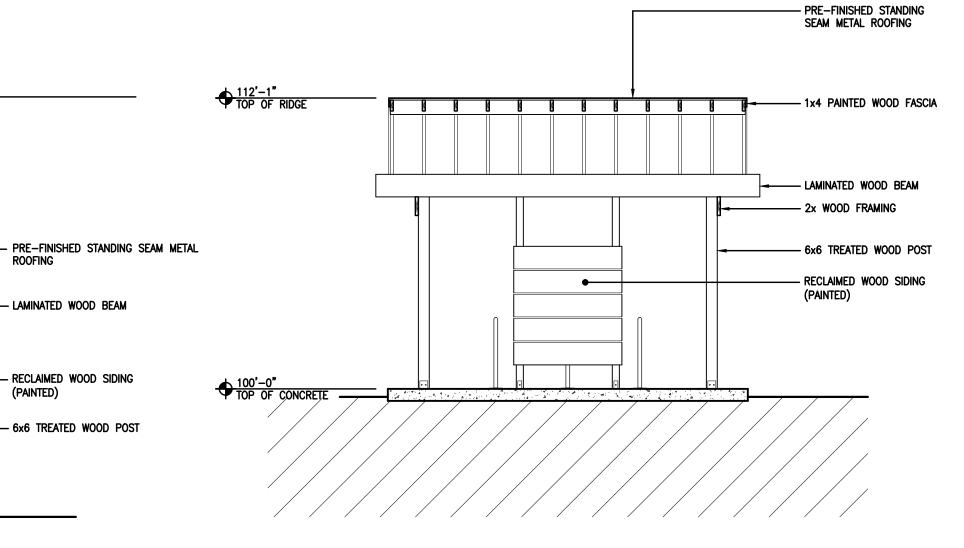



2 ARCHITECTURAL CEILING PLAN

A2.10 SCALE: 1/4" = 1'-0"

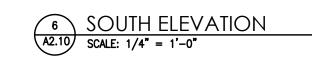




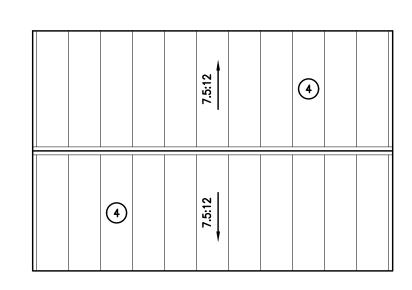

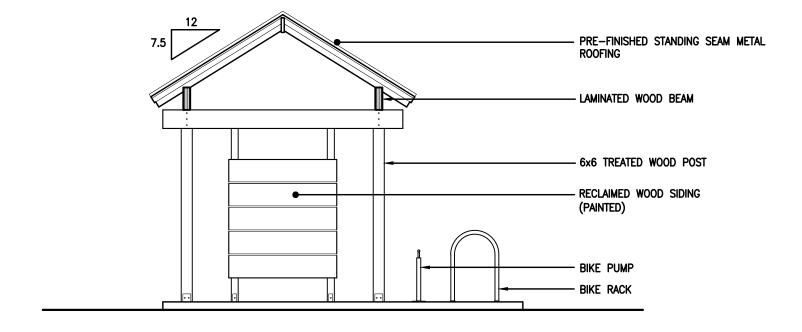

3 ARCHITECTURAL ROOF PLAN


A2.10 SCALE: 1/4" = 1'-0"

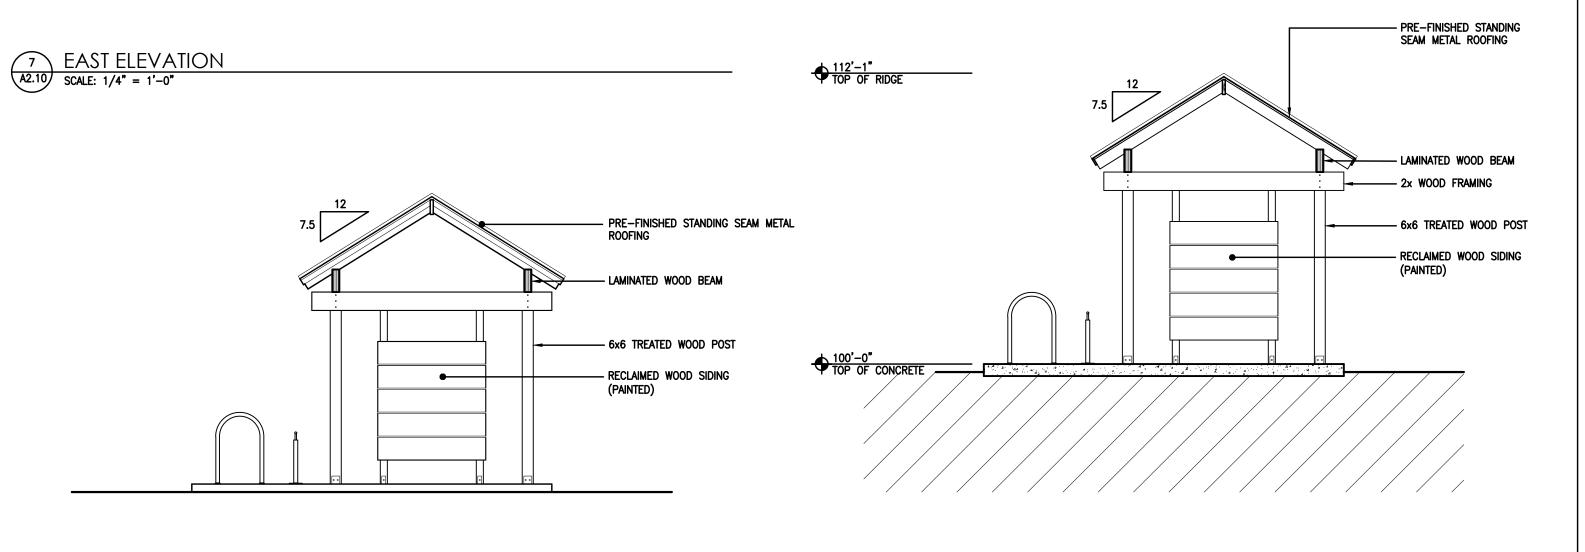

8 WEST ELEVATION A2.10 SCALE: 1/4" = 1'-0" 10 SECTION A2.10 SCALE: 1/4" = 1'-0" LEGEND

NEW DOOR AS SCHEDULED

DOOR AS SCHEDULED _____ NEW WALL AS SCHEDULED

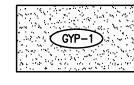

PAINTED GYPSUM BOARD:

2'-0" x 4'-0" LED LIGHT WITH ACRYLIC LENS (RE: ELECTRICAL)

RECESSED CAN DOWNLIGHT (RE: ELECTRICAL)

EXIT LIGHT (RE: ELECTRICAL)

ELEVATION INDICATES CLEAR HEIGHT FROM FINISHED FLOOR TO FINISHED CEILING. ALL CEILING HEIGHTS = 9'-0'' U.N.O.

GENERAL NOTES

1. INTERIOR FINISHES SHALL COMPLY WITH NFPA 101:36.3.3 (0-75) FLAMESPREAD WITH SMOKE DEVELOPMENT OF (0-450).

2. LOOSELY HANGING FURNISHINGS AND DECORATIONS SHALL BE FLAME RESISTANT AS DEMONSTRATED BY TESTING IN ACCORDANCE WITH NFPA 701.

3. ALL DIMENSIONS, UNLESS NOTED OTHERWISE, ARE TAKEN FROM FACE OF FRAMING.

4. INSULATION ASSEMBLIES SHALL MEET THE REQUIREMENTS OF SECTION 708, IBC, 2018 EDITION.

KEYNOTES

1 CONCRETE PAVING

BIKE TOOLS

4) PRE-FINISHED STANDING SEAM METAL ROOF

5 -

6 -

7 -

8 -

10 -

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FUSION

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116 MAJESTIC LANE

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administer construction.

PHASE | REVISION DATE
SCHEMATIC DESIGN 01.11.2019
DESIGN DEVELOPMENT 03.08.2019

DESIGN DEVELOPMENT 03.08.

CONSTRUCTION DOCUMENTS

JOHN CAROTHERS PROPERTY
TRAILHEAD SHELTER
HUFFINES RIDGE DRIVE
FRANKLIN, TENNESSEE 37067

EXHIBIT D

PROJECT NUMBER

03-014-18

SHEET TITLE

ARCH. PLANS

SHEET NUMBER

A2.10

EXHIBIT E
PARKLAND IMPACT FEE OFFSET - COST ESTIMATE

ARKLAND	MPACT FEES					
	Parkland dedication fee	\$4,304	426	EA	\$1,833,504	
	-					
OFFSET COS						
	Cost Line Item	UNIT COST	QTY	UNIT	ALLOWANCE*	NOTES
	House Renovation, unsafe structure demo	\$350	1068	SF	\$373,800	Assumption-based, architect and contractor engaged to provide estimates
	Trail Construction	\$300,000	1	LS	\$300,000	OE compiling a custom estimate for Legacy Cool Springs
	Arboretum / Pavilion	\$75,000	1	LS	\$75,000	Assumption
	Trail Head Storm Shelter	\$150	150	SF	\$22,500	
	Maintenance Shed	\$150	576	SF	\$86,400	
	Historic Stone Wall Restoration	\$200,000	1	LS	\$200,000	
	Parking Lot - 10 spaces	\$150,000	1	LS	\$150,000	
	Park Signage	\$25,000	1	LS	\$25,000	
	Design Fees	\$17,500	1	LS	\$17,500	
	Land Dedication	\$62,121	10.03	AC	\$623,074	
					64 072 274	

\$1,873,274

^{*}Allowance indicates known project cost/exposure but an unquantifiable amount given current data.

COF Contract No. 2019-0096

Exhibit F: Opinion of Cost

Based on the City of Franklin's Parkland Dedication Ordinance (Ordinance 2016-25, Franklin Municipal Code §25-405, and hereinafter, "Ordinance"), the opinion of cost is as follows. Legacy, LLC (hereinafter, "Legacy") will be developing the property known as Huffines Ridge, which is located at 1343 Huffines Ridge Drive, Franklin, Williamson County, Tennessee. The development is proposed to include four hundred twenty-six (426) apartment units, a one hundred seventy (170) room hotel, and an office building consisting of approximately 150,000 square feet. The total number of dwelling units on the property is proposed to be four hundred twenty-six (426) units. The Total Parkland Impact Fee Obligation Per Dwelling Unit fee, as listed in Appendix A, Chapter 25, of the Franklin Municipal Code (hereinafter, "Appendix"), is \$4,304.00.

The total obligation for Huffines Ridge, based on the four hundred twenty-six (426) dwelling units at the assessed price of \$4,304.00 is \$1,833,504.00. According to the Ordinance, this amount must be paid "at the same time the fees that are due for recording of the final plat, or for issuance of a building permit, whichever occurs first, or in accordance with the provisions of the City of Franklin Charter or a Contract for Parkland Impact Fees, Parkland Dedication and/or Construction of Park Improvements approved by the BOMA, when applicable." The amount may be reimbursed in part or in full based on the Parks Department's assessment of any parkland construction on the development's property.

Legacy intends to dedicate 10.03 acres of land to the City and construct a mountain bike trail system, arboretum, and restore the property's historic home on the Huffines Ridge property. The Appendix states, Off-sets for Private Parkland set-aside available for Public use when in an all access public easement will be "calculated at 100% of the Parkland Dedication in Lieu of Parkland Impact Fee Off-Set amount if the parkland improvement is a project consistent with the Comprehensive Parks and Recreation Master Plan." Based on this calculation, Legacy is eligible for a one hundred (100) percent off-set of the parkland impact fees in the amount of \$1,833,504.00 for the dedication of land, construction of the mountain bike trail and arboretum, and the restoration of the property's historic home. This is the maximum off-set amount available for this project, and it will be reimbursed to Legacy at the completion of the project.

The table below is a summary of the above information.

Total Parkland Impact Fee for 426 units @ \$4,304/unit	
	\$1,833,504.00
Eligible amount of off-set based on 100% of total Parkland Impact Fee	
	\$1,833,504.00