

ACCOMODATE THE RUNOFF FROM THE SITE.



CIVIL DESIGN CONSULTANTS, LLC
CIVIL ENGINEERS - LAND PLANNERS CIVIL-DESIGN-CONSULTANTS, LLC 8170 COLEY DAVIS RD., NASHVILLE, TN. 37221 PHONE: (615) 319-2734EMAIL: CIVILCONSULTANTS® BELLSOUTH.NET

H. Michael Hindman Architects, P.C.

607 Westgate Circle - Suite 100 Brentwood, Tennessee 37027 615.370.3252

OFFICE BUILDING FOR

Touchstone Medical Imaging

LYNWOOD WAY LOT 137 GATEWAY VILLAGE SECTION 3 FRANKLIN, TENNESSEE

HMH Job Number 14035

> Drawn By HMH

Revisions

07.28.14

Drawing

FLOW WORKSHEET

GATEWAY VILLAGE PUD SUBDIVISION

SECTION 4 - LOT 137

SITE PLANS - TOUCHSTONE MEDICAL IMAGING OFFICE HEADQUARTERS










H. Michael Hindman Architects, P.C.

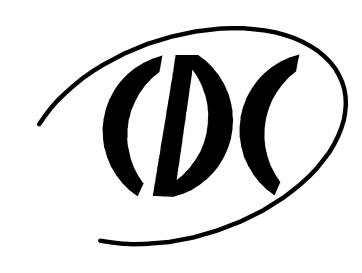



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8170 COLEY DAVIS RD., NASHVILLE, TN. 37221 PHONE: (615) 319-2734 EMAIL: CIVILCONSULTANTS@BELLSOUTH.NET



WATER - MVUD - 615-377-3374


PHONE -ATT- 1-877-986-1483

MANAGEMENT DEPT. - 615-794-4554

SEWER-COF- 615-791-3218

CITY OF FRANKLIN WATER

UTILITY PROVIDERS:

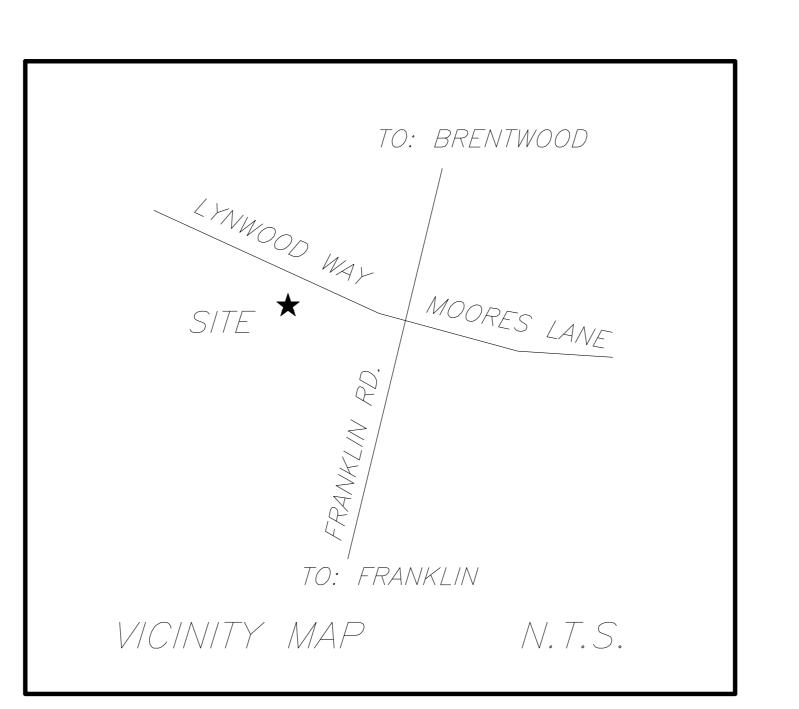

GAS- ATMOS ENERGY - 1-888-286-6700 ELECTRIC-MTEMC-1-877-777-9020

1360 MOHER BLVD CITY OF FRANKLIN PROJECT NUMBER 5740 CITY OF FRANKLIN, WILLIAMSON COUNTY, TENNESSEE

PLAN SHEET INDEX

SHEET **DESCRIPTION COVER SHEET EXISTING CONDITIONS PLAN** PROPOSED LAYOUT PLAN PROPOSED GRADING DRAINAGE PLAN PROPOSED UTILITY PLAN STORMWATER PLAN INITIAL STORMWATER PLAN INTERMEDIATE/FINAL SITE PHOTOMETRIC PLAN LANDSCAPE PLAN LANDSCAPE PLAN ARCHITECTURE PLAN ARCHITECTURE PLAN ARCHITECTURE PLAN ARCHITECTURE PLAN CONCEPT PLAN OF RECORD (FOR INFORMATION ONLY) CONCEPT PLAN AS APPROVED

SITE DATA: GATEWAY VILLAGE PUD SUBDIVISION DEVELOPMENT PLAN, REVISION 4. TOUCHSTONE OFFICE BUILDING 1360 MOHER BLVD. WILLIAMSON **TENNESSEE** PARCEL\MAP: PARCEL 49 MAP 064B GROUP B ACREAGE OF SITE: 1.45± ACRES SQUARE FOOTAGE OF SITE: 63,245± S.F. DISTURBED ACREAGE: 1.20± ACRES CIVIL DISTRICT: 3 RD ZONING DISTRICT: SD-X 6.64/144, 258 CHARACTER AREA BERRYS CHAPEL-4 DEVELOPMENT STANDARD EXISTING USE VACANT PROPOSED USE OFFICE APPLICANT: ARCHITECT

MR. MICHAEL HINDMAN, A.I.A. H. MICHAEL HINDMAN ARCHITECTS, PC 1607 WESTGATE CIRCLE, SUITE 100 BRENTWOOD, TN 37027 (615) 370-3252 CIVIL DESIGN CONSULTANTS, LLC. HEIBERT + BALL LAND DESIGN 8170 COLEY DAVIS RD. 1894 GENERAL GEORGE PATTON DR. NASHVILLE, TN 37221 (615) 638-8207 FRANKLIN. TN 37067 (615) 376-2421

BUILDING SQUARE FOOTAGE: 21,000 S.F. (MEDICAL OFFICE) PARKING REQUIRED: 60 SPACES

PARKING PROVIDED: 60 SPACES

ALL 90° PARKING ADJACENT TO THE PROPOSED BUILDING SHALL BE 9'X18' UNLESS OTHERWISE NOTED ALL PERIMETER SPACES ARE 9'X16' UNLESS OTHERWISE NOTED ALL DRIVE AISLES ARE 24' WIDE ALL PARKING ADJACENT TO ISLANDS SHALL BE 10'X18' SEE LANDSCAPE ARCHITECTURE PLAN FOR ADDITIONAL LAND DISTURBANCE AND GREEN SPACE

CITY OF FRANKLIN IS NOT A PART OF TN. ONE CALL CONTRACTOR SHALL COORDINATE WITH CITY FOR MARKING OF CITY UTILITIES

COF #5740

H. Michael Hindman Architects, P.C.

OFFICE BUILDING FOR

Touchstone

LOT 137 GATEWAY VILLAGE SECTION 3


Revisions


HMH Job Number 14035

Drawn By

07.28.14

Drawing **COVER SHEET**

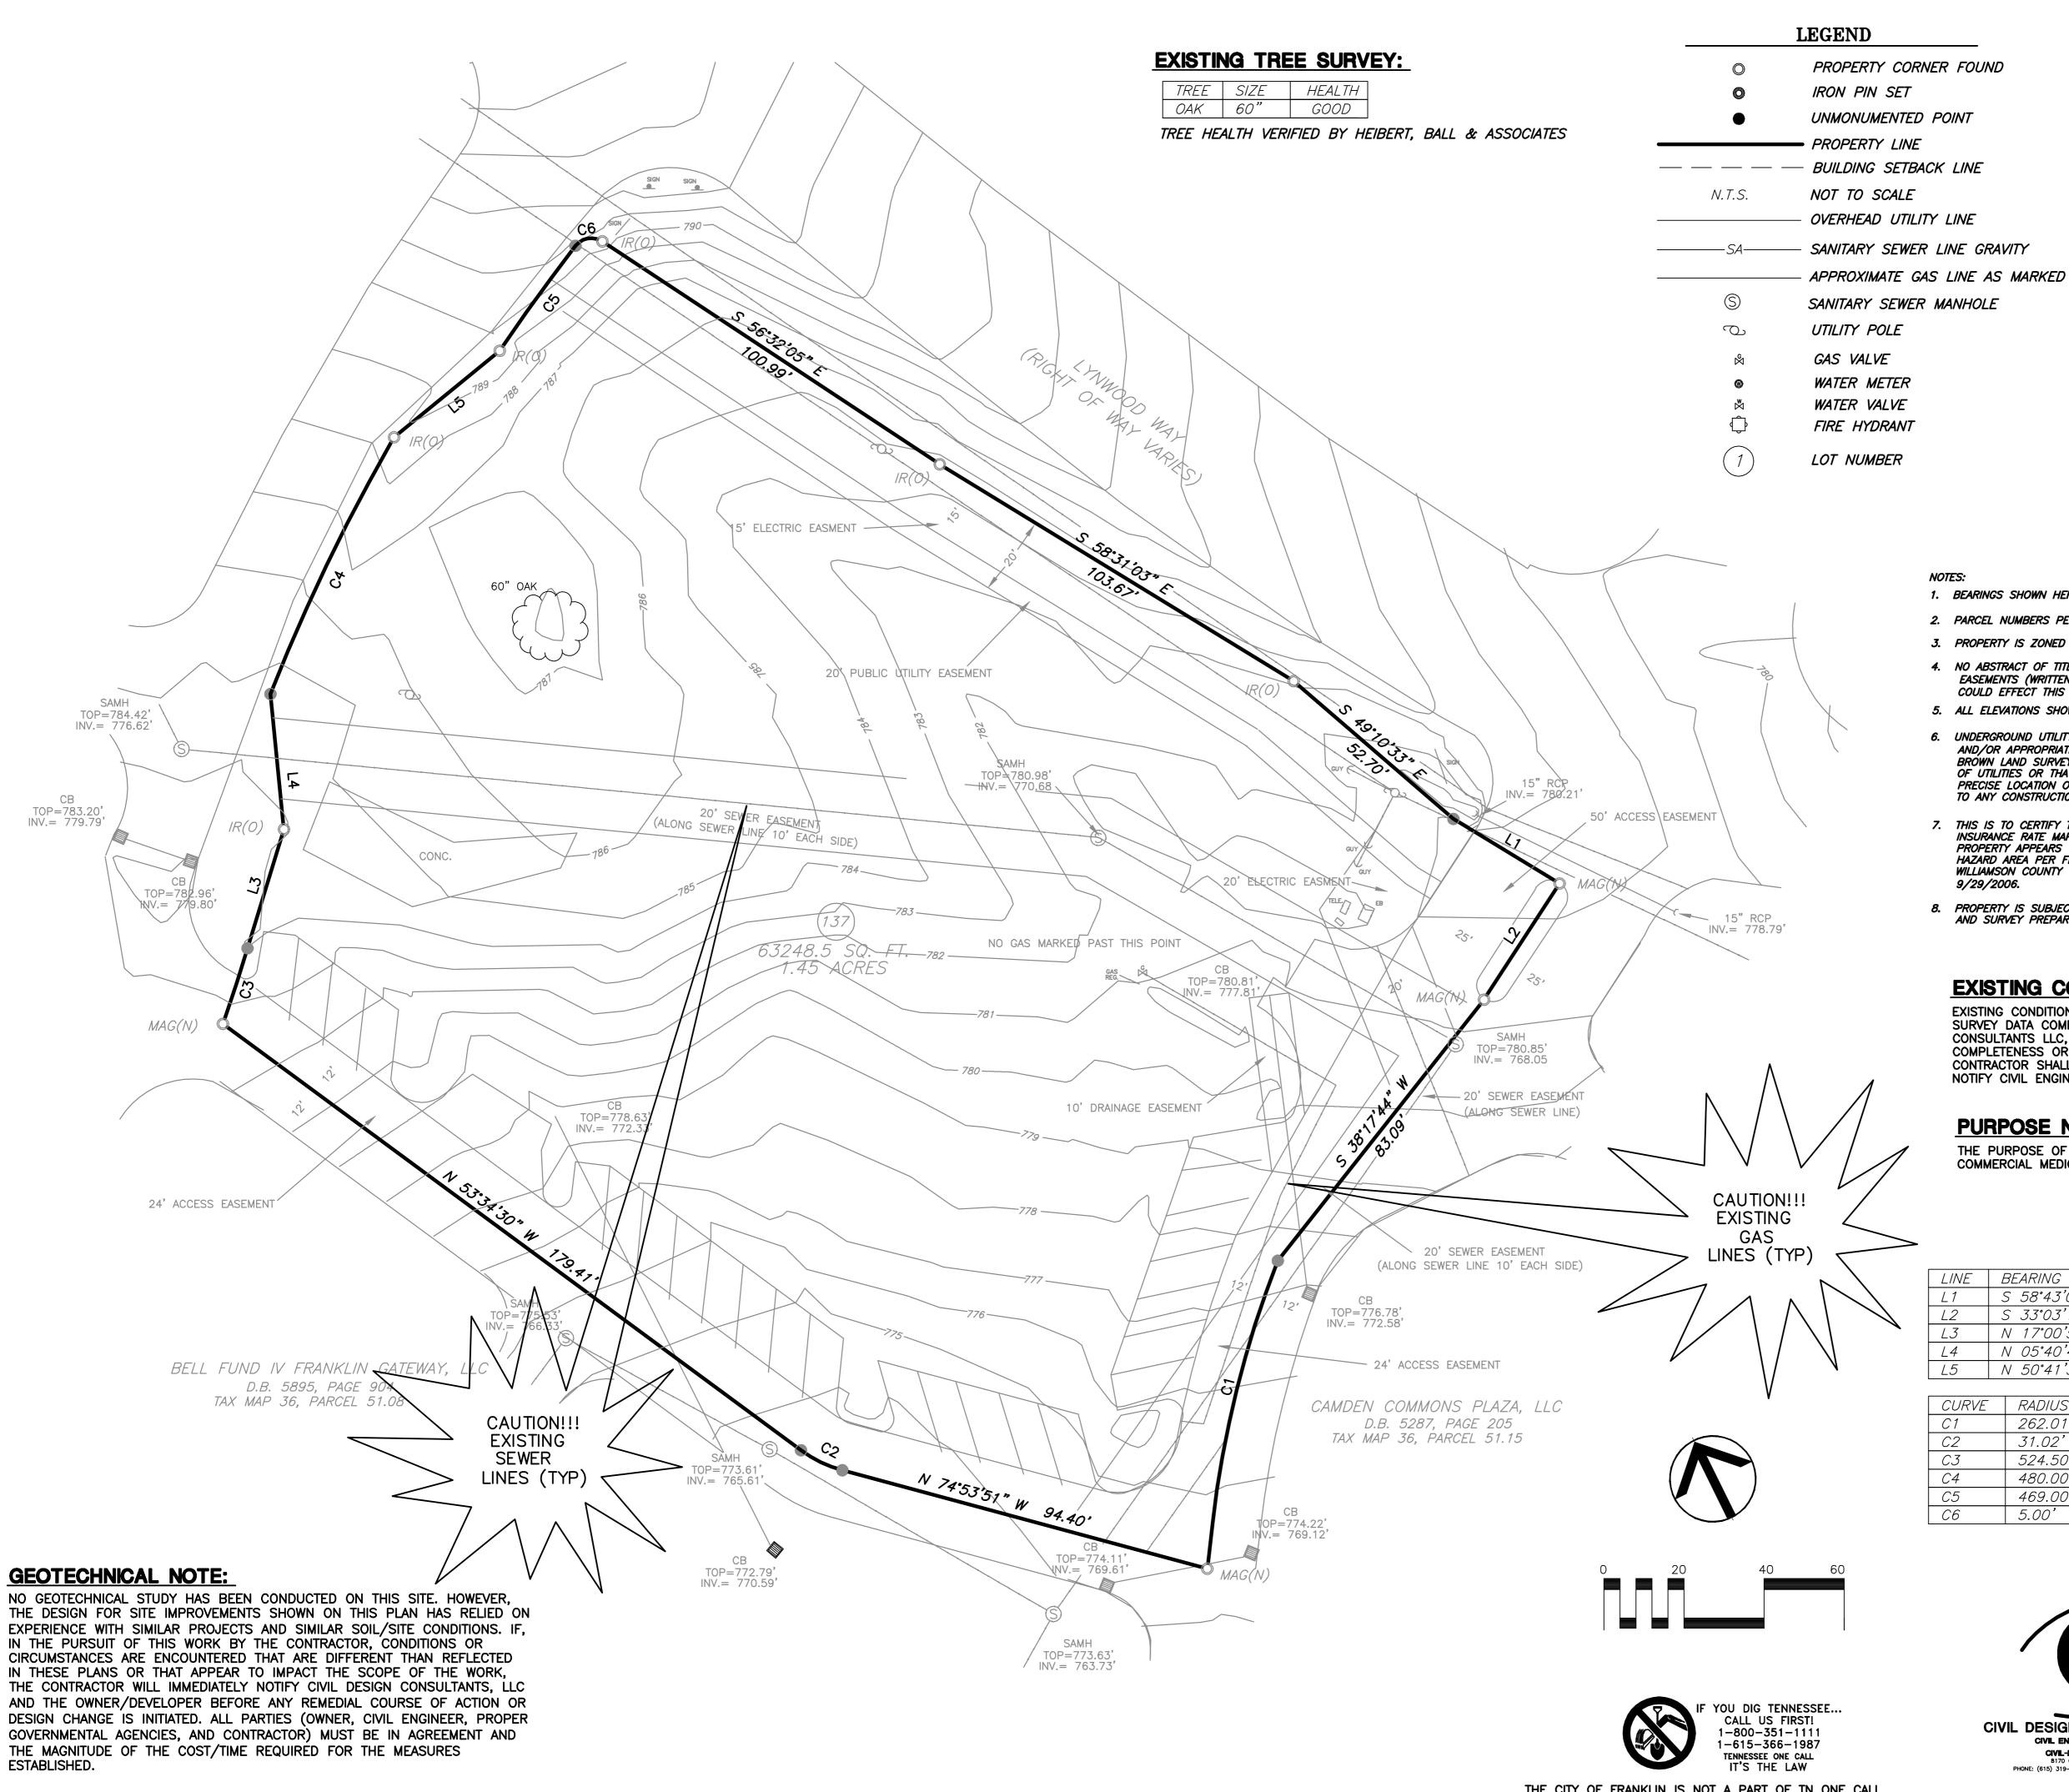

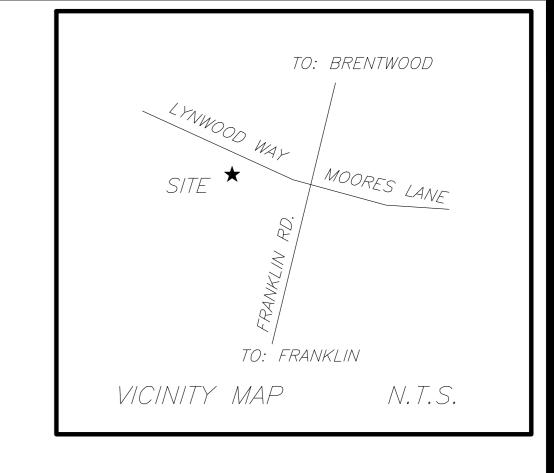

- 1. BEARINGS SHOWN HEREON ARE BASED ON TSPC.
- 2. PARCEL NUMBERS PERTAIN TO WILLIAMSON COUNTY TAX MAPS.
- 3. PROPERTY IS ZONED "PC 6.93 SUBURBAN". (PER SURVEY BY SCOTT CHERRY DATED 2/20/2008.)
- 4. NO ABSTRACT OF TITLE PROVIDED TO SURVEYOR. THERE MAY EXIST OTHER EASEMENTS (WRITTEN OR UNWRITTEN) OR DOCUMENTS OF RECORD THAT COULD EFFECT THIS PROPERTY.
- 5. ALL ELEVATIONS SHOWN ARE BASED ON NAVD88.
- 6. UNDERGROUND UTILITY LOCATIONS WERE TAKEN FROM FIELD LOCATIONS AND/OR APPROPRIATE GOVERNING AGENCIES AND ARE APPROXIMATE ONLY. BROWN LAND SURVEYING, LLC. DOES NOT CERTIFY THE EXACT LOCATION OF UTILITIES OR THAT ALL THE UTILITIES PRESENT ARE SHOWN ON THE SURVEY. PRECISE LOCATION OF UNDERGROUND UTILITIES IS RECOMMENDED PRIOR TO ANY CONSTRUCTION ON THIS PROPERTY. CALL TN-ONE CALL.
- 7. THIS IS TO CERTIFY THAT I HAVE EXAMINED THE FLOOD INSURANCE RATE MAP AND FOUND THE HEREON DESCRIBED PROPERTY APPEARS TO BE LOCATED IN A SPECIAL FLOOD HAZARD AREA PER FEMA MAP NO. 47187C0205F FOR WILLIAMSON COUNTY TENNESSEE UNINC, & INC. AREAS. DATED
- 8. PROPERTY IS SUBJECT TO EASEMENTS SHOWN ON RECORDED PLAT AND SURVEY PREPARED BY SCOTT CHERRY DATED 2/20/2008.

EXISTING CONDITIONS NOTE:

EXISTING CONDITIONS SHOWN ON THIS PLAN TAKEN FROM FIELD RUN SURVEY DATA COMPLETED BY BROWN LAND SURVEYING, INC. CIVIL DESIGN CONSULTANTS LLC, AND THIS ENGINEER, ASSUME NO LIABILITY AS TO THE COMPLETENESS OR ACCURACY OF WHAT IS SHOWN TO BE EXISTING. CONTRACTOR SHALL VERIFY IF NECESSARY ALL EXISTING CONDITIONS AND NOTIFY CIVIL ENGINEER IN THE EVENT THAT DISCREPENCIES EXIST.

PURPOSE NOTE:

THE PURPOSE OF THIS PLAN IS TO ALLOW FOR CONSTRUCTION OF A COMMERCIAL MEDICAL OFFICE DEVELOPMENT.


	LINE	BEARING	DISTANCE
	L1	S 58°43'02" E	31.03
	L2	S 33°03'13" W	34.63
•	L3	N 17°00'51" E	31.08
	L4	N 05°40'40" W	33.96
	L5	N 50°41'39" E	34.12

CURVE	RADIUS	ARC LENGTH	CHORD LENGTH	CHORD BEARING
C1	262.01	67.72'	67.53'	S 13°57'36" W
C2	31.02'	11.54	11.47'	N 64°14'32" W
<i>C3</i>	524.50'	19.86'	19.86'	N 18°01'06" E
C4	480.00'	71.24'	71.17'	N 25°41'41" E
C5	469.00'	32.33'	32.32'	N 35°49'17" E
<i>C6</i>	5.00'	7.47'	6.79'	N 80°40'23" E



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Revisions

H. Michael Hindman

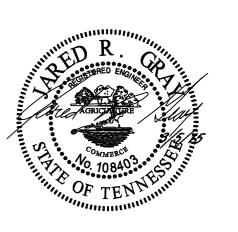OFFICE BUILDING FOR

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Touchstone

Medical

LYNWOOD WAY

LOT 137 GATEWAY VILLAGE SECTION 3

FRANKLIN, TENNESSEE


HMH Job Number 14035

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Drawing **EXISTING COND.**

THE CITY OF FRANKLIN IS NOT A PART OF TN ONE CALL. PLEASE CONTACT THE CITY DIRECTLY FOR LOCATION MARKINGS. COF #5740



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Touchstone Medical

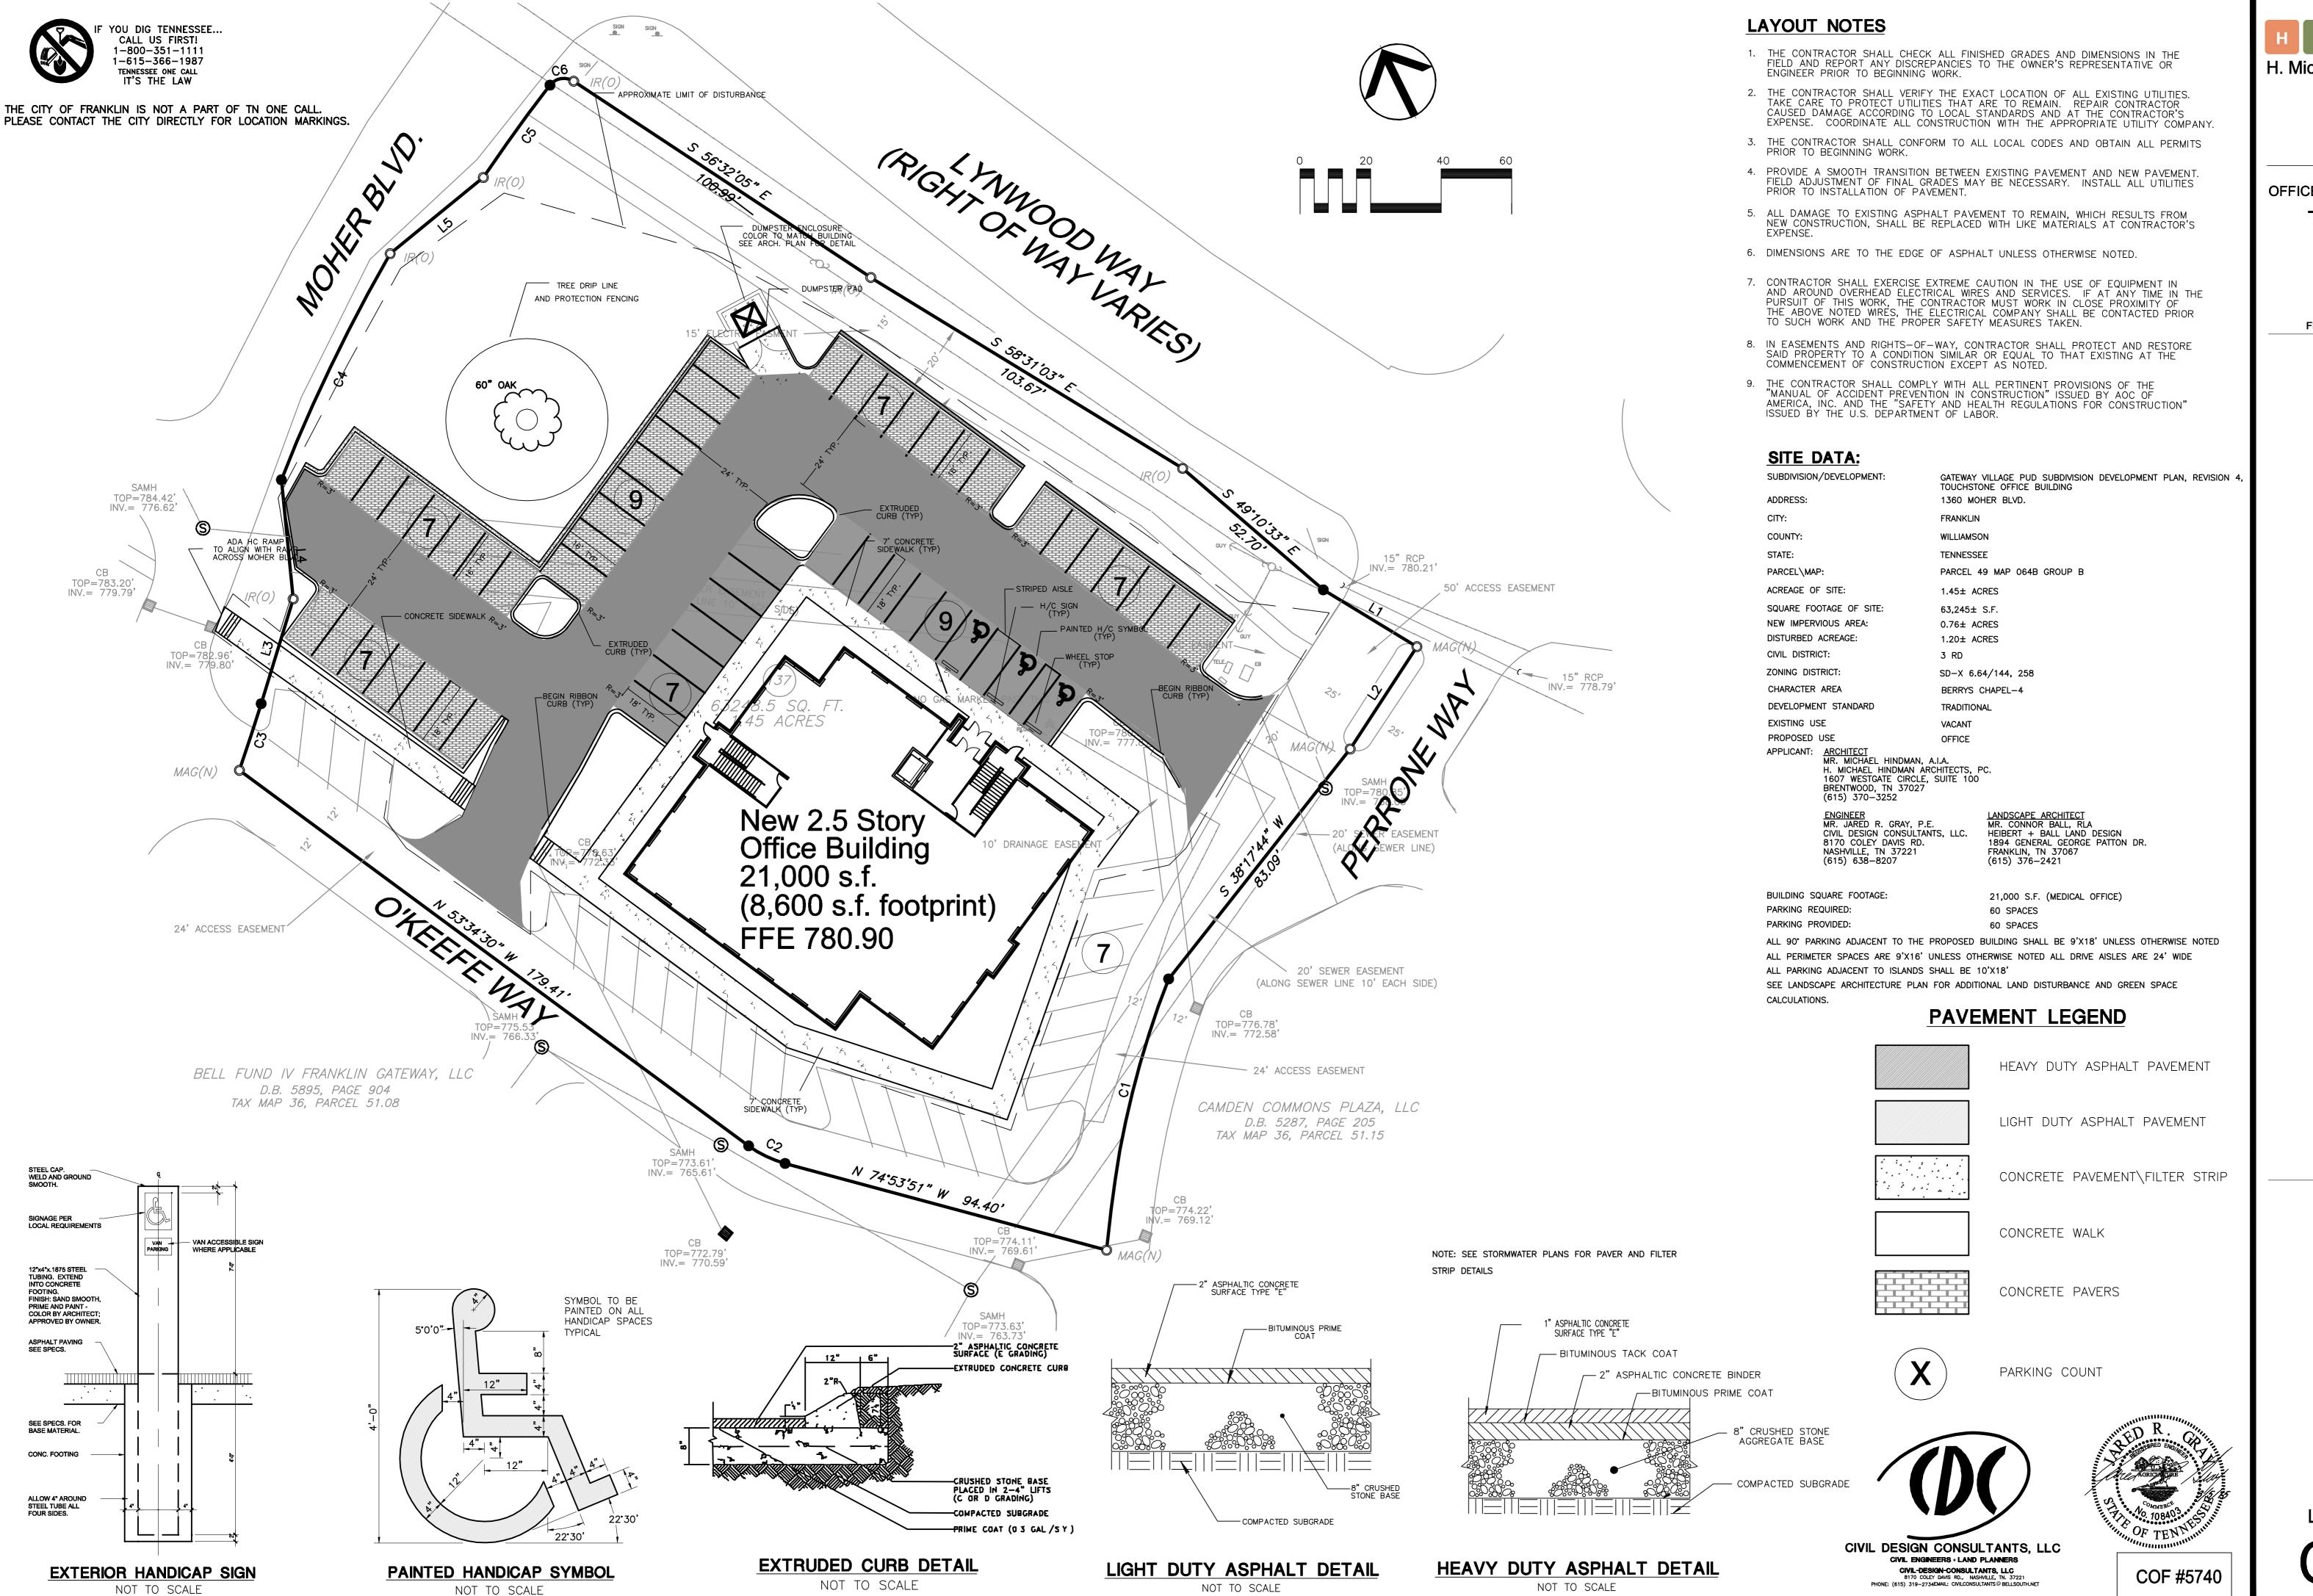LYNWOOD WAY LOT 137 GATEWAY VILLAGE SECTION 3 FRANKLIN, TENNESSEE


HMH Job Number 14035

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Revisions

07.28.14

Drawing LAYOUT PLAN

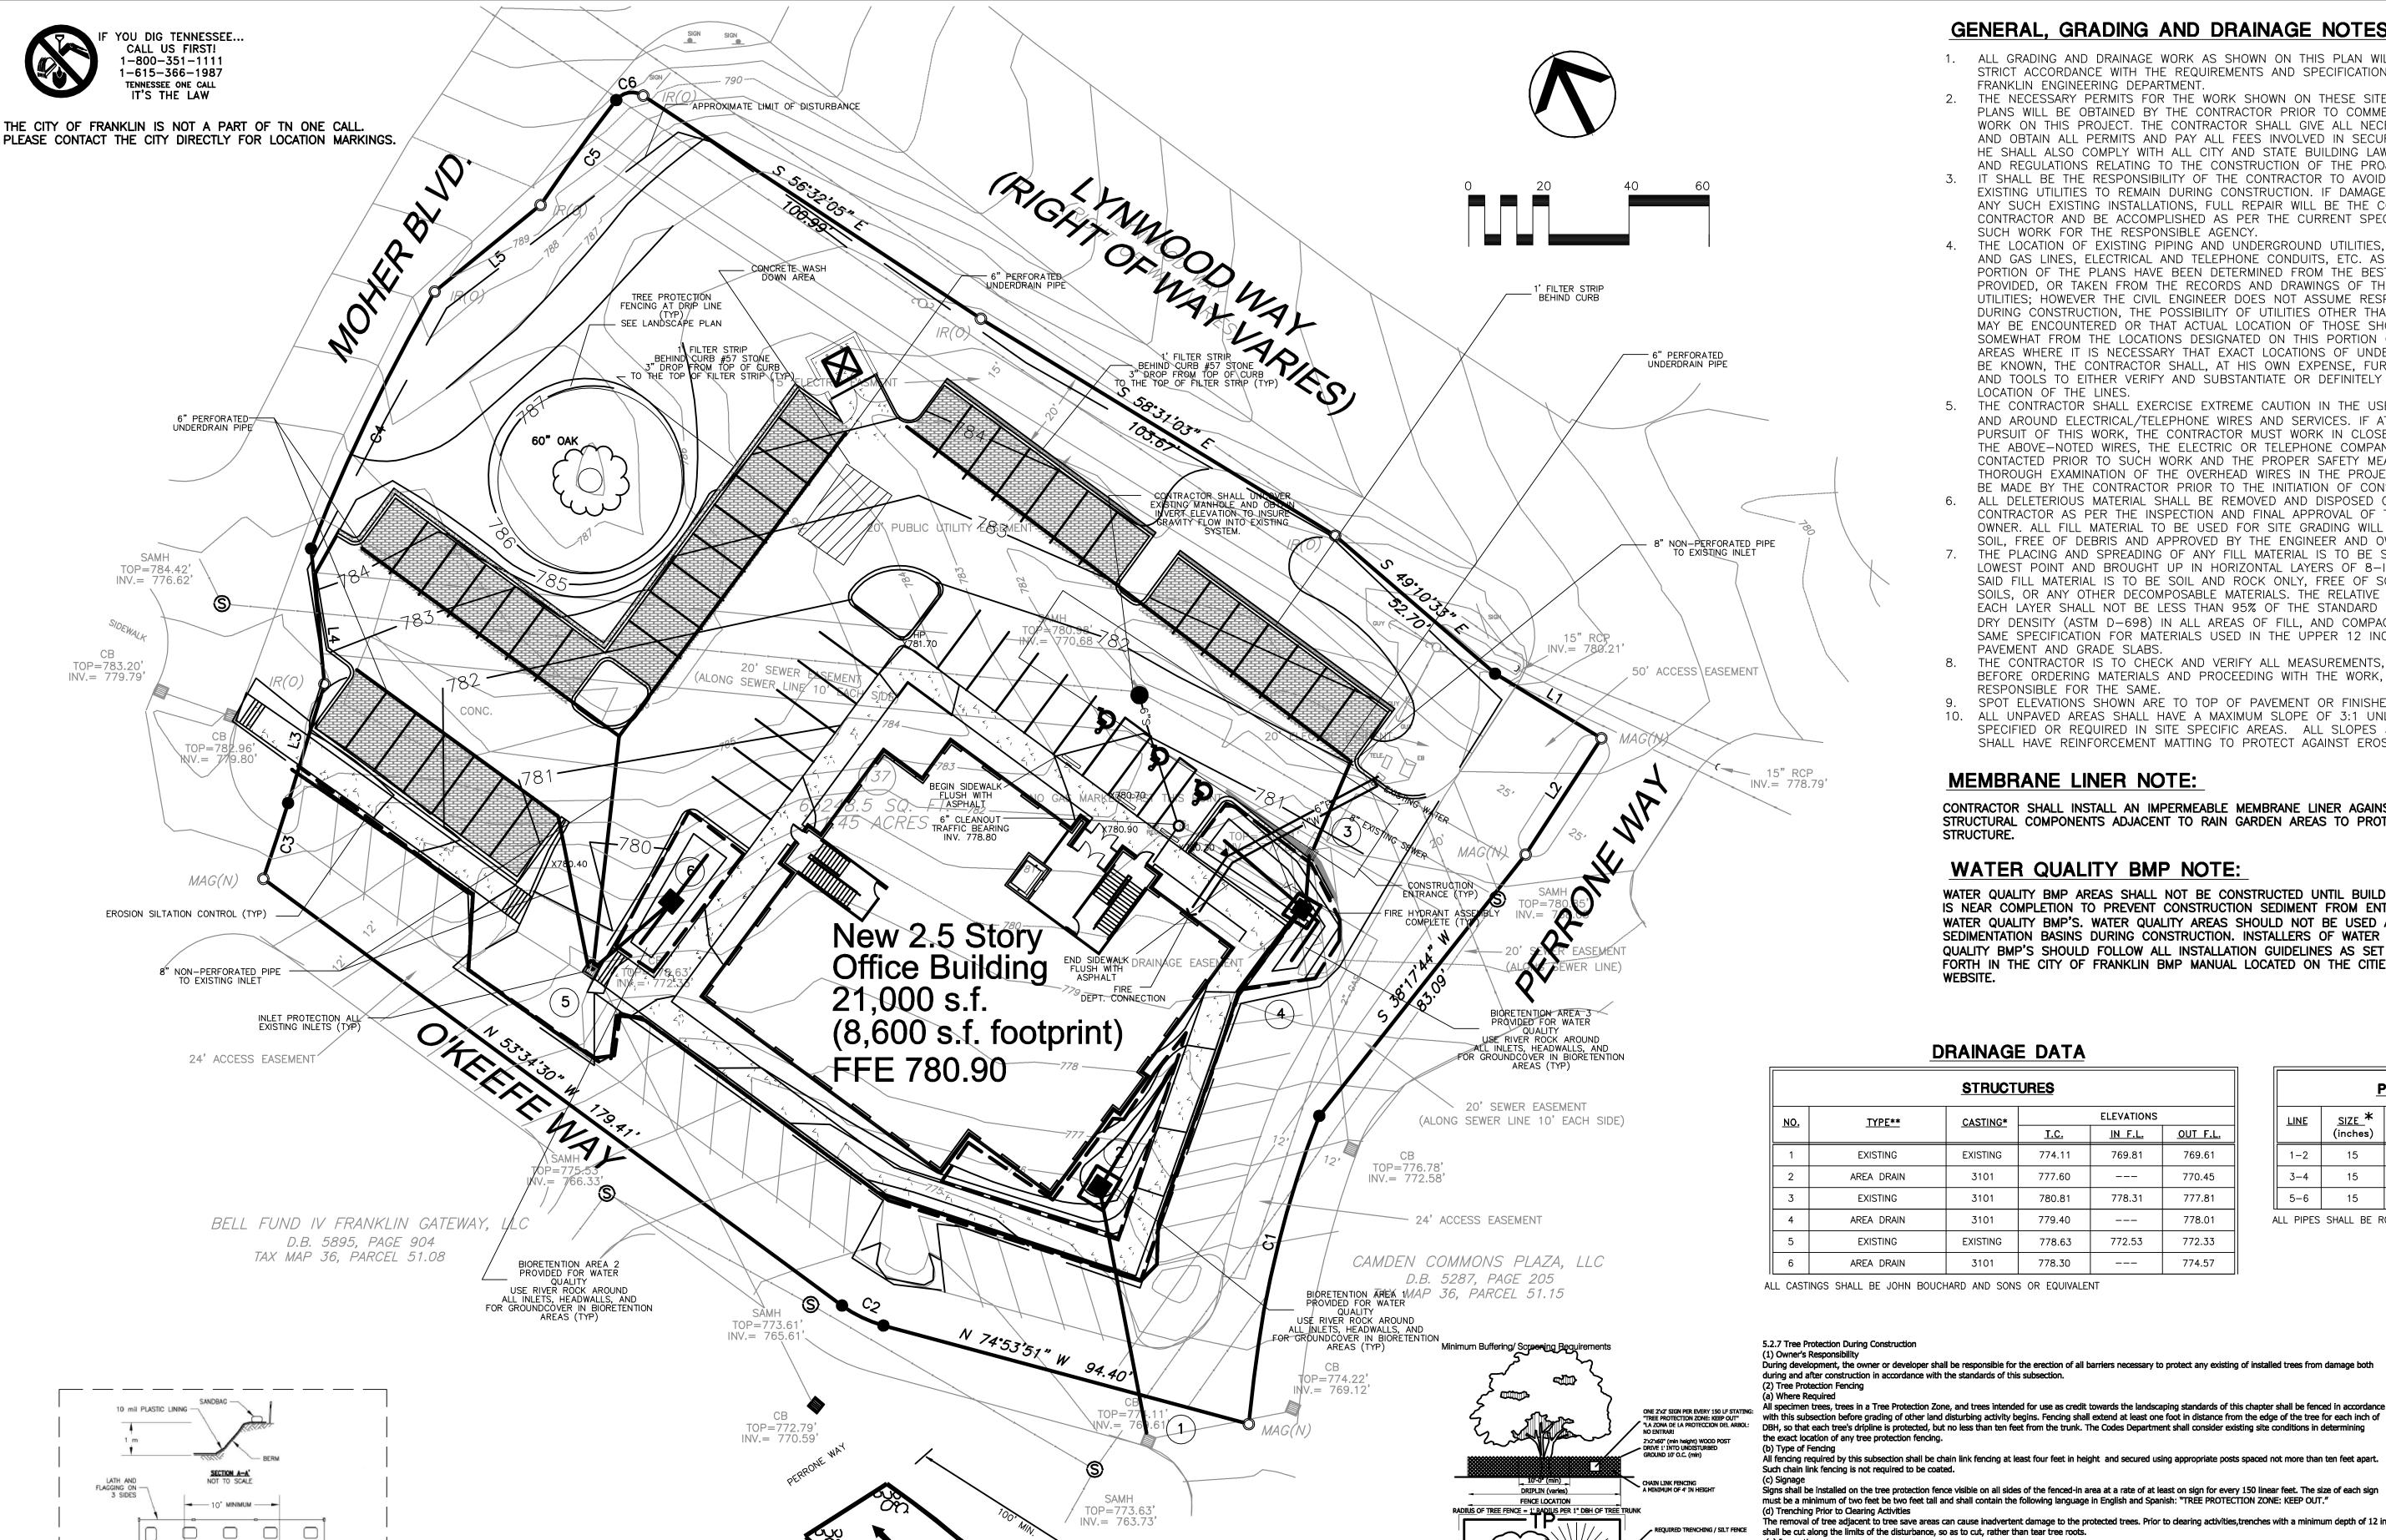

TYPE "BELOW GRADE"

CONCRETE WASH DOWN AREA DETAIL

NOT TO SCALE

STONE SIZE ASTM-D448

SECTION A-A

FROM TIRES BY CONSTRUCTION TRAFFIC.

WIDTH AS REQUIRED TO ACCOMMODATE TRAFFIC (12' MIN) STONE IS TO BE MAINTAINED TO PREVENT MUD TRACKING

GEOTEXTILE FABRIC FILTER TO STABILIZE

TEMPORARY CONSTRUCTION ENTRANCE DETAIL

NOT TO SCALE

FOUNDATION

(3" DIAMETER)

EXISTING

GRADE

GENERAL, GRADING AND DRAINAGE NOTES:

- ALL GRADING AND DRAINAGE WORK AS SHOWN ON THIS PLAN WILL BE DONE IN STRICT ACCORDANCE WITH THE REQUIREMENTS AND SPECIFICATIONS OF THE FRANKLIN ENGINEERING DEPARTMENT.
- THE NECESSARY PERMITS FOR THE WORK SHOWN ON THESE SITE DEVELOPMENT PLANS WILL BE OBTAINED BY THE CONTRACTOR PRIOR TO COMMENCEMENT OF ANY WORK ON THIS PROJECT. THE CONTRACTOR SHALL GIVE ALL NECESSARY NOTICES AND OBTAIN ALL PERMITS AND PAY ALL FEES INVOLVED IN SECURING SAID PERMITS. HE SHALL ALSO COMPLY WITH ALL CITY AND STATE BUILDING LAWS, ORDINANCES AND REGULATIONS RELATING TO THE CONSTRUCTION OF THE PROJECT
- IT SHALL BE THE RESPONSIBILITY OF THE CONTRACTOR TO AVOID DAMAGE TO ALL EXISTING UTILITIES TO REMAIN DURING CONSTRUCTION. IF DAMAGE DOES OCCUR TO ANY SUCH EXISTING INSTALLATIONS, FULL REPAIR WILL BE THE COST OF THE CONTRACTOR AND BE ACCOMPLISHED AS PER THE CURRENT SPECIFICATIONS FOR SUCH WORK FOR THE RESPONSIBLE AGENCY.
- THE LOCATION OF EXISTING PIPING AND UNDERGROUND UTILITIES, SUCH AS WATER AND GAS LINES, ELECTRICAL AND TELEPHONE CONDUITS, ETC. AS SHOWN ON THIS PORTION OF THE PLANS HAVE BEEN DETERMINED FROM THE BEST INFORMATION PROVIDED, OR TAKEN FROM THE RECORDS AND DRAWINGS OF THE EXISTING UTILITIES; HOWEVER THE CIVIL ENGINEER DOES NOT ASSUME RESPONSIBILITY THAT, DURING CONSTRUCTION, THE POSSIBILITY OF UTILITIES OTHER THAN THOSE SHOWN MAY BE ENCOUNTERED OR THAT ACTUAL LOCATION OF THOSE SHOWN MAY VARY SOMEWHAT FROM THE LOCATIONS DESIGNATED ON THIS PORTION OF THE PLANS. IN AREAS WHERE IT IS NECESSARY THAT EXACT LOCATIONS OF UNDERGROUND LINES BE KNOWN, THE CONTRACTOR SHALL, AT HIS OWN EXPENSE, FURNISH ALL LABOR AND TOOLS TO EITHER VERIFY AND SUBSTANTIATE OR DEFINITELY ESTABLISH THE LOCATION OF THE LINES.
- THE CONTRACTOR SHALL EXERCISE EXTREME CAUTION IN THE USE OF EQUIPMENT IN AND AROUND ELECTRICAL/TELEPHONE WIRES AND SERVICES. IF AT ANY TIME IN THE PURSUIT OF THIS WORK, THE CONTRACTOR MUST WORK IN CLOSE PROXIMITY OF THE ABOVE-NOTED WIRES, THE ELECTRIC OR TELEPHONE COMPANIES SHALL BE CONTACTED PRIOR TO SUCH WORK AND THE PROPER SAFETY MEASURES TAKEN. A THOROUGH EXAMINATION OF THE OVERHEAD WIRES IN THE PROJECT AREA SHOULD BE MADE BY THE CONTRACTOR PRIOR TO THE INITIATION OF CONSTRUCTION
- ALL DELETERIOUS MATERIAL SHALL BE REMOVED AND DISPOSED OF OFF-SITE BY CONTRACTOR AS PER THE INSPECTION AND FINAL APPROVAL OF THE ENGINEER AND OWNER. ALL FILL MATERIAL TO BE USED FOR SITE GRADING WILL BE AN INORGANIC SOIL. FREE OF DEBRIS AND APPROVED BY THE ENGINEER AND OWNER
- THE PLACING AND SPREADING OF ANY FILL MATERIAL IS TO BE STARTED AT THE LOWEST POINT AND BROUGHT UP IN HORIZONTAL LAYERS OF 8-INCH THICKNESS. SAID FILL MATERIAL IS TO BE SOIL AND ROCK ONLY, FREE OF SOD, ROOTS, FROZEN SOILS, OR ANY OTHER DECOMPOSABLE MATERIALS. THE RELATIVE COMPACTION OF EACH LAYER SHALL NOT BE LESS THAN 95% OF THE STANDARD PROCTOR MAXIMUM DRY DENSITY (ASTM D-698) IN ALL AREAS OF FILL, AND COMPACTION OF 95% OF SAME SPECIFICATION FOR MATERIALS USED IN THE UPPER 12 INCHES BENEATH PAVEMENT AND GRADE SLABS.
- THE CONTRACTOR IS TO CHECK AND VERIFY ALL MEASUREMENTS, LEVELS, ETC., BEFORE ORDERING MATERIALS AND PROCEEDING WITH THE WORK, AND IS TO BE RESPONSIBLE FOR THE SAME
- SPOT ELEVATIONS SHOWN ARE TO TOP OF PAVEMENT OR FINISHED GRADE. ALL UNPAVED AREAS SHALL HAVE A MAXIMUM SLOPE OF 3:1 UNLESS OTHERWISE SPECIFIED OR REQUIRED IN SITE SPECIFIC AREAS. ALL SLOPES 3:1 OR GREATER SHALL HAVE REINFORCEMENT MATTING TO PROTECT AGAINST EROSION.

MEMBRANE LINER NOTE:

CONTRACTOR SHALL INSTALL AN IMPERMEABLE MEMBRANE LINER AGAINST ALL STRUCTURAL COMPONENTS ADJACENT TO RAIN GARDEN AREAS TO PROTECT STRUCTURE.

WATER QUALITY BMP NOTE:

WATER QUALITY BMP AREAS SHALL NOT BE CONSTRUCTED UNTIL BUILD OUT IS NEAR COMPLETION TO PREVENT CONSTRUCTION SEDIMENT FROM ENTERING WATER QUALITY BMP'S. WATER QUALITY AREAS SHOULD NOT BE USED AS SEDIMENTATION BASINS DURING CONSTRUCTION. INSTALLERS OF WATER QUALITY BMP'S SHOULD FOLLOW ALL INSTALLATION GUIDELINES AS SET FORTH IN THE CITY OF FRANKLIN BMP MANUAL LOCATED ON THE CITIES

DRAINAGE DATA

	STRUCTURES							
NO.	TYPE**	CASTING*		ELEVATIONS	VATIONS			
	<u></u>	<u> </u>	<u>T.C.</u>	IN F.L.	OUT F.L.			
1	EXISTING	EXISTING	774.11	769.81	769.61			
2	AREA DRAIN	3101	777.60		770.45			
3	EXISTING	3101	780.81	778.31	777.81			
4	AREA DRAIN	3101	779.40		778.01			
5	EXISTING	EXISTING	778.63	772.53	772.33			
6	AREA DRAIN	3101	778.30		774.57			

TREE PROTECTION FENCE
LOCATED AT THE LIMITS
OF THE CRITICAL ROOT ZONE

DETAIL-FILE

TREE PROTECTION FENCE

<u>PIPES</u>				
LINE	<u>SIZE</u> ★ (inches)	<u>LENGTH</u> (feet)	<u>SLOPE</u> (%)	
1-2	15	64	1.00	
3-4	15	20	1.00	
5-6	15	12	2.00	

ALL PIPES SHALL BE RCP

During development, the owner or developer shall be responsible for the erection of all barriers necessary to protect any existing of installed trees from damage both during and after construction in accordance with the standards of this subsection.

All specimen trees, trees in a Tree Protection Zone, and trees intended for use as credit towards the landscaping standards of this chapter shall be fenced in accordance with this subsection before grading of other land disturbing activity begins. Fencing shall extend at least one foot in distance from the edge of the tree for each inch of DBH, so that each tree's dripline is protected, but no less than ten feet from the trunk. The Codes Department shall consider existing site conditions in determining

Il fencing required by this subsection shall be chain link fencing at least four feet in height and secured using appropriate posts spaced not more than ten feet apart.

The removal of tree adjacent to tree save areas can cause inadvertent damage to the protected trees. Prior to dearing activities, trenches with a minimum depth of 12 inches shall be cut along the limits of the disturbance, so as to cut, rather than tear tree roots.

All tree protection measures shall be inspected and approved by the Codes Department prior to the start of any land disturbing activities. Failure to have tree protection measures prior to the commencement of construction is a violation of this ordinance.

The tree protection fencing shall be clearly shown on the Site Plan. No construction, grading, equipment or material storage of any other activity shall be allowed within the fenced area except in accordance with the standards in Subsection 5,2,7 (3), Encroachments Into Root Zones. Fencing shall be maintained until the land disturbance activities are complete.



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COF #5740

HMH Job Number 14035

Revisions

H. Michael Hindman

OFFICE BUILDING FOR

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97 Westgate Circle - Suite 100 Grentwood, Tennessee 37027 615.370.3252 www.hmharchitects.com

Touchstone

Medical

Imaging

LYNWOOD WAY LOT 137 GATEWAY VILLAGE SECTION 3


FRANKLIN, TENNESSEE


HMH 07.28.14


Drawn By

Drawing

GRADING/DRAINAGE

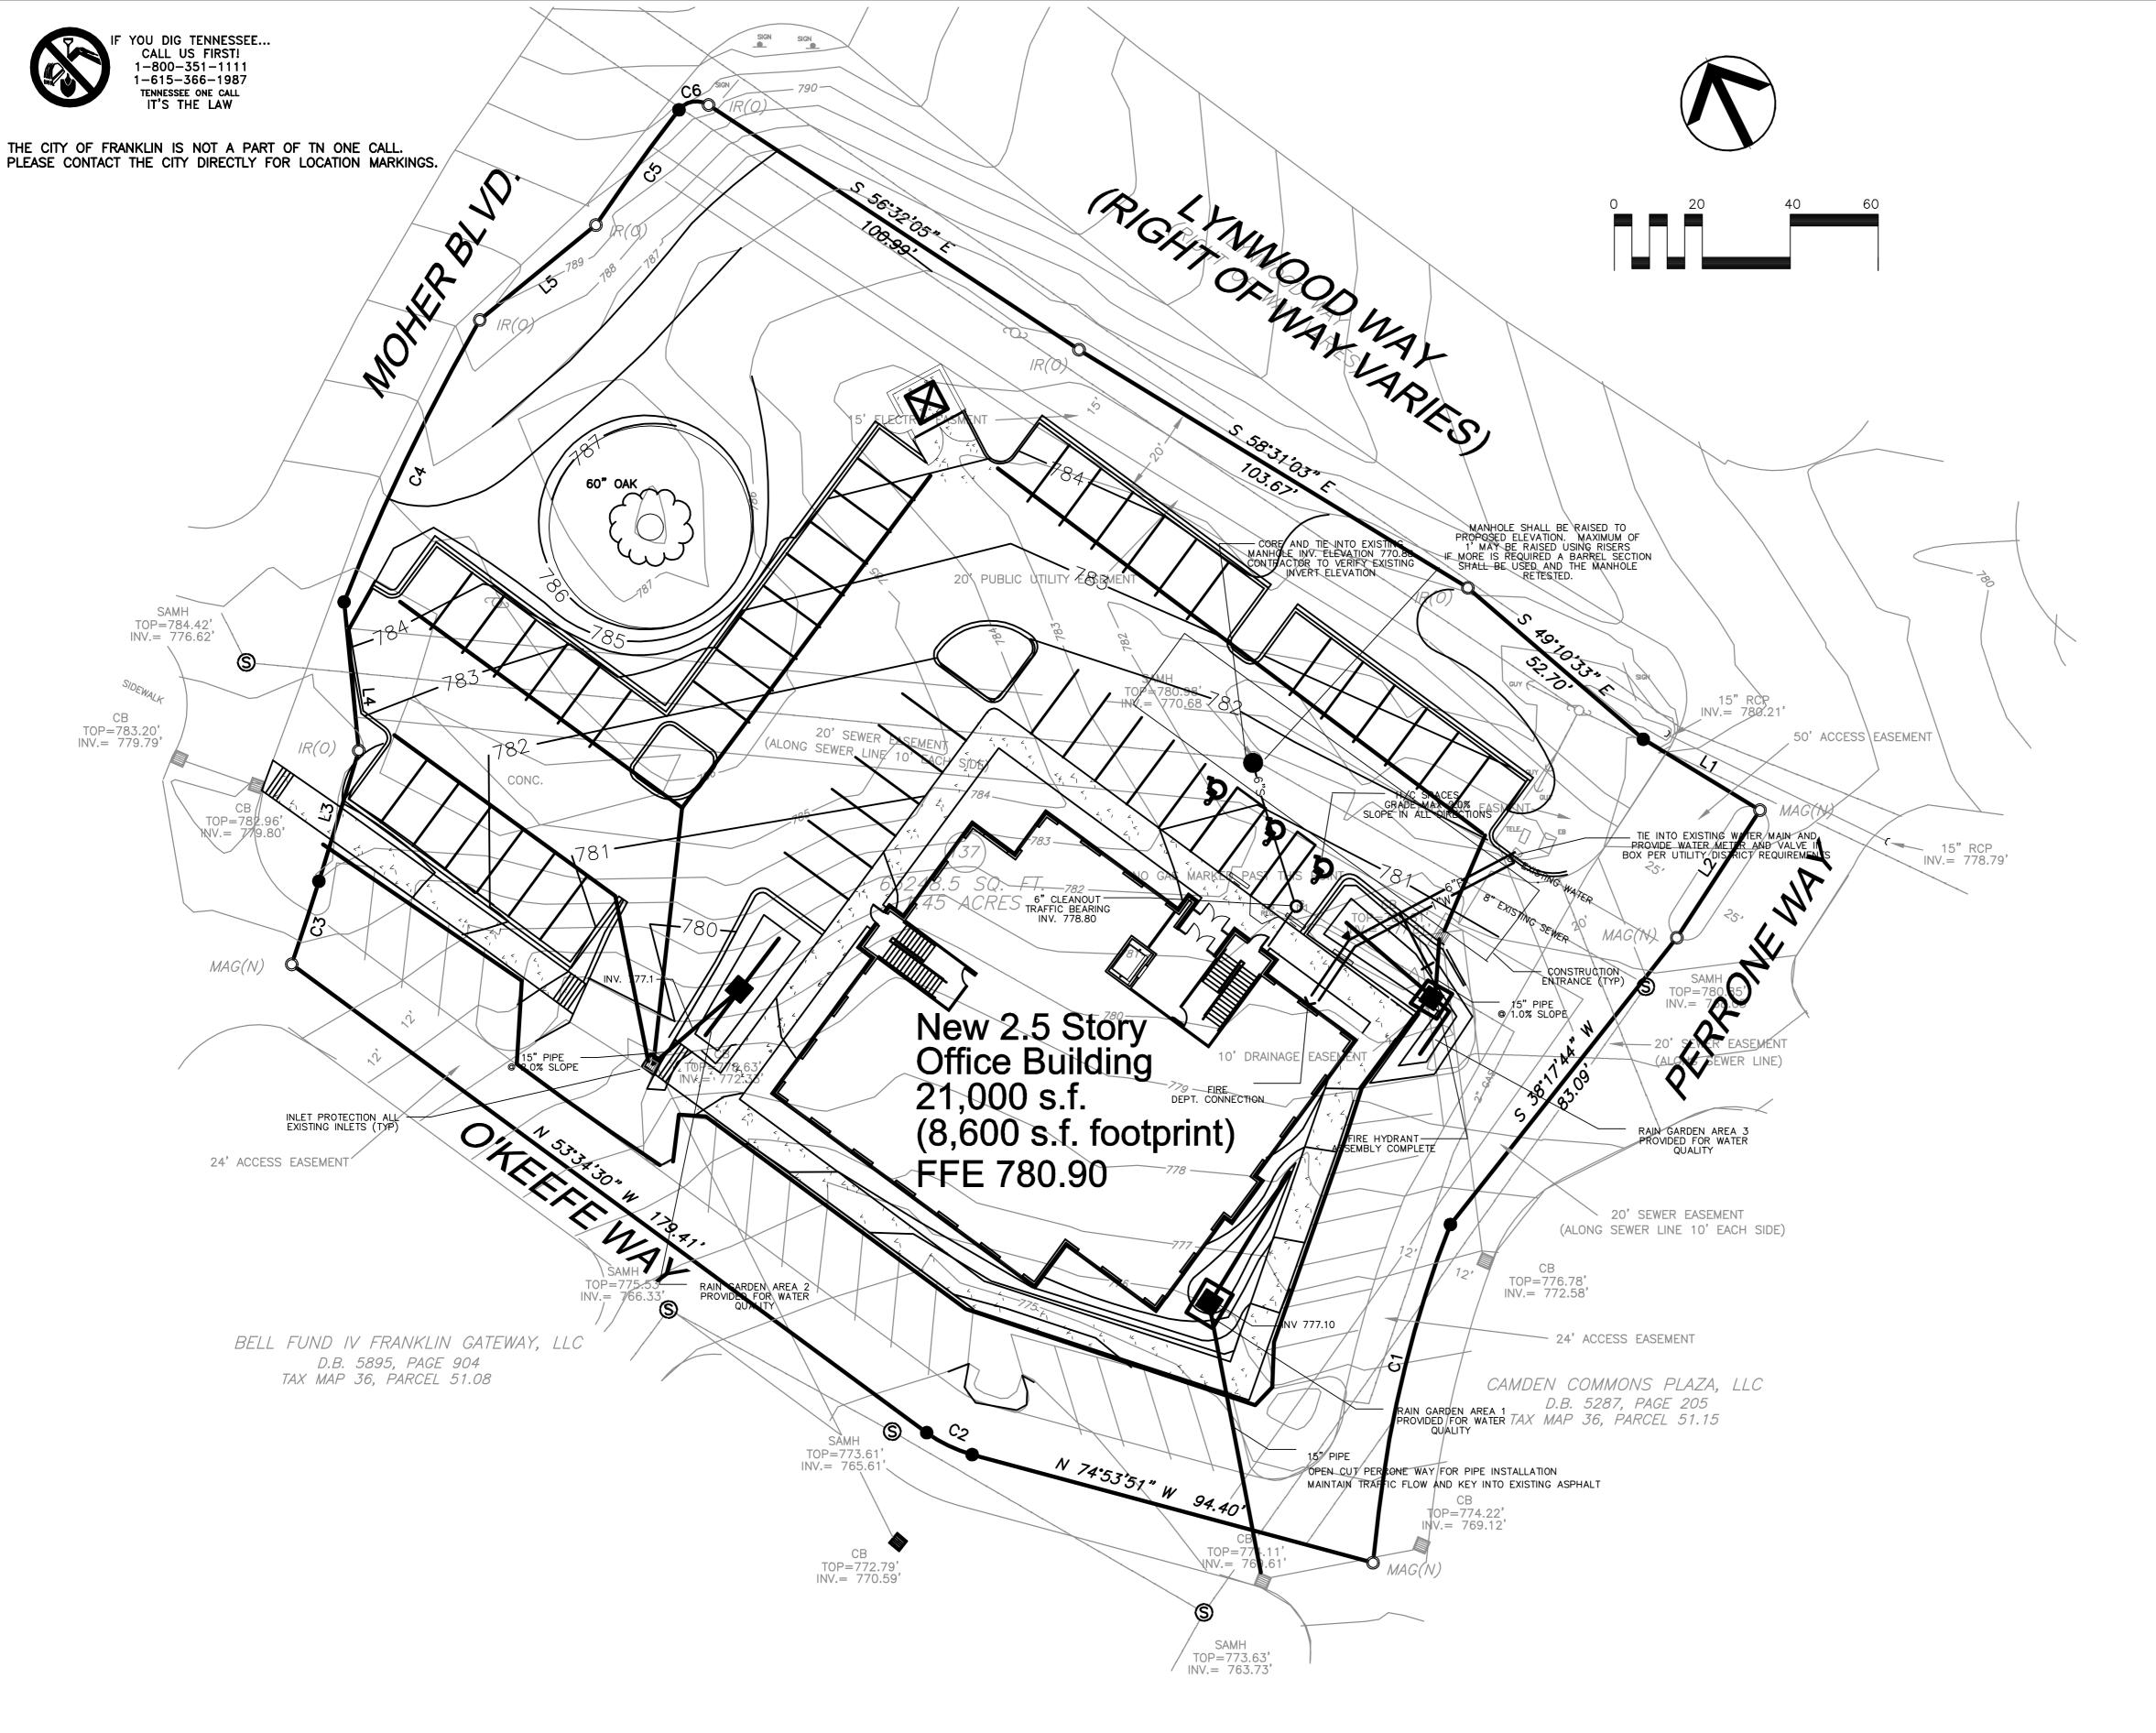

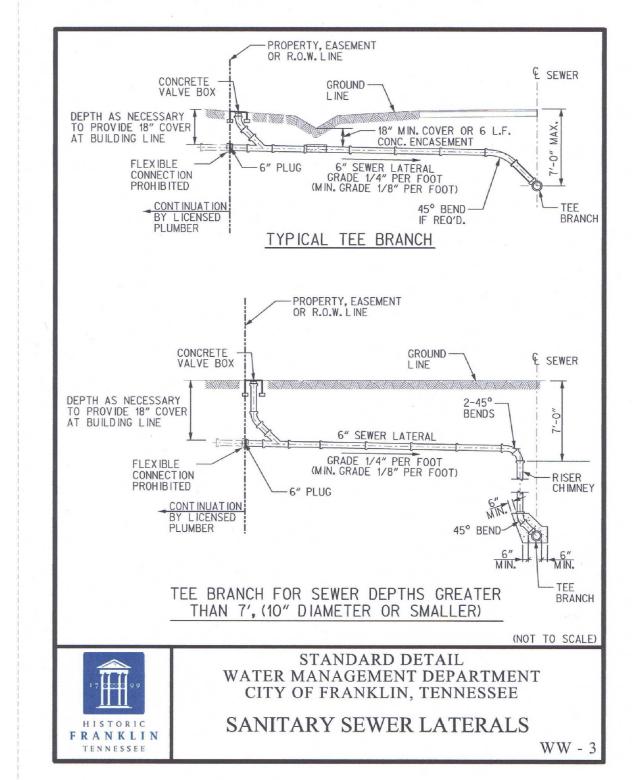

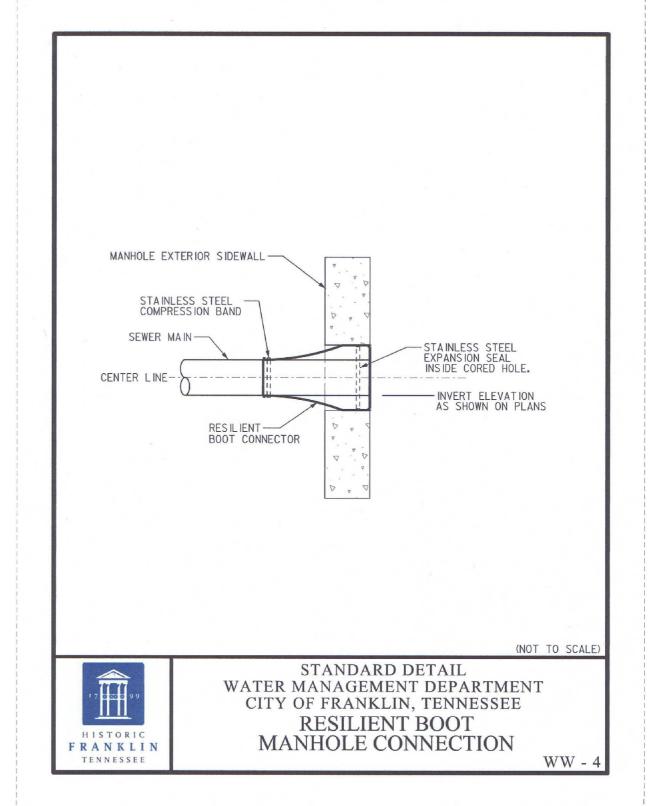

CIVIL DESIGN CONSULTANTS, LLC
CIVIL ENGINEERS • LAND PLANNERS

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Touchstone

LYNWOOD WAY LOT 137 GATEWAY VILLAGE SECTION 3 FRANKLIN, TENNESSEE

Medical

Imaging

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Revisions


Date 07.28.14
Drawing

UTILITY

2A.0

WATER QUALITY BMP NOTE:

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Touchstone Medical Imaging

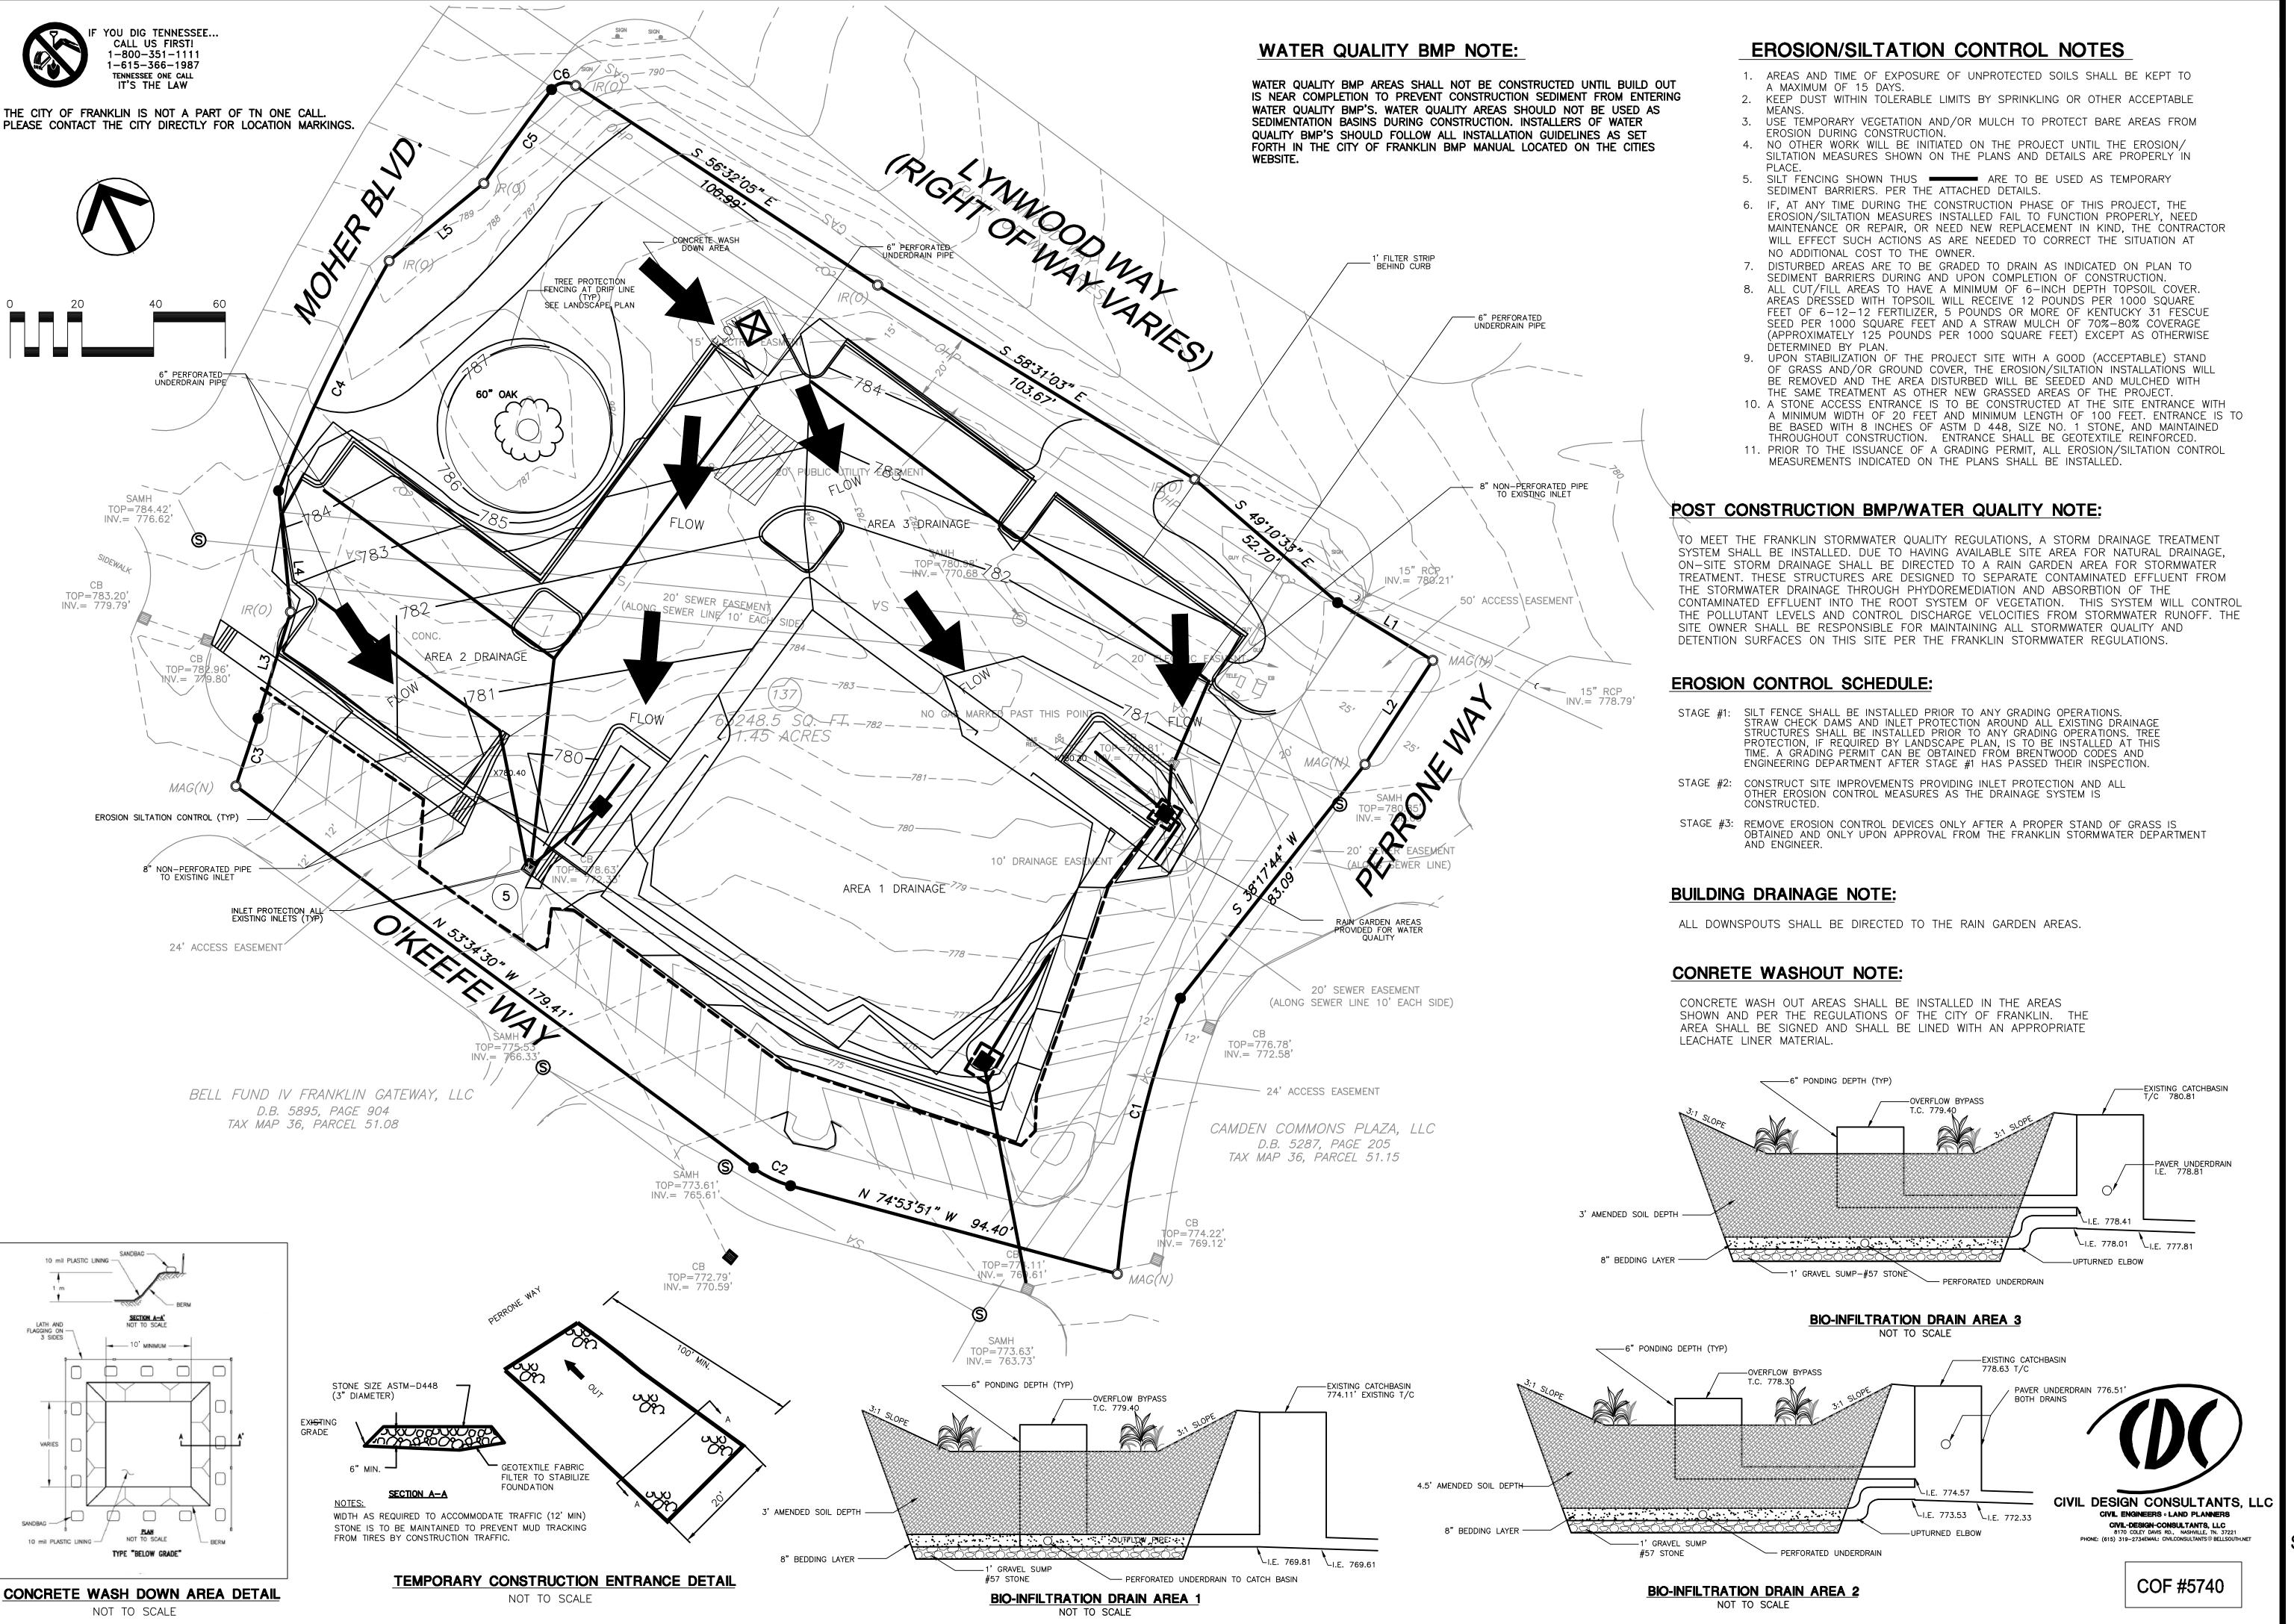LYNWOOD WAY LOT 137 GATEWAY VILLAGE SECTION 3 FRANKLIN, TENNESSEE

OF TENNIHALIAN Revisions

HMH Job Number 14035


Drawn By HMH

Date 07.28.14

Drawing

STORMWATER INITIAL

C3.0

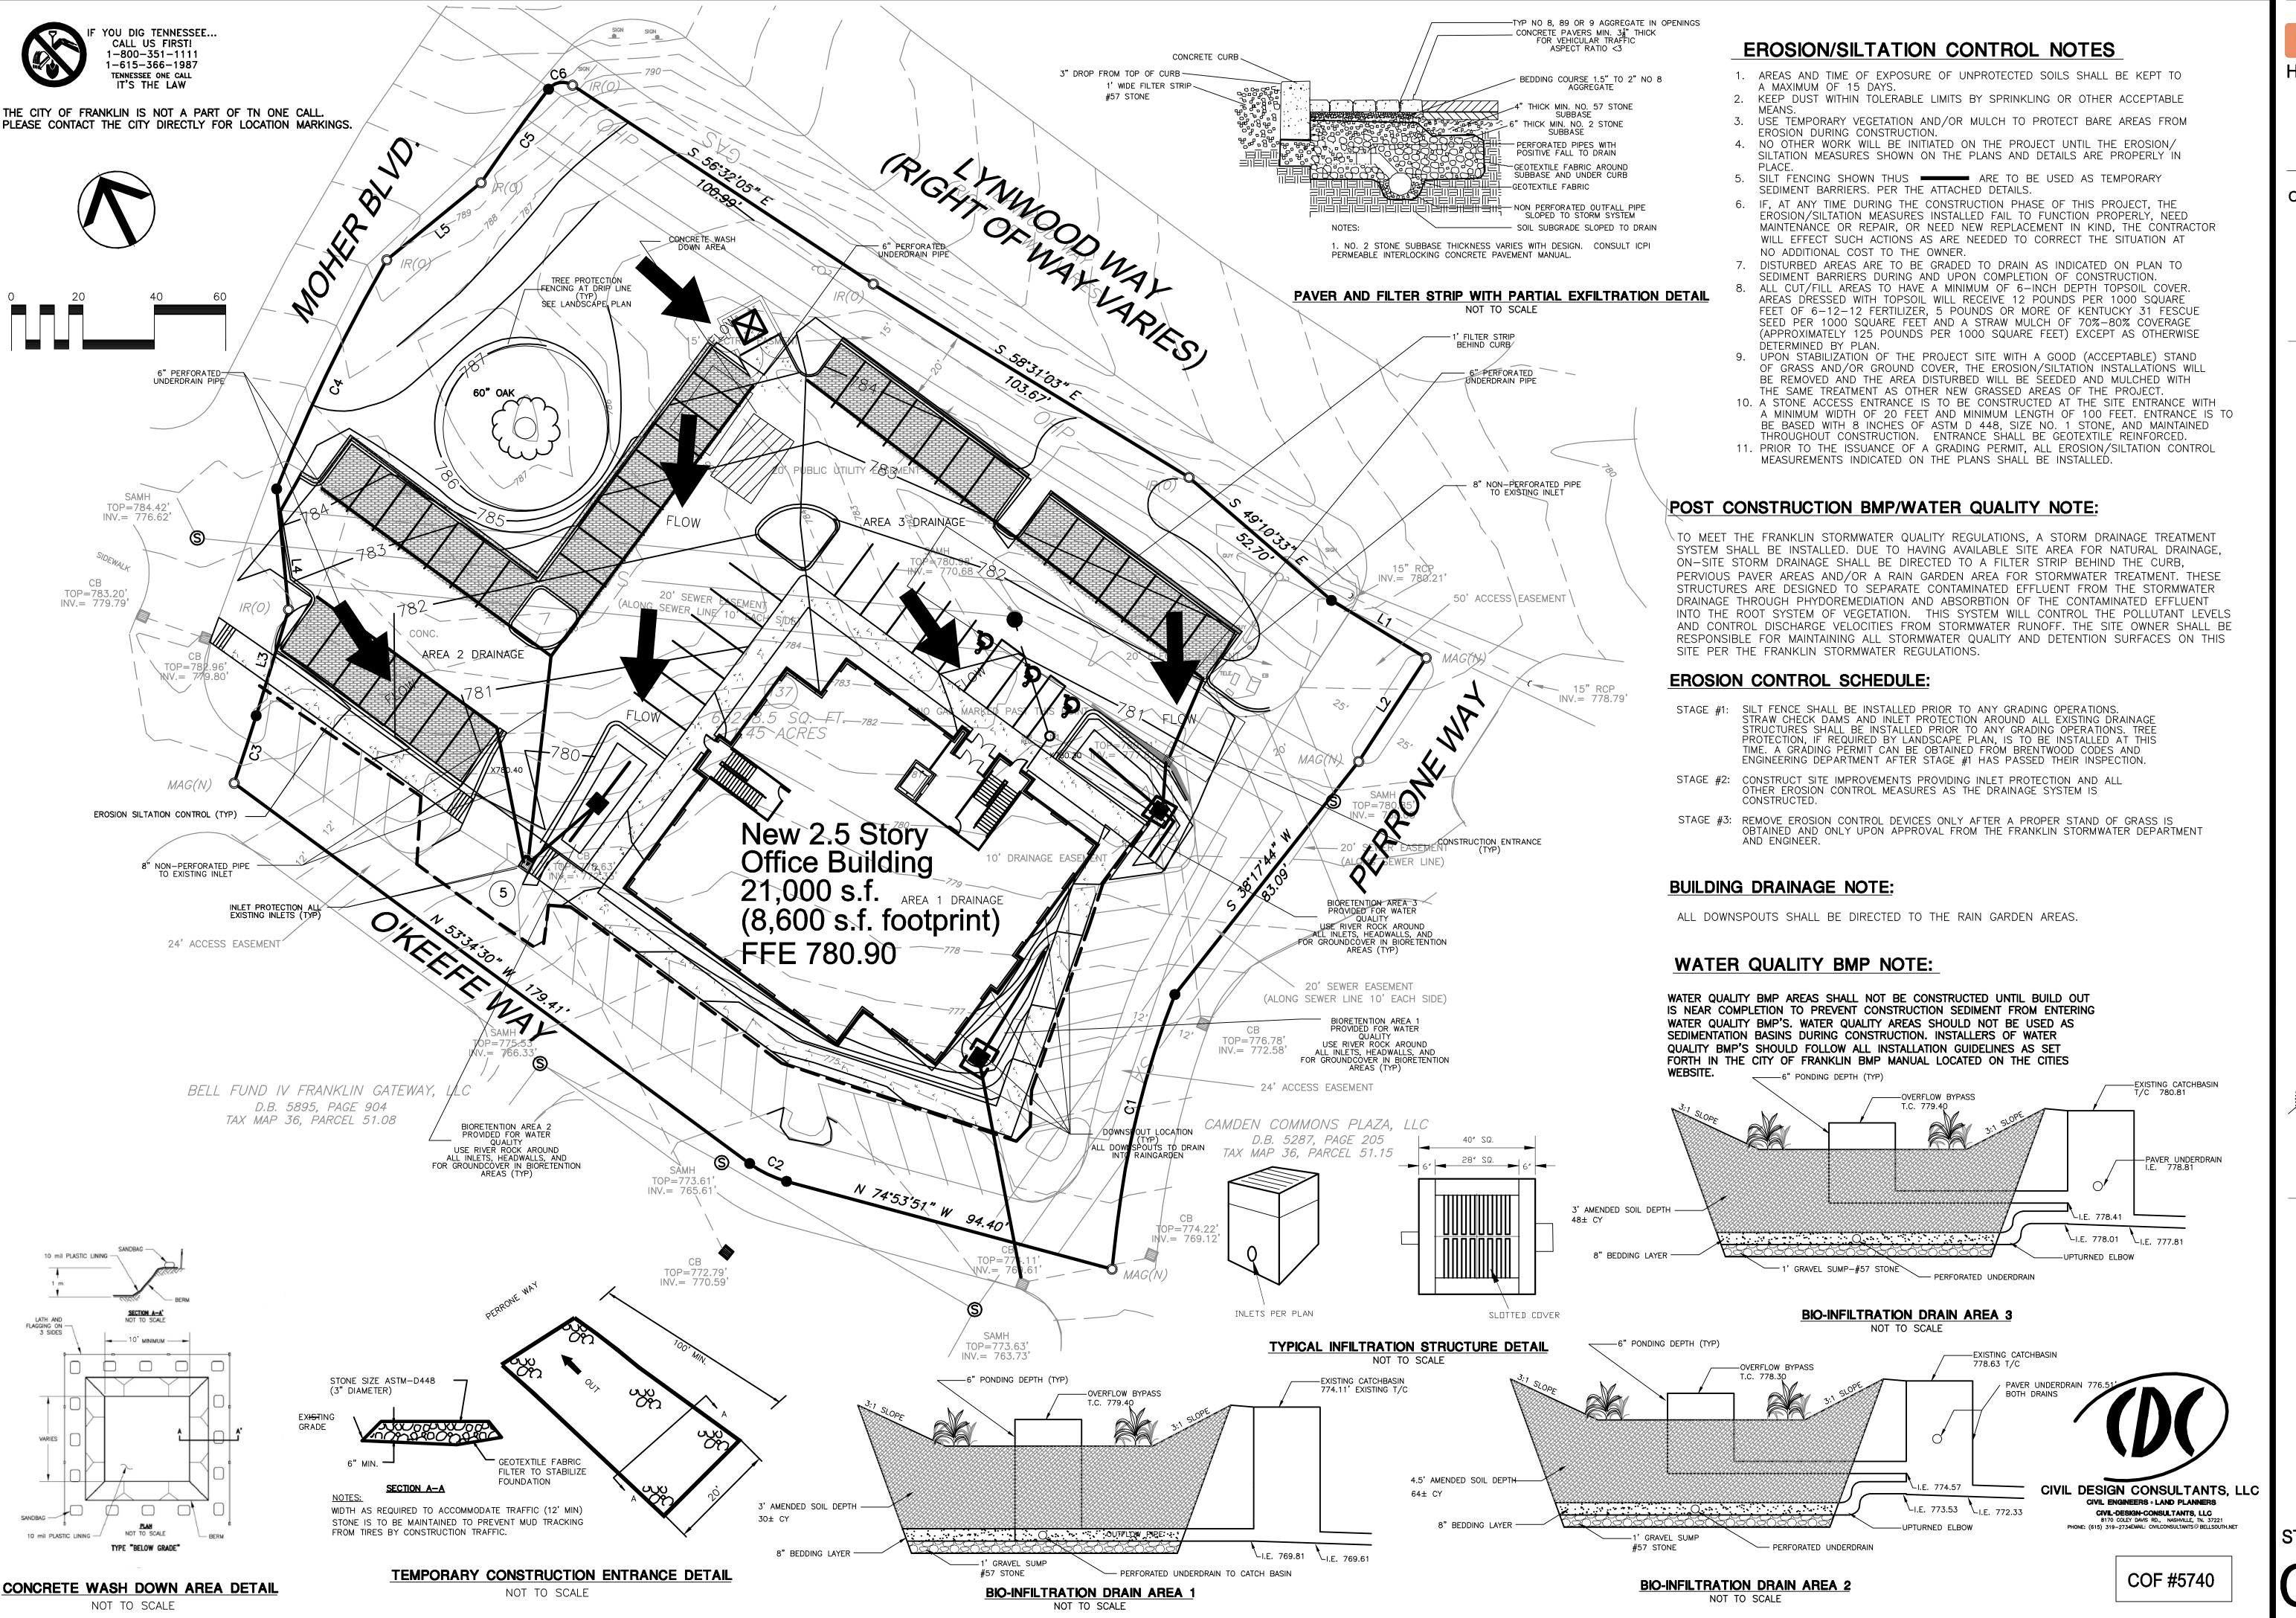

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OFFICE BUILDING FOR

Touchstone Medical Imaging

LYNWOOD WAY LOT 137 GATEWAY VILLAGE SECTION 3 FRANKLIN, TENNESSEE

Revisions

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Drawing


STORMWATER FINAL





OFFICE BUILDING FOR

Touchstone Medical **Imaging**

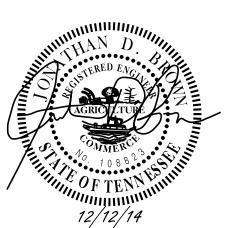

Revisions

CITY COMMENTS 12-12-14

HMH Job Number

PHOTOMETRIC SITE PLAN

Drawn By

16-3/8" DIA.— (ACROSS THE FLATS)

HOLOPHANE ARLINGTON UTILITY SCALE: NONE

ENTIRE SHEET

SITE LIGHTING DATA

\(\frac{1}{9}.9 \) \(\frac{1}{8}.4 \\ \frac{1}{2}.5 \) \(\frac{1}{0}.7 \\ \frac{1}{0}.3 \\ \frac{1}{0}.2 \\ \frac{1}{0}.1 \\ \frac{1}{0}.0 \\ \frac{1}{0}.1 \\ \frac{1}{0}.1 \\ \frac{1}{0}.0 \\ \frac{1}{0}.1 \\ \frac{1}{0}.1 \\ \frac{1}{0}.0 \\ \frac{1}{0}.1 \\ \frac{1}{0}.1

CAMDEN COMMONS PLAZA, LLC

8.7 11 6 3.5 1.2 0.6 0.2 0.1 0.1 0.0

WTD263.3 1.4 0.8 0.4 0.2 0.1 0.0

0.1 0.1 0.2 0.6 1.3 2.8 3.9 4.7 7.4 9.3 2.7 1.2 0.6 0.4 0.2 0.1 0.0 \$0.0

0.2 0.4 0.4 0.5 0.5 1.0 2.2 4.7 4.1 1.8 0.7 0.2 0.1 0.1 0.0 D.B. 5287, PAGE 205

0.1 0.1 0.1 0.0 0.0

<u>√0,0</u> 0.0 0.0 0<u>0</u>€

 $0.2 \quad 0.2 \quad 0.3 \quad 0.5 \quad 1.1 \quad 1.8 \quad 1.7 \quad 1.2 \quad 0.6 \quad 0.2 \quad 0.1 \quad 0.0 \quad 1.0 \quad 0.0 \quad 1.0 \quad 0.0 \quad 0.0$

\$.1 \dagger{0}.1 \dagger{0}.3 \dagger{0}.6 \dagger{0}.8 \dagger{0}.5 \dagger{0}.6 \dagger{0}.3 \dagger{0}.1 \dagger{0}.1 \dagger{0}.4


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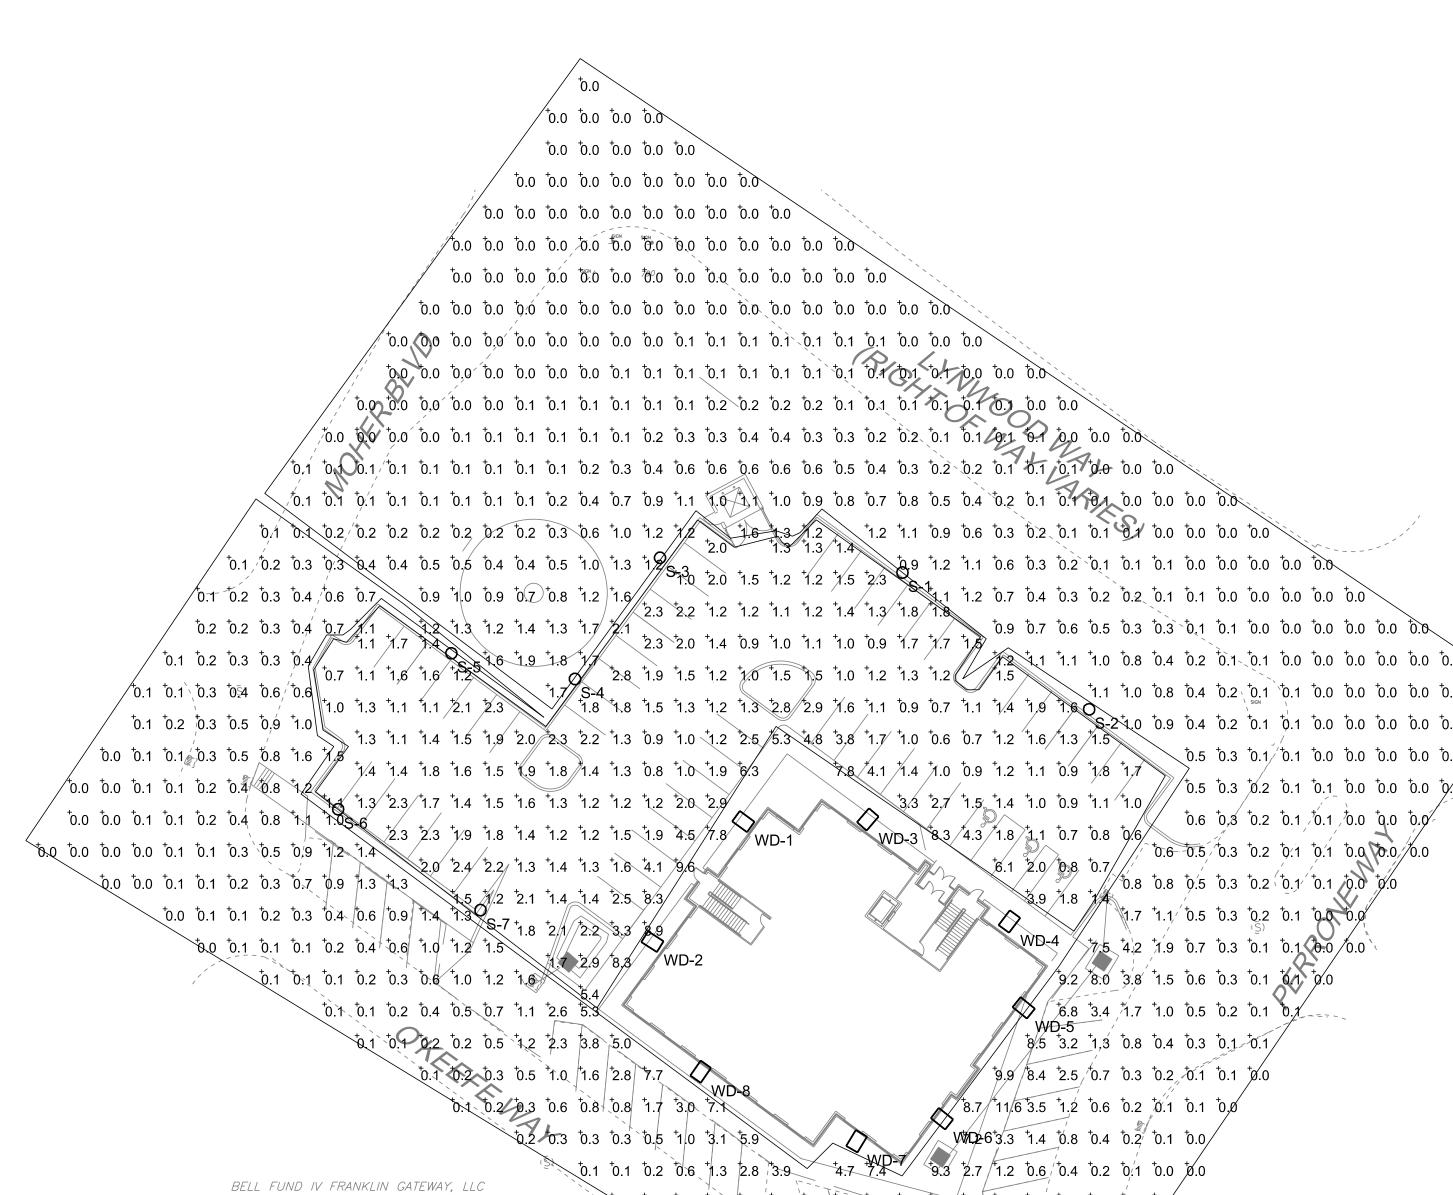
DEVELOPMENT STANDARD: TRADITIONAL LAND USE: NONRESIDENTIAL ZONING DISTRICT: LOCAL MIXED USE DISTRICT HEIGHT OF PROPOSED BUILDING: 42' POLE HEIGHT: 12' POLE/FIXTURE COLOR: BLACK/DARK BRONZE

COLOR OF LIGHT: WHITE/METAL HALIDE

THIS LIGHTING PLAN HAS BEEN DESIGNED TO MEET THE CITY OF FRANKLIN STANDARDS AND THE APPROVAL OF THE PLANNING COMMISSION/CITY OF FRANKLIN. CHANGES SHALL NOT BE MADE TO THE APPROVED LIGHTING PLAN UNLESS APPROVED BY EITHER THE RELEVENT DEPARTMENT SUPERINTENDENT OR THE PLANNING COMMISSION.

PHOTOMETRIC SITE PLAN SCALE: 1" = 30'



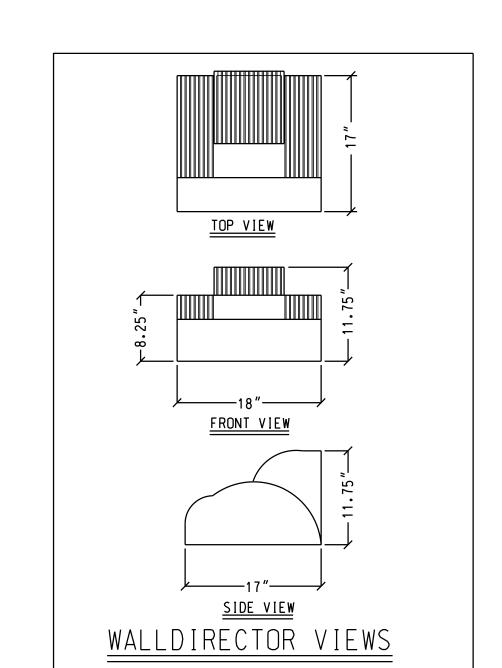


Statistics Symbol Avg Max Min Max/Min Avg/Min Avg/Max Description + 2.0 fc 9.6 fc 0.6 fc 16.0:1 3.3:1 0.2:1 Parking Lot

BELL FUND IV FRANKLIN GATEWAY, LLC

D.B. 5895, PAGE 904 TAX MAP 36, PARCEL 51.08

Luminaire S	chedule										
Symbol	Label	Quantity	Manufacturer	Catalog Number	Description	Lamp	Number Lamps	Filename	Lumens Per Lamp	Light Loss Factor	Wattage
	S	7	HOLOPHANE	ARU 15DMH MA B G3 S H P27 S-64402 WDA 12 F5J 17 P07 ABG BK	Utility Arlington (ARU): ARU, 150W Metal Halide, Medium Base, Multivolt 120,208,240 & 277V. Factory wired for 120V only. UL Only, Black, Asymmetric Glass Refractor, Spike Finial, NEMA twistlock photocontrol receptacle, DTL Twistlock photocontrol 120-277 Wadsworth Aluminum Pole (WDA): Wadsworth Aluminum Pole, 12 feet, 5 inch diameter Fluted, .25 wall, 17 inch Round Base, 3 X 3 Tenon, Anchor bolts, galvanized steel, Powder Coat Paint Finish, Black with Sylvania (MP150/U/MED) 150MH Clear Medium Lamp	150W CLEAR MH	1	42746.IES	13300	0.72	185
	WD	8	KIM LIGHTING	WD18x2/250PMH-ED28	WALL DIRECTOR WALL MOUNTED LUMINAIRE DIE CAST ALUM. REFLECTOR SYSTEM WITH HIGH SPECULAR PANELS DIE CAST ALUM. HOUSING AND LENS FRAME CLEAR FLAT GLASS LENS	250 WATT CLEAR, PMH ED28 LAMP, HORIZONTAL POSITION, RATED AT 22000 INITIAL LUMENS	1	wd18d2- 250p.ies	23000	0.72	250

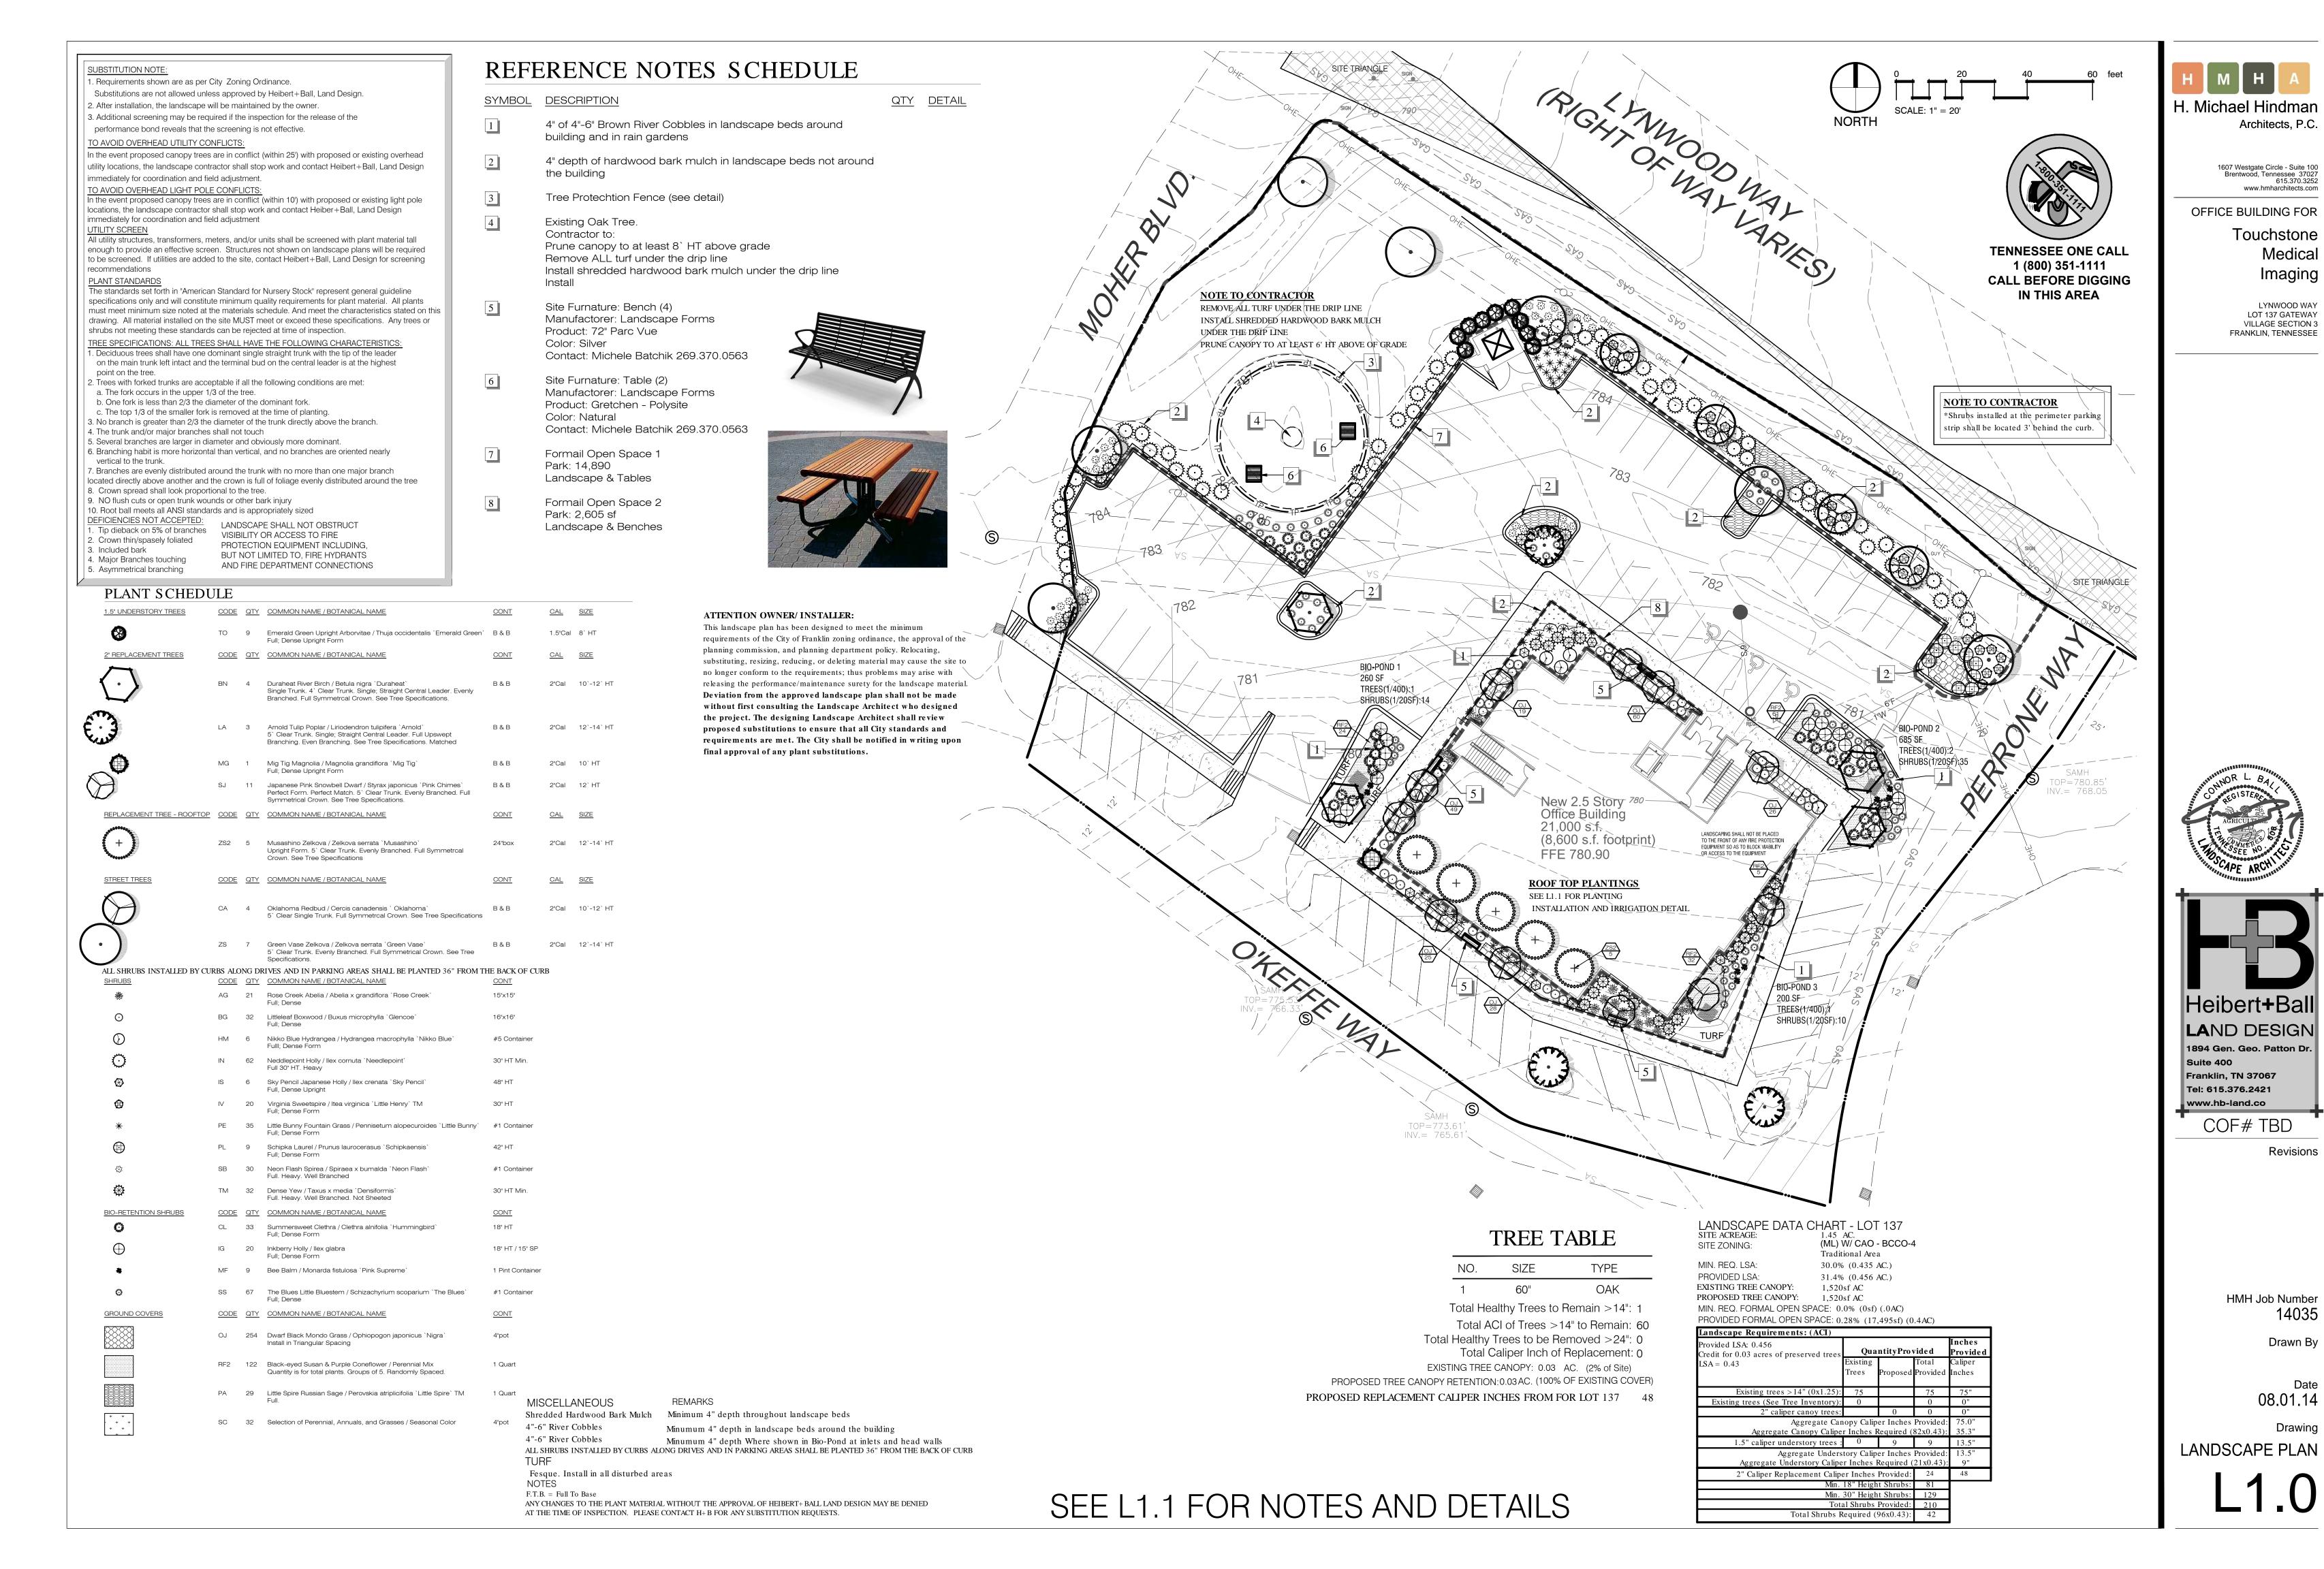

GATEWAY VILLAGE TREE TAKEDOWN CHART	
Site Specimen Tree Replacement Required	
TOTAL SITE INCHES REQUIRED TO BE REPLACED	1,341
TOTAL REPLACEMENT CALIPER INCH FROM SEC. 1	189
TOTAL REPLACEMENT CALIPER INCH FROM SEC. 2	354
TOTAL REPLACEMENT CALIPER INCH FROM SEC. 6	17.75
TOTAL REPLACEMENT CALIPER INCHES FOR SEC 3 LOT 133	105.0
TOTAL REPLACEMENT CALIPER INCHES FROM SEC 3 LOT 143	55.0
TOTAL REPLACEMENT CALIPER INCHES FROM LOT 145	9.0
TOTAL REPLACEMENT CALIPER INCHES FOR SECTION 3 & 6 LOTS 138, 139, 140, 141, 142	198.0
PROPOSED REPLACEMENT CALIPER INCHES FROM FOR LOT 137	48
DEVELOPMENT REPLACEMENT CALIPER INCHES REMAINING:	365.25

SECTION





IN THIS AREA

MINIMUM OPEN SPACE REQUIREMENTS FOR RESIDENTIAL FORMAL OPEN SPACE

AREA	ТҮРЕ	APPROVED AREA OF OPEN SPACE	APPROVED MAXIMUM 25% PAVED AREA	PROPOSED AREA OF OPEN SPACE	PROPOSED MAXIMUM 25% PAVED AREA
F-1	Section 1 Median/Circle	9,996 SF	2,499 SF	9,170 SF	2,292 SF
F-2	Secton 2 Median/Green	6,624 SF	1,656 SF	3,981 SF	995 SF
F-3	Section 2 Park	11,623 SF	2,906 SF	7,150 SF	1,787 SF
F-4	Neighborhood Park	42,171 SF	10,527 SF	42,334 SF	10,583 SF
F-5	Gateway Monument	14,908 SF	3,727 SF	13,041 SF	3,260 SF
F-6 (LOT 135)	Focal Point			5,059 SF	1,264 SF
F-6 (LOT 138)	Focal Point	12,073 SF	3,018 SF	7,491 SF	1,872 SF
F-6 (LOT 145)	Focal Point			1,225 SF	306 SF
F-7	Traffic Circle	8,659 SF	2,165 SF	11,804 SF	2,951 SF
F-8	Plaza	19,528 SF	4,882 SF	24,115 SF	6,028 SF
F-9 (Lot 137)	Park	16,076 SF	4,019 SF	17,495 SF	4,029 SF
F-10	Park	7,852 SF	1,963 SF	12,453 SF	3,113 SF
F-11 (LOT 135)	Plaza			482 SF	120 SF
F-11 (LOT 136)	Plaza	12,701 SF	3,175 SF	2,837 SF	709 SF
F-11 (LOT 145)	Plaza			12,640 SF	3,160 SF
		162,211 SF (3.	72 Acres)	171,277 SF (3.	93 Acres)

• 5% of Developable Area Required for Formal Open Space NOTE: PLANNING COMMISSION APPROVED MINIMUM 160,533 SF

2'x2'x60" (min height) WOOD POST

TREE PROTECTION FENCE

OF THE CRITICAL ROOT ZONE

CRITICAL ROOT ZONE

CHAIN LINK FENCING

Total Developable Area= 41.82 AC, 5% of 41.82 AC =91,040 SF (2.09 AC) • Concept Plan - Staff Comments - Expand Formal Open Space

10'-0" (min)

FENCE LOCATION RADIUS OF TREE FENCE = 1' RADIUS PER 1" DBH OF TREE TRUNK

DRIPLIN (varies)

0" CRITICAL ROOT ZONE FOR A

Minimum Buffering/Screening Requirements

■ Rooftop ☐ Ground

Hvac units, cooling and/or mechanical equipment are mounted on the:

☐ Not Applicable THIS DEVELOPMENT IS REQUIRED TO HAVE THE FOLLOWING

LANDSCAPE IMPROVEMENTS

Buffer/ Screening Type: Purpose: □ Not Applicable Buffering/ Screening not required ■ Foundation planting Along primary facade ■ Perimeter Planting Strip Screen VUAs and to create "modules"

Create VUA "modules" ■ Interior VUA Planting ■ Utility Box Screen Screen from view Screen HVAC from view ■ HVAC Screen ■ Dumpster Screen Screen Dumpster from view ☐ Loading/service Area Buffer the street or residential property Incompatible Use Buffer Buffer the adjacent less intensive use □ 30-foot Front Yard Buffer Buffer the adjacent Hatcher Bypass □ 40-foot Front Yard Buffer Buffer the adjacent Interstate 65

☐ Other: LANDSCAPE ARCHITECT: Heibert+Ball Land Design Connor Ball, PLA

Spatial Definition/Environmental Mitigation

615.376.2421 615.791.3212 phone

FRANKLIN PLANNING DEPARTMENT: 615.791.3257 fax

5.2.7 Tree Protection During Construction

(1) Owner's Responsibility During development, the owner or developer shall be responsible for the erection of all barriers necessary to protect any existing of installed trees from damage both during and after construction in accordance with the standards of this subsection. (2) Tree Protection Fencing

■ Street Trees

(a) Where Required All specimen trees, trees in a Tree Protection Zone, and trees intended for use as credit towards the landscaping standards of this chapter shall be fenced in accordance ONE 2'x2' SIGN PER EVERY 150 LF STATING: with this subsection before grading of other land disturbing activity begins. Fencing shall extend at least one foot in distance from the edge of the tree for each inch of "TREE PROTECTION ZONE: KEEP OUT"
"LA ZONA DE LA PROTECCION DEL ARBOL: DBH, so that each tree's dripline is protected, but no less than ten feet from the trunk. The Codes Department shall consider existing site conditions in determining the exact location of any tree protection fencing.

> All fencing required by this subsection shall be chain link fencing at least four feet in height and secured using appropriate posts spaced not more than ten feet apart. Such chain link fencing is not required to be coated.

Signs shall be installed on the tree protection fence visible on all sides of the fenced-in area at a rate of at least on sign for every 150 linear feet. The size of each sign must be a minimum of two feet be two feet tall and shall contain the following language in English and Spanish: "TREE PROTECTION ZONE: KEEP OUT." (d) Trenching Prior to Clearing Activities The removal of tree adjacent to tree save areas can cause inadvertent damage to the protected trees. Prior to clearing activities, trenches with a minimum depth of 12 inches

— REQUIRED TRENCHING / SILT FENCE shall be cut along the limits of the disturbance, so as to cut, rather than tear tree roots.


All tree protection measures shall be inspected and approved by the Codes Department prior to the start of any land disturbing activities. Failure to have tree protection measures prior to the commencement of construction is a violation of this ordinance. (f) When Required The tree protection fencing shall be clearly shown on the Site Plan. No construction, grading, equipment or material storage of any other activity shall be allowed

within the fenced area except in accordance with the standards in Subsection 5,2,7 (3), Encroachments Into Root Zones. Fencing shall be maintained until the land PLANTER PLANTING DETAIL / DRIP IRRIGATION CONNECTION

2" TREE - (SEE LANDSCAPE PLAN FOR TYPE) 3" MULCH TO BE 5" LOWER - THAN LIP OF PLANTER TO KEEP FROM COVERING ELEC. BOX DRIP IRRIGATION EMITTER 3 PER TREE — 1/2" PLEX PIPE PLANTER -GEOTEXTILE FABRIC STRUCTURE SOIL PLANTER MIX 6" OF 3/4" GRADED WASHED GRAVEL ROOF TILE PARKING DECK ROOF 1 1/2" SCHEDULE 40 PVC SLEEVE — 3/4" IRRIGATION WATER 1/2" PLEX PIPE — SOURCE 1/2" CHECK VALVE W/ 3/4" GLOBE VALVE (SEE ENG DWG) 1/2" BARB FITTING

SCALE: 1/2" = 1'-0"

TREE PROTECTION FENCE

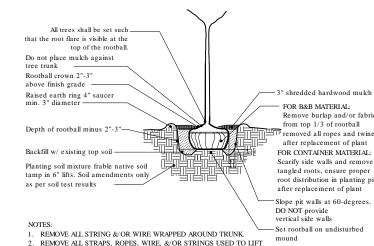

1. REMOVE ALL STRING &/OR WIRE WRAPPED AROUND TRUNK
2. REMOVE ALL STRAPS, ROPES, WIRE, &/OR STRINGS USED TO LIFT 3. DELETE EARTH RING FOR INDIVIDUAL PLANTS IN BED AREAS

TREE PLANTING

Do not place mulch agains Rootball crown 2"-3" above finish grade — — FOR B&B MATERIAL: Remove burlap and/or fa Depth of rootball minus 2"-3"moved all ropes and twi after replacement of plant FOR CONTAINER MATERIAL: Scarify side walls and remov Planting soil mixture frable native soil tangled roots, ensure proper tamp in 6" lifts. Soil amendments only after replacement of plant Slope pit walls at 60-degrees. DO NOT provide vertical side walls NOTES:

1. DELETE EARTH RING FOR INDIVIDUAL PLANTS IN BED AREAS Set rootball on undisturbed

GROUND COVER / PERENNIAL PLANTING GROUNDCOVER PLANTING

NOT TO SCALE

SUBSTITUTION NOTE

PLANT STANDARDS

323101-01

(b) Type of Fencing

disturbance activities are complete.

1. Requirements shown are as per City Zoning Ordinance. Substitutions are not allowed unless approved by Heibert+Ball, Land Design.

2. After installation, the landscape will be maintained by the owner. 3. Additional screening may be required if the inspection for the release of the

performance bond reveals that the screening is not effective. TO AVOID OVERHEAD UTILITY CONFLICTS

In the event proposed canopy trees are in conflict (within 25') with proposed or existing overhead utility locations, the landscape contractor shall stop work and contact Heibert+Ball, Land Design immediately for coordination and field adjustment.

TO AVOID OVERHEAD LIGHT POLE CONFLICTS: In the event proposed canopy trees are in conflict (within 10') with proposed or existing light pole locations, the landscape contractor shall stop work and contact Heiber+Ball, Land Design immediately for coordination and field adjustment

UTILITY SCREEN All utility structures, transformers, meters, and/or units shall be screened with plant material tall enough to provide an effective screen. Structures not shown on landscape plans will be required to be screened. If utilities are added to the site, contact Heibert+Ball, Land Design for screening recommendations

The standards set forth in "American Standard for Nursery Stock" represent general guideline specifications only and will constitute minimum quality requirements for plant material. All plants must meet minimum size noted at the materials schedule. And meet the characteristics stated on this drawing. All material installed on the site MUST meet or exceed these specifications. Any trees or shrubs not meeting these standards can be rejected at time of inspection.

TREE SPECIFICATIONS: ALL TREES SHALL HAVE THE FOLLOWING CHARACTERISTICS: . Deciduous trees shall have one dominant single straight trunk with the tip of the leader on the main trunk left intact and the terminal bud on the central leader is at the highest

point on the tree. 2. Trees with forked trunks are acceptable if all the following conditions are met: a. The fork occurs in the upper 1/3 of the tree. b. One fork is less than 2/3 the diameter of the dominant fork. c. The top 1/3 of the smaller fork is removed at the time of planting.

3. No branch is greater than 2/3 the diameter of the trunk directly above the branch. 4. The trunk and/or major branches shall not touch 5. Several branches are larger in diameter and obviously more dominant. 6. Branching habit is more horizontal than vertical, and no branches are oriented nearly

vertical to the trunk. 7. Branches are evenly distributed around the trunk with no more than one major branch located directly above another and the crown is full of foliage evenly distributed around the tree

8. Crown spread shall look proportional to the tree. 9. NO flush cuts or open trunk wounds or other bark injury 10. Root ball meets all ANSI standards and is appropriately sized **DEFICIENCIES NOT ACCEPTED**

LANDSCAPE SHALL NOT OBSTRUCT . Tip dieback on 5% of branches VISIBILITY OR ACCESS TO FIRE 2. Crown thin/spasely foliated PROTECTION EQUIPMENT INCLUDING, Included bark BUT NOT LIMITED TO, FIRE HYDRANTS 4. Major Branches touching AND FIRE DEPARTMENT CONNECTIONS 5. Asymmetrical branching

installation.

City Landscape Notes 1. The Owner shall submit a Certificate of Landscape Compliance to the Building and Codes Department upon completion of the landscape

2. Upon submittal of a Certificate of Landscape Compliance contact Building and Codes to schedule a Landscape Inspection. 3. No Certificate of Occupancy shall be issued until all landscape materials are in place in substantial compliance with the approved landscape plan.

4. All trees and shrubs shall be tagged according to species. Tags shall not be removed until after the Site Inspection for the issuance of a Certificate of Occupancy 5. Any plant material that dies, turns brown or defoliates shall be replaced within one year or by the next growing season, whichever comes

first. Other defective landscape material shall be replaced within three months. 6. All trees shall be straight trunked, full headed and meet all requirements specified. All trees and shrubs must be container grown or balled and burlapped with sizes indicated on the plant schedule on the approved plans. All plants shall be healthy, vigorous material, free of pest and disease. All rootballs, containers and height to width ratios shall conform to the size standards set forth in the American

Standards for Nursery Stock, current edition. 7. All required deciduous trees shall be a minimum of 2" (two inches) in caliper at planting.

8. All required evergreen trees shall be a minimum of 6' (six feet) in height at planting.

9. All required shrubs shall be a minimum of 18" in height at planting. 10. Any site or landscape changes (including but not limited to a change in design, a reduction in size or number of plant material, or the relocation of overhead or underground utilities) will require a revised landscape plan to be submitted and approved prior to the landscape

11. The Owner acknowledges that landscaping in a dedicated easement does not waive or modify the City rights as the easement holder. The Owner understands that the City, its authorized contractor or applicable private utility may at any time and for any reason perform work within the dedicated easement. The City, its authorized contractor or applicable private utility shall have no liability to the Owner for any damage to the landscaping in the easement when said damage is due to work within the easement. The Owner may be held responsible for the removal of the landscaping to enable work to be done. The Owner shall be solely responsible for any costs incurred in repairing and/or replacing the required landscaping.

12. ATTENTION OWNER/ INSTALLER: This landscape plan has been designed to meet the minimum requirements of the City Zoning ordinance, the approval of the planning commission, and planning department policy. Relocating, substituting, resizing, reducing or deleting material may cause the site to no longer conform to the requirements; Thus problems may arise with releasing the performance/ maintenance bond for landscaping. Deviation from the approved landscape plan shall not be made without first consulting Heibert+ Ball, Land Design and then obtaining approval from either the planning commission or the planning department.

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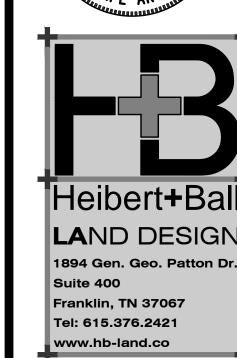
Imaging

LYNWOOD WAY

LOT 137 GATEWAY

VILLAGE SECTION 3

FRANKLIN, TENNESSEE



COF# TBD

Revisions

HMH Job Number

Drawn By

LANDSCAPE PLAN **NOTES & DETAILS**





NOTES

- LOCATON AND NUMBERS OF STOREFRONT DOORS SUBJECT TO CHANGE PER TENANT REQUIREMENTS.
- LOCATION AND NUMBERS OF REAR & EGRESS DOORS SUBJECT TO
- CHANGE PER TENANT REQUIREMENTS. TENANT SIGNS WILL BE SUBMITTED FOR APPROVAL AS TENANT
- REQUIREMENTS ARE DETERMINED. SPECIFIED MATERIALS MAY CHANGE SUBJECT TO AVAILABILITY AT
 - TIME OF CONSTRUCTION AND SUBJECT TO APPROVAL OF BNS DEPARTMENT OR PLANNING COMMISSION. THESE ELEVATIONS HAVE BEEN DESIGNED TO MEET THE
- REQUIREMENTS OF THE CITY OF FRANKLIN'S ARCHITECTURAL DESIGN STANDARDS AND THE APPROVAL OF THE PLANNING COMMISSION. CHANGES SHALL NOT BE MADE TO THE APPROVED ELEVATIONS UNLESS APPROVED BY EITHER THE BNS DEPARTMENT OR THE PLANNING COMMISSION.
- HVAC UNITS ARE LOCATED ON THE ROOFS OF THE BUILDING AND ARE SCREENED FROM PUBLIC VIEW BY PARAPET WALLS.
- CAVITY WALL CONSTRUCTION SHALL BE USED WHEREVER INTEGRALLY COLORED, UNPAINTED, SPLIT FACE CONCRETE BLOCK IS USED TO PREVENT WATER PENETRATION.

EXTERIOR FINISH LEGEND

BRICK	
STYLE/SIZE:	UTILITY
COLOR:	RED/BROWN
MANUFACTURER:	TBD
MORTAR:	TYPE N, STANDAR
MORTAR MANUF.:	TBD

MONUMENTAL CAST STONE
STYLE/SIZE: TRENDSTONE PLUS MONUMENTAL SERIES

COLOR: MW WHITE MANUFACTURER: TRENWYTH MORTAR:

MORTAR MANUF.: ALTERNATE:

BRICK OR CAST STONE OF SIMILAR COLOR

CAST STONE LINTEL & ACCENT BAND STYLE/SIZE: SMOOTH COLOR: BUFFSTONE, GP-A

MANUFACTURER: ROCK CAST SAME AS ADJACENT MASONRY MORTAR:

CAST STONE BASE STYLE/SIZE:

COLOR:

SPLIT/STPS-304 (3.625"x23.625") MANUFACTURER: PRAIRIE STONE

MORTAR: MORTAR MANUF.: NATURAL STONE/PEWTER MIST ALTERNATE:

EIFS CORNICE STYLE/SIZE: SAND FINE LB, THICKNESS PER DWGS

COLOR: 10402 LIMESTONE MANUFACTURER: PAREX, OR EQUAL

STOREFRONT & CURTAIN WALL
STYLE/SIZE: ALUMINUM RECTANGULAR KYNAR CHARCOAL GRAY OR ANODIZED DARK COLOR:

MANUFACTURER: TUBELITE OR EQUAL

<u>GLAZING</u> STYLE/SIZE: 1" INSULATED LOW-E

COLOR: SOLAR BLUE + SOLARBAN 70XL (3) MANUFACTURER: PPG OR EQUAL

PREFINISHED METAL PARAPET COPING
COLOR: SIERRA TAN & SLATE GRAY

MANUFACTURER: BERRIDGE OR EQUAL

METAL PANEL CANOPY & HAT STYLE/SIZE: SMOOT COLOR: PEWTE

SMOOTH METAL PANEL, 18" PEWTER/TITANIUM MANUFACTURER: CENTRIA/ALUCOBOND OR EQUAL

<u>PAINT</u> COLOR:

MATERIAL AREA NOTES

- MINOR MATERIALS INCLUDING COPINGS, FLASHINGS, AND TRIM INSTALLED OVER BRICK ARE NOT INCLUDED IN MATERIAL AREA
- NET WALL AREA EXCLUDES STOREFRONT, DOORS, LOUVERS AND

MATERIAL CALCULATIONS

NORTH ELEVATION

NOICHT EEE VICTOR						
	AREA	% OF NET				
GROSS WALL AREA	4843 S.F.	NA%				
NET WALL AREA	2861 S.F.	100%				
BRICK AREA	1304 S.F.	46%				
CAST STONE AREA	1115 S.F.	39%				
METAL PANEL/CANOPY	86 S.F.	2%				
EIFS	356 S.F.	13%				

WEST ELEVATION

GROSS WALL AREA NET WALL AREA BRICK AREA CAST STONE AREA METAL PANEL/CANOPY FIFS





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> LYNWOOD WAY LOT 137 GATEWAY VILLIAGE SECTION 3 FRANKLIN, TENNESSEE



Revisions 11.13.14 01.05.15

HMH Job Number

Drawn By

Date 01.05.15

Drawing Elevations



East Elevation



NOTES

- LOCATON AND NUMBERS OF STOREFRONT DOORS SUBJECT TO CHANGE PER TENANT REQUIREMENTS.
- LOCATION AND NUMBERS OF REAR & EGRESS DOORS SUBJECT TO
- CHANGE PER TENANT REQUIREMENTS. TENANT SIGNS WILL BE SUBMITTED FOR APPROVAL AS TENANT
- REQUIREMENTS ARE DETERMINED.
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- CAVITY WALL CONSTRUCTION SHALL BE USED WHEREVER INTEGRALLY COLORED, UNPAINTED, SPLIT FACE CONCRETE BLOCK IS USED TO PREVENT WATER PENETRATION.

EXTERIOR FINISH LEGEND

BRICK STYLE/SIZE: UTILITY COLOR: RED/BROWN

MANUFACTURER: TBD TYPE N, STANDARD MORTAR: MORTAR MANUF.:

MORTAR:

MONUMENTAL CAST STONE
STYLE/SIZE: TRENDSTONE PLUS MONUMENTAL SERIES COLOR: MW WHITE

MANUFACTURER: TRENWYTH MORTAR MANUF.: TBD

ALTERNATE: BRICK OR CAST STONE OF SIMILAR COLOR

CAST STONE LINTEL & ACCENT BAND STYLE/SIZE: SMOOTH BUFFSTONE, GP-A COLOR:

MANUFACTURER: ROCK CAST SAME AS ADJACENT MASONRY MORTAR:

CAST STONE BASE STYLE/SIZE:

SPLIT/STPS-304 (3.625"x23.625")

COLOR: MANUFACTURER: PRAIRIE STONE MORTAR:

MORTAR MANUF.: NATURAL STONE/PEWTER MIST ALTERNATE:

EIFS CORNICE STYLE/SIZE: SAND FINE LB, THICKNESS PER DWGS COLOR: 10402 LIMESTONE

MANUFACTURER: PAREX, OR EQUAL

STOREFRONT & CURTAIN WALL
STYLE/SIZE: ALUMINUM RECTANGULAR

KYNAR CHARCOAL GRAY OR ANODIZED DARK COLOR: BRONZE

MANUFACTURER: TUBELITE OR EQUAL

<u>GLAZING</u> STYLE/SIZE: 1" INSULATED LOW-E

COLOR: SOLAR BLUE + SOLARBAN 70XL (3) MANUFACTURER: PPG OR EQUAL

PREFINISHED METAL PARAPET COPING
COLOR: SIERRA TAN & SLATE GRAY

MANUFACTURER: BERRIDGE OR EQUAL

METAL PANEL CANOPY & HAT

STYLE/SIZE: COLOR: SMOOTH METAL PANEL, 18" PEWTER/TITANIUM MANUFACTURER: CENTRIA/ALUCOBOND OR EQUAL

<u>PAINT</u> COLOR:

MATERIAL AREA NOTES

- MINOR MATERIALS INCLUDING COPINGS, FLASHINGS, AND TRIM INSTALLED OVER BRICK ARE NOT INCLUDED IN MATERIAL AREA
- NET WALL AREA EXCLUDES STOREFRONT, DOORS, LOUVERS AND MINOR TRIM.

MATERIAL CALCULATIONS

EAST ELEVATION

	AREA	% OF NET
GROSS WALL AREA	3917 S.F.	NA%
NET WALL AREA	2413 S.F.	100%
BRICK AREA	1091 S.F.	45%
CAST STONE AREA	1102 S.F.	46%
METAL PANEL/CANOPY	48 S.F.	2%
EIFS	172 S.F.	7%

SOUTH ELEVATION

	AREA	% OF NET
GROSS WALL AREA	5570 S.F.	NA%
NET WALL AREA	3602 S.F.	100%
BRICK AREA	1642 S.F.	46%
CAST STONE AREA	1477 S.F.	41%
METAL PANEL/CANOPY	128 S.F.	3%
EIFS	355 S.F.	10%





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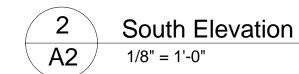
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01.05.15 Drawing

Date

Elevations







2 A3

View from East









4 V

View from West



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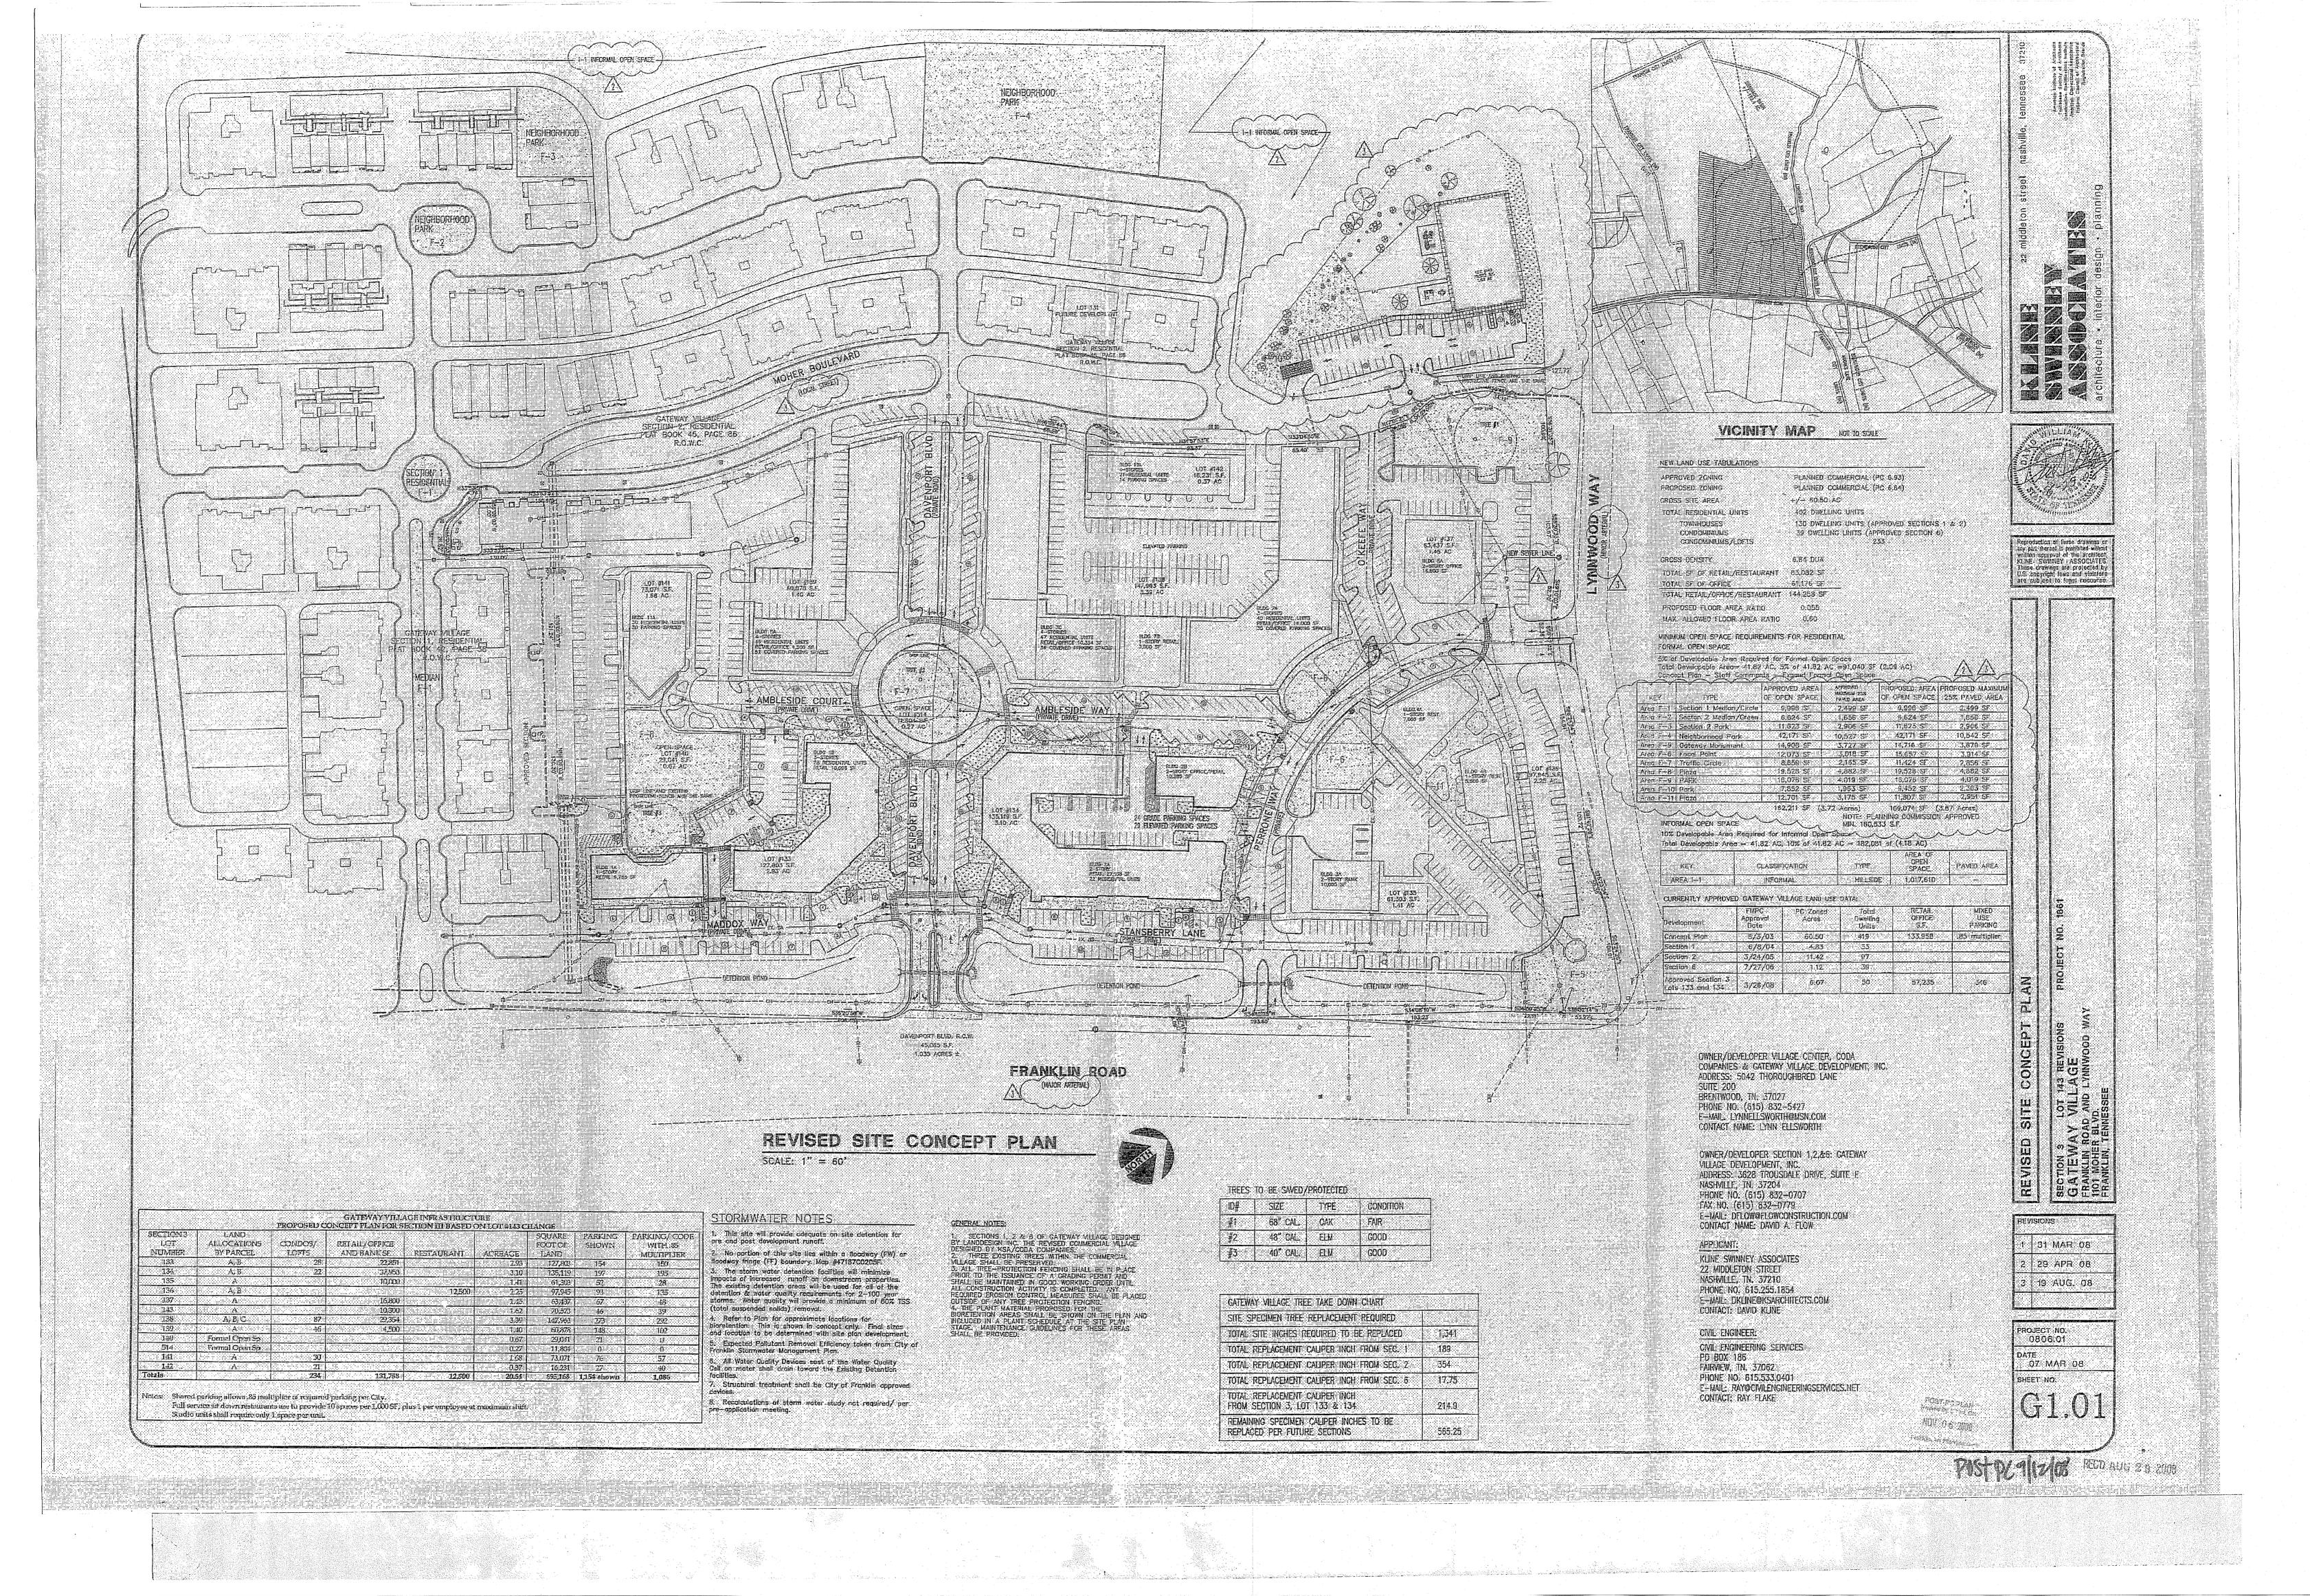
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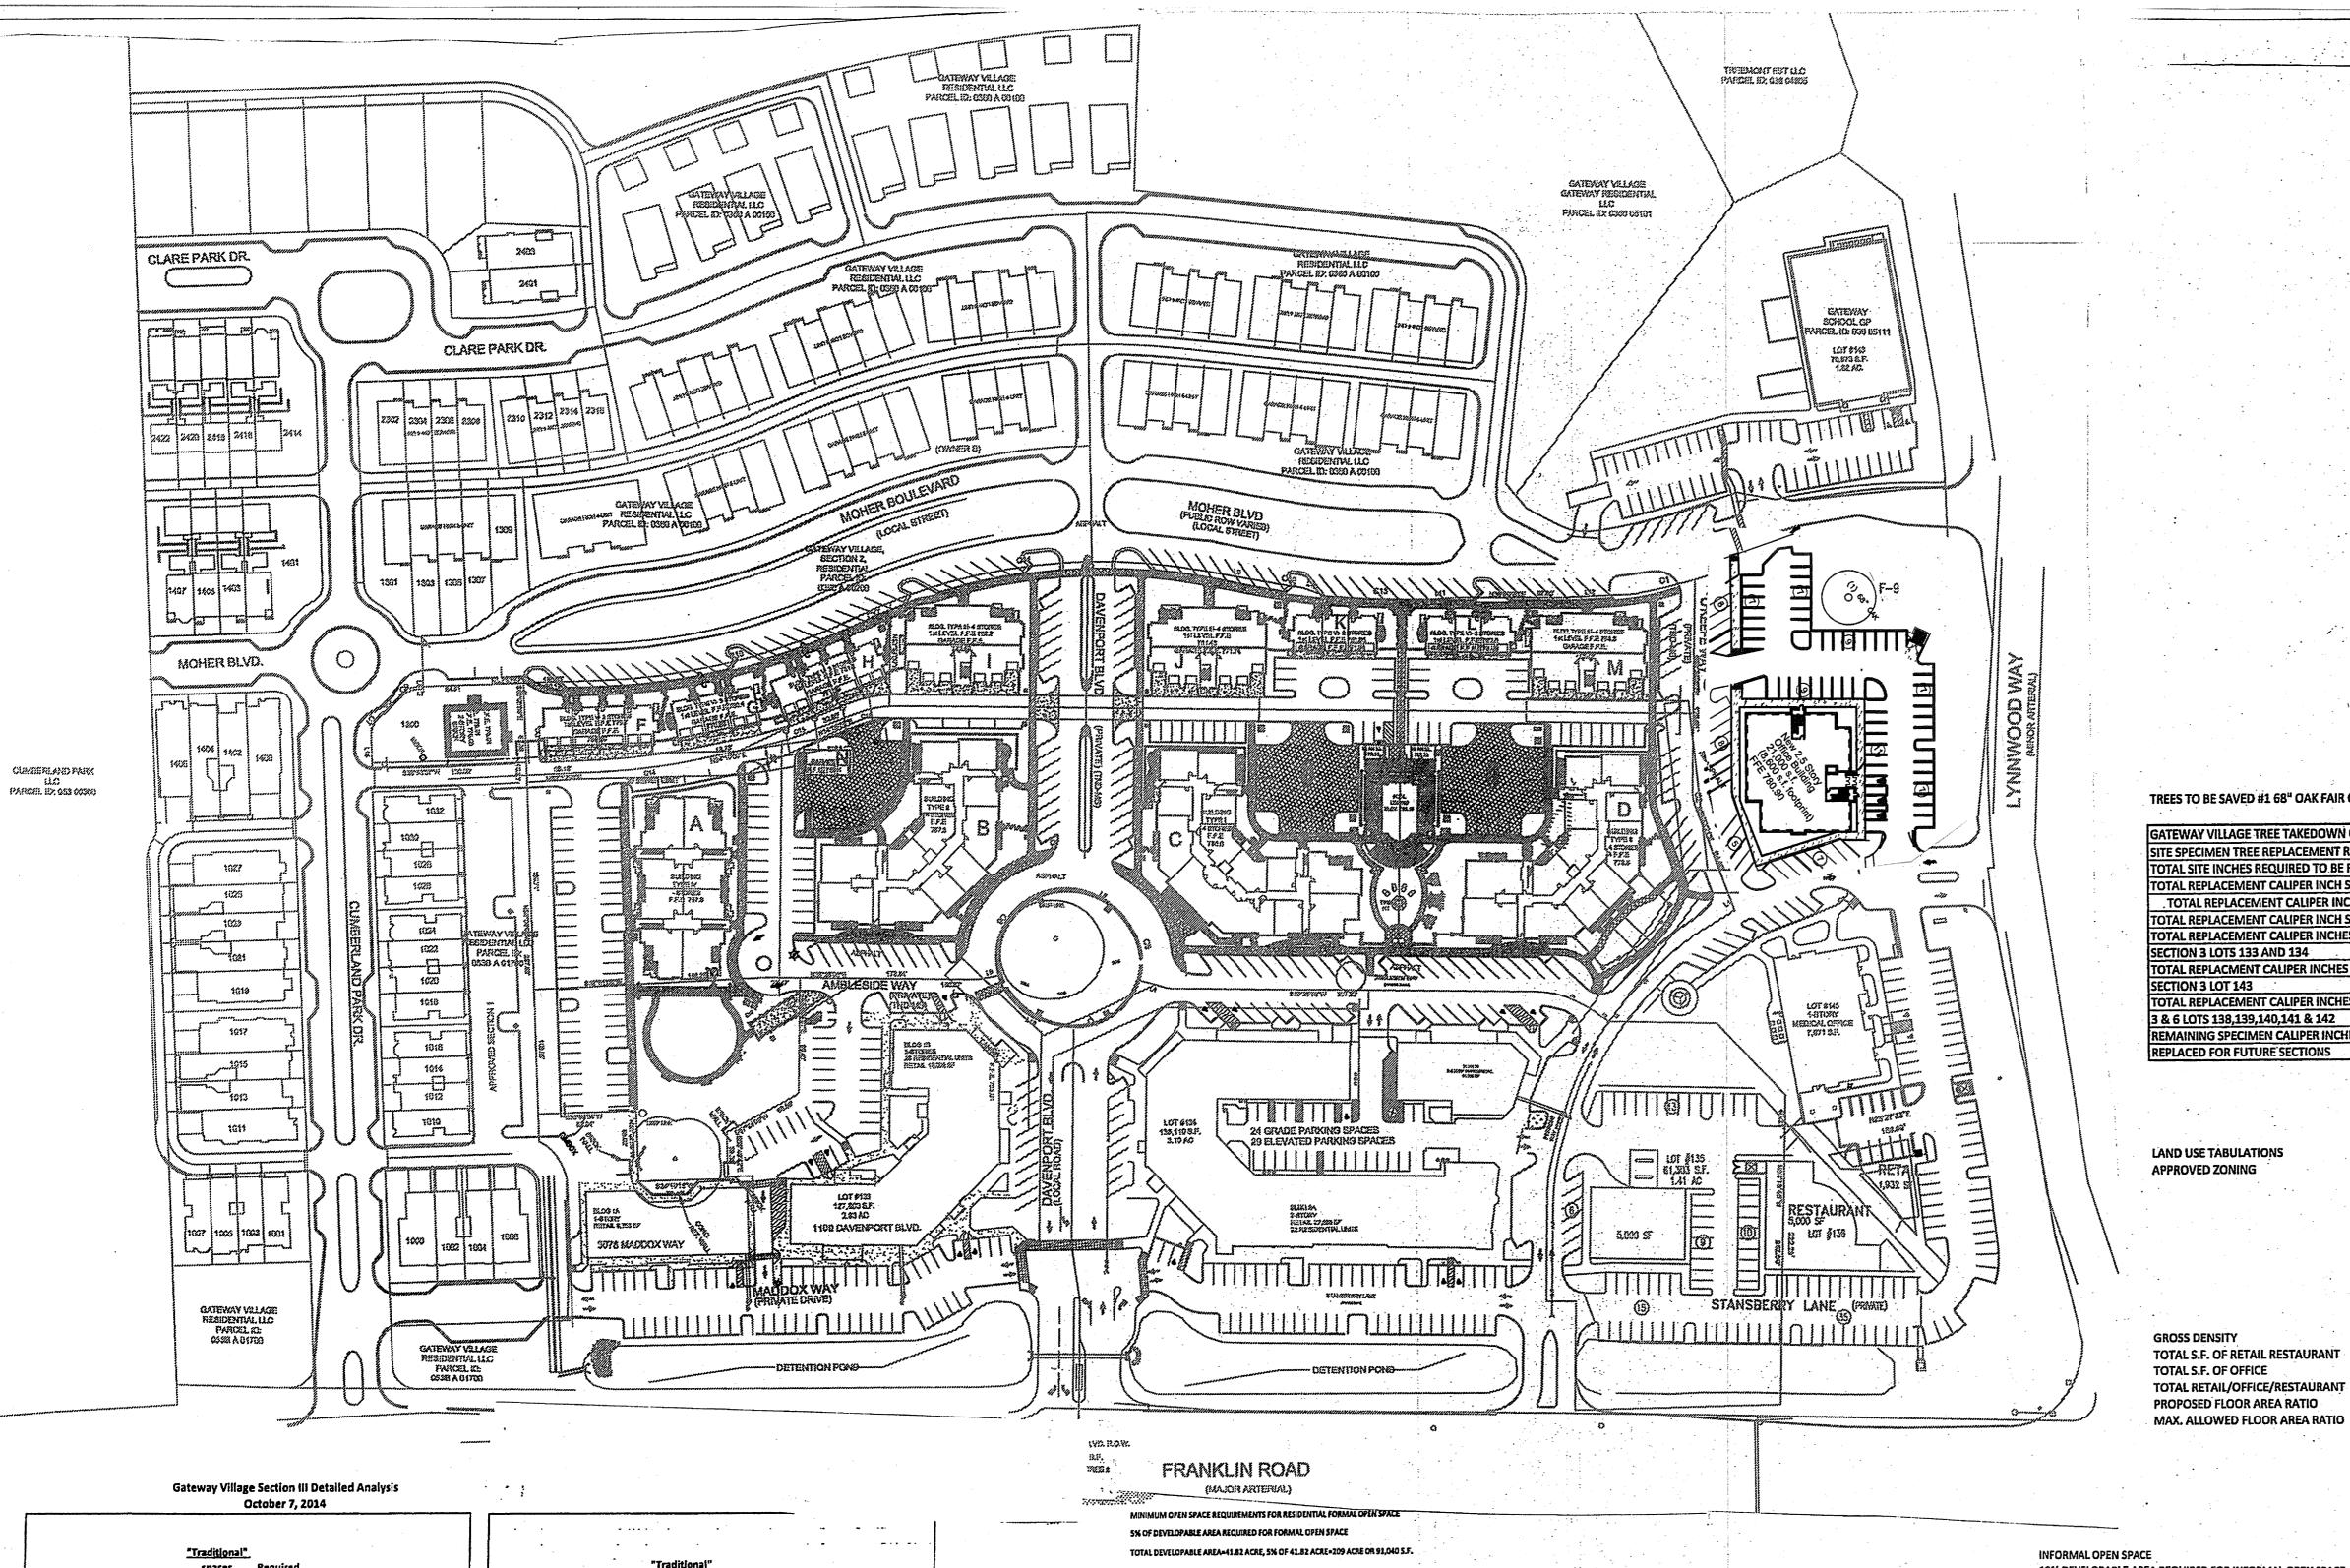
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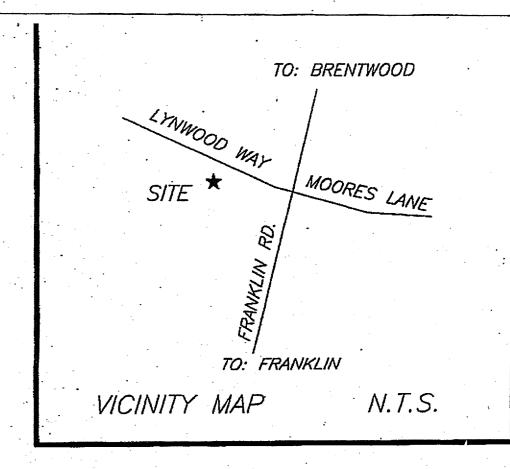
Date 01.05.15

Drawing Perspectives

A3







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LYNWOOD WAY LOT 137 GATEWAY VILLAGE SECTION 3 FRANKLIN, TENNESSEE


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SPECIAL NOTE:

THIS CONCEPT PLAN INFORMATION SHOWN WAS TAKEN FROM AVAILABLE PUBLIC INFORMATION PROVIDED BY THE CITY OF FRANKLIN. CDC LLC AND THIS ENGINEER ACCEPT NO LIABILITY AS THE EXACTNESS OF THE DEVELOPMENT OUTSIDE OF THE PROPOSED PLAN SHOWN.

TREES TO BE SAVED #1 68" OAK FAIR CONDITION, #2,48" ELM GOOD CONDITION, #3 40" ELM GOOD CONDITION


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DOWN CHART	
MENT REQUIRED	
TO BE REPLACED	1,341
R INCH SECTION 1	189
IPER INCH SECTION 2	354
R INCH SECTION 6	17.8
R INCHES	
	215
INCHES	
-	55
R INCHES SECTION	
§ 142	198
ER INCHES TO BE	
ONS	510
	MENT REQUIRED TO BE REPLACED R INCH SECTION 1 IPER INCH SECTION 2 R INCH SECTION 6 R INCHES INCHES R INCHES SECTION & 142 ER INCHES TO BE

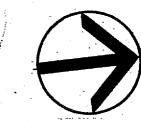


LAND USE TABULATIONS **APPROVED ZONING**

MIXED USE LOCAL (ML) +/- 60.50 ACRE **402 DWELLING UNITS** 15 DWELLING UNITS 113 DWELLING UNITS 6 DWELLING UNITS 214 DWELLING UNITS

(LOT 133-28, LOT 138, 186) 83,082 S.F. 61,176 S.F. 144,258 S.F.

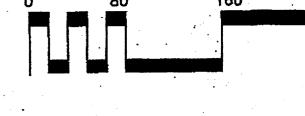

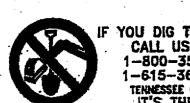

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		C	ctober 7, 2	014					
								* ***	
		"Traditional"							•
		spaces	Required					• ,	"Traditi
	# of Units	Required	Spaces		0.85	Actual			spac
Lot 133		-		•		•		# of Units	Requi
Camden Commons I	· - · ·	•	•			.	Lot 136	•	
Apartments				•			Apollo Burger		
Studio	2	1	. 2	•		٠ ١	sq. ft.	3894	
one bed	12	. 2	24				employees	11	
two bed	14	2.5	35				Seats	80	0.67
•	sq.ft.	•	•	•			sub total		
Restaurants		•	•				Lot 137		
Mack and Kates	3,077	7.5/1000	23		,		Touchstone Immag	ing (office)	
Employees	9		7		,	·	sq. ft.	21,000	2.85/1
Wall Street Pizza	2,612	7.5/1000	20				lots 138, 139, 141, 14	2	
Employees		• •	. s	•	•	· .	Bell Apartments	••••	
Sopapillas	4,387	7.5/1000	33	•	,		one bed	. 87 .	
Employees	25	•	19	•			two bed	77	2.5
Baxter & Co.		•	•	•	•		three bed	22	3´
Employees	10	•	10			.	sub total		
Stations	10	•	10	•			Small Park		
Lunatic Fring		•	_			- 1	Lot 140		
Employees	10		10			1	Lat 143		
Stations	10		10	·	·		Goddard School (d	aycare)	
True -I-Care	1,467	2.5/1000	3.67				Employees	30	1
RB's Cyclery	2,564	2.5/1000	6.41			j	sq.ft.	10,278	2/100
Xtend & Whitley	2,732	2.5/1000	7		•	1	Stacking.		. 5
Amish excellence	1,248	2.5/1000	3 .	•		1	sub total		
Applied from sec. I	(37)	•				1	Lot 145		
sub total			•	228.08	193.87	191	Camden Commons	Plaza (Oral :	Surgery)
. ,		•		•	•		sq. ft.	7885	
lot 134						ŀ	Employees	12	
Residential		•	•						
Studio	15	1	15	•	•	1	Total		
1 bed	25	2	50	•	•	- 1			
2 Bed	14	2.5	35	•	•				
sub total				*	• . • •	•••			
Iommercial	,		•		* * *	-			
Retail	15,861	3.33	52.82						
Restaurant	4,136	3.33 10	41.36			l			
	4,130		71,30	194.18	165.05	188			
sub total		**		134.10	103,03	100			
t 135 (Bank)						Į.			

		•••	• '		<u> </u>	•
-		"Traditional" spaces Required	Required Spaces	-	0.85	أورشه
Lot 136	# of Units	Kegunes	<u> </u>	* _ r	U.05	Actual
		,	•		• • •	
Apollo Burger sq. ft.	. 3894					
	. 5894 	·		• • •		
employees Seats	80	0.67	53.6			
	. 50	0.07	23.0			
sub total	· · ·			53.6	45.56	. 43
Lot 137		•••••				
Touchstone Immag		- 05/4000				52
sq. ft.	21,000	2.85/1000	60	60	. 51.00 .	, 3∠ .
lots 138, 139, 141, 142	!					*
Bell Apartments			474	-		,
one bed	. 87 .		. 174			•
two bed	. 77 	2.5	192.5		-	
three bed	22	5	-66		207 63	407
sub total.		-	•	432.5	367.63	467
Small Park		*			-1.00	
Lot 140					21.00	21
Lot 143						
Goddard School (da	-	_				
Employees	30	1	. 30			
sq.ft.	10,278	2/1000	. 21 .			
Stacking.		5				-
sub total		_		51	43.35	46
Lot 145						
Camden Commons	Piaza (Oral S	iurgery)	•			
sq. ft.	7885		·	- :		
Employees	12					
	• -		Actual	· , •	36.00	36

	# of Units	"Traditional" spaces Required	Required Spaces		0.85	Actual
Lot 136			•	·		
Apollo Burger			•			
sq. ft.	3894					
employees	11		0			
Seats	80	0.67	53.6	-		
sub total	•	'		53.6	45.56	43
Lot 137	• · ·					
Touchstone Immag	ing (office)					
sq. ft.	21,000	2.85/1000	60	60	51.00	52
iots 138, 139, 141, 142	2					_
Bell Apartments		•				
one bed	87	2	174	· .	•	
two bed	77	2.5	192.5			•
three bed	22		65		-	
sub total.		•	-	432.5	367.63	467
Small Park		•	•	•	-	
Lot 140	•				21.00	21
Lat 143					•	
Goddard School (da	aycare)		•	•		
Employees	30	1	30	• •	-	
sq. ft.	10,278	2/1000	21	•		
Stacking		5	•		-	
sub total	·			51	43.35	46
Lot 145		•		•		••
Camden Commons	Piaza (Oral S	urgery)	•	•		•
sq. ft.	7885		•	•		
Employees	12				•	
emberter.			Actual	. ,	36.00	36
Total	• •			1049.36	891.96	1089.0
· O(91						

Lot 136 Apollo Burger sq. ft. employees Seats sub total	3894 11			· - •		
sq. ft. employees Seats sub total	11				-	
employees Seats sub total	11					
Seats sub total						
sub total	80		0			
•		0.67	53.6			
• • • •				53.6	45.56	43
Lot 137	• • •					
Touchstone Immagi	ng (office)					
sq. ft.	21,000	2.85/1000	60	60	51.00	52
lots 138, 139, 141, 142						-
Bell Apartments					•	
one bed	87	2	174			
two bed	77	2.5	192.5		•	-
three bed	22	3	66		•	
sub total.		-		432.5	367.63	467
Small Park		•	-	•	•	
Lot 140	•		•	•	21.00	21
lat 143	•	-				
Goddard School (day	ycare) .		•			
Employees	30	1	30	•	•	_
sq. ft.	10,278	2/1000	21		•	
Stacking.		5	•	•		
sub total				51	43.35	46
ot 145		•		•		
Camden Commons F	Plaza (Oral S	urgery)	•	•		
sq. ft.	7885		•	•		1
Employees	12				•	
	• •		Actual		36.00	36
Total				1049.36	891.96	1089.00
						

		•			
		Required per			
Lots	-	"Traditional"	<u>85%</u>	<u>Actual</u>	
133	Camden Commons I	228.08	193.868	191	ı :.
134	Proposed CC II	194.18	165.053	188	
135	Bank	30	25.5	45	
136	Apollo Burger	53.6	45.56	43	:
137	Touchstone office Bldg.	60	51 _.	52	* :
143	Goddard School	51	43.35	46	
145	Camden Medical Plaza	36	30.6	36	:
140	formal open space	21	17.85	21	
138,	•				
139,					
141,					- :
142	Bell Apartments	432	367.2 _.	467	-
	Totals	1105.86	939.981	1089	

AREA F-4

AREA F-S

AREA F-6 LOT 135, 136

AREA F-9

AREA F-10

APPROVED AREA OF OPEN SPACE SF

9,996

6,624

11,623

42,171

14,908

12,073

8,659

19,528

16,076

7,852

12,701

152,211

SECTION 1 MEDIAN CIRCLE

SECTION 2 PARK

FOCAL POINT FOCAL POINT

TRAFFIC CIRCLE

PARK ·

PARK

PARK

PLAZA

2499

1656

11623

14716

2905

10527

3727

3018

4882

1953

3175

3.72 ACRES

4019

10% DEVELOPABLE AREA REQUIRED FOR INFORMAL OPEN SPACE TOTAL DEVELOPABLE AREA= 41.82 ACRE, 10% OF 41.82 ACRE=182,081 S.F.

	PAVED AREA	. AREA UF UPEN SPACE	ITE	CLASSIFICATION	VE1
•		1,017,610	HILLSIDE	INFORMAL	AREA I-1
	•	•			
		VILLAGE LAND USE DATA	RRENTLY APPROVED GATEWAY	CU	
MIXED USE PARKING	RETAIL OFFICE S.F.	TOTAL DWELLING UNITS	PC ZONED ACRE	FMPC APPROVAL DATE	DEVELOPMENT
.85 MULTIPLIER	142,258	419	60.5	. 6/3/2003	CONCEPT PLAN
.85 MULTIPLIER	144,258	402	60.5	5/22/2008	CONCEPT PLAN REV. 3
	*	33	4.83	8/8/2004	SECTION 1
		95	11.42	3/24/2005	SECTION 2
		39	1.12	7/27/2008	SECTION 6
7		. 6	0.18	9/23/2010	SECTION 6 LOT 141 (REV 6)
•					APPROVED SECTION 3
154	22,851	28	2.93	9/27/2007	LOT 133
46	10,276	<u> - </u>	1.92	11/20/2008	LOT143
368	N/A (6,500 S.F. LEASING)	186	7.74	9/23/2010	SECTION 3 LOTS 138, 140, 144
575	33,127	348			TOTAL

NOTE ONLY LOTS 133 AND 143 WERE DEVELOPED FROM 9/27/2007 APPROVAL THE SITE PLAN HAS EXPIRED FOR LOTS 134 AND 514



CIVIL DESIGN CONSULTANTS, LLC



HMH Job Number 14035 Drawn By HMH

Date **07.28.14**

PROP. CONCEPT AND PARKING PLAN