GATEWAY VILLAGE PUD SUBDIVISION DEVELOPMENT PLAN, SECTION 4




1607 Westgate Circle - Suite 100 Brentwood, Tennessee 37027 615.370.3252

FICE BUILDING FOR


Touchstone Medical Imaging


LYNWOOD WA LOT 137 GATEWA VILLAGE SECTION FRANKLIN. TENNESSE

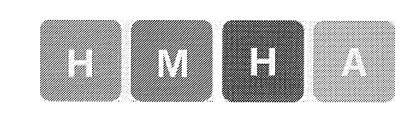

H. Michael Hindman Architects, P.C.

1607 Westgate Circle - Suite 100 Brentwood, Tennessee 37027 615.370.3250 www.hmharchitects.com

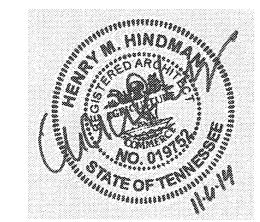


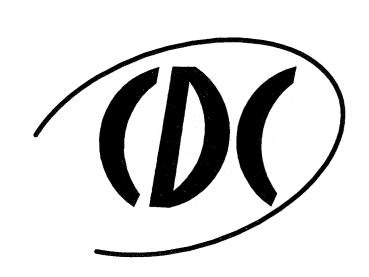

CIVIL DESIGN CONSULTANTS, LLC
CIVIL ENGINEERS - LAND PLANNERS
CIVIL-DESIGN-CONSULTANTS, LLC

8170 COLEY DAVIS RD., NASHVILLE, TN. 37221
PHONE: (615) 319-2734 EMAIL: CIVILCONSULTANTS@BELLSOUTH.NET



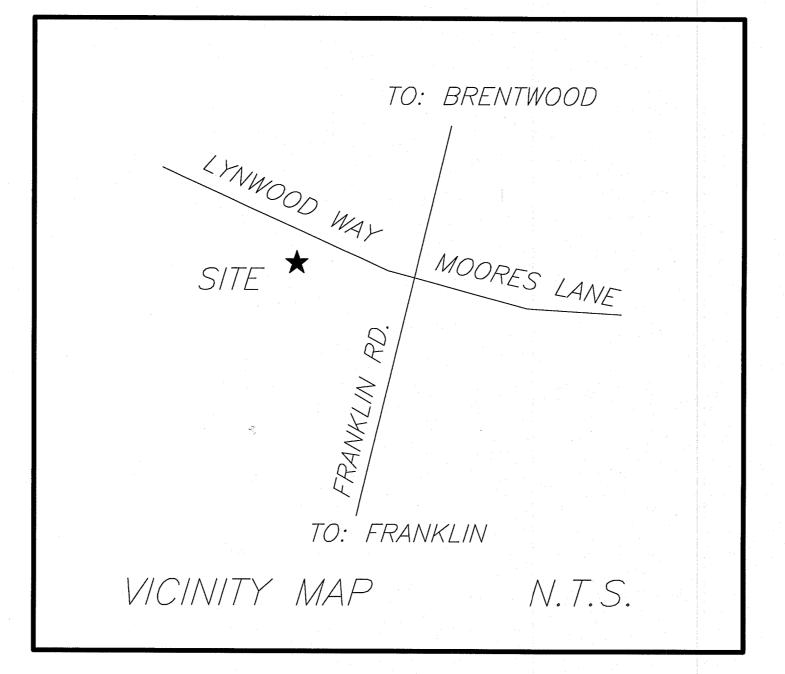





1360 MOHER BLVD
CITY OF FRANKLIN PROJECT NUMBER 4693

CITY OF FRANKLIN, WILLIAMSON COUNTY, TENNESSEE

PLAN SHEET INDEX

SHEET	DESCRIPTION
CS	COVER SHEET
ECP	EXISTING CONCEPT PLAN
PCP	PROPOSED CONCEPT PLAN AS APPROVE
PCP	PROPOSED CONCEPT PLAN AS BUILT
C0.0	EXISITNG CONDITIONS PLAN
C1.0	PROPOSED LAYOUT PLAN
C2.0	PROPOSED GRADING DRAINAGE PLAN
C3.0	STORMWATER PLAN
L1.0	LANDSCAPE PLAN
L1.1	LANDSCAPE PLAN
A 1	ARCHITECTURE PLAN
A2	ARCHITECTURE PLAN
A3	ARCHITECTURE PLAN
A4	ARCHITECTURE PLAN

SITE DATA:	
SUBDIVISION/DEVELOPMENT:	RSC GENERAL PARTNERSHIP
ADDRESS:	1360 MOHER BLVD.
CITY:	FRANKLIN
COUNTY:	WILLIAMSON
STATE:	TENNESSEE
PARCEL\MAP:	PARCEL 49 MAP 064B GROUP B
ACREAGE OF SITE:	1.45± ACRES
SQUARE FOOTAGE OF SITE:	63,245± S.F.
DISTURBED ACREAGE:	1.20± ACRES
CIVIL DISTRICT:	8
CHARACTER AREA	BCCO BARRYS CHAPEL CHARACTER DEVELOPMENT AREA OVERLAY
DEVELOPMENT STANDARD	TRADITIONAL
EXISTING USE	VACANT
PROPOSED USE	OFFICE
ZONING DISTRICT	GENERAL COMMERCIAL
APPLICANT: ARCHITECT MR. MICHAEL HINDMAN, A H. MICHAEL HINDMAN AR 1607 WESTGATE CIRCLE, BRENTWOOD, TN 37027 (615) 370-3252	CHITECTS, PC.
FNONEED	

1894 GENERAL GEORGE PATTON DR. FRANKLIN, TN 37067 (615) 376-2421

COF #4693

BUILDING SQUARE FOOTAGE: 21,000 S.F. (MEDICAL OFFICE)
PARKING REQUIRED: 1 SPACE/250 S.F.= 84 SPACES
PARKING PROVIDED: 86 SPACES


ALL 90° PARKING SHALL BE 9'X18' UNLESS OTHERWISE NOTED


HMH Job Number 14035


> HMH Date 07.28.14

Drawn By

COVER SHEET

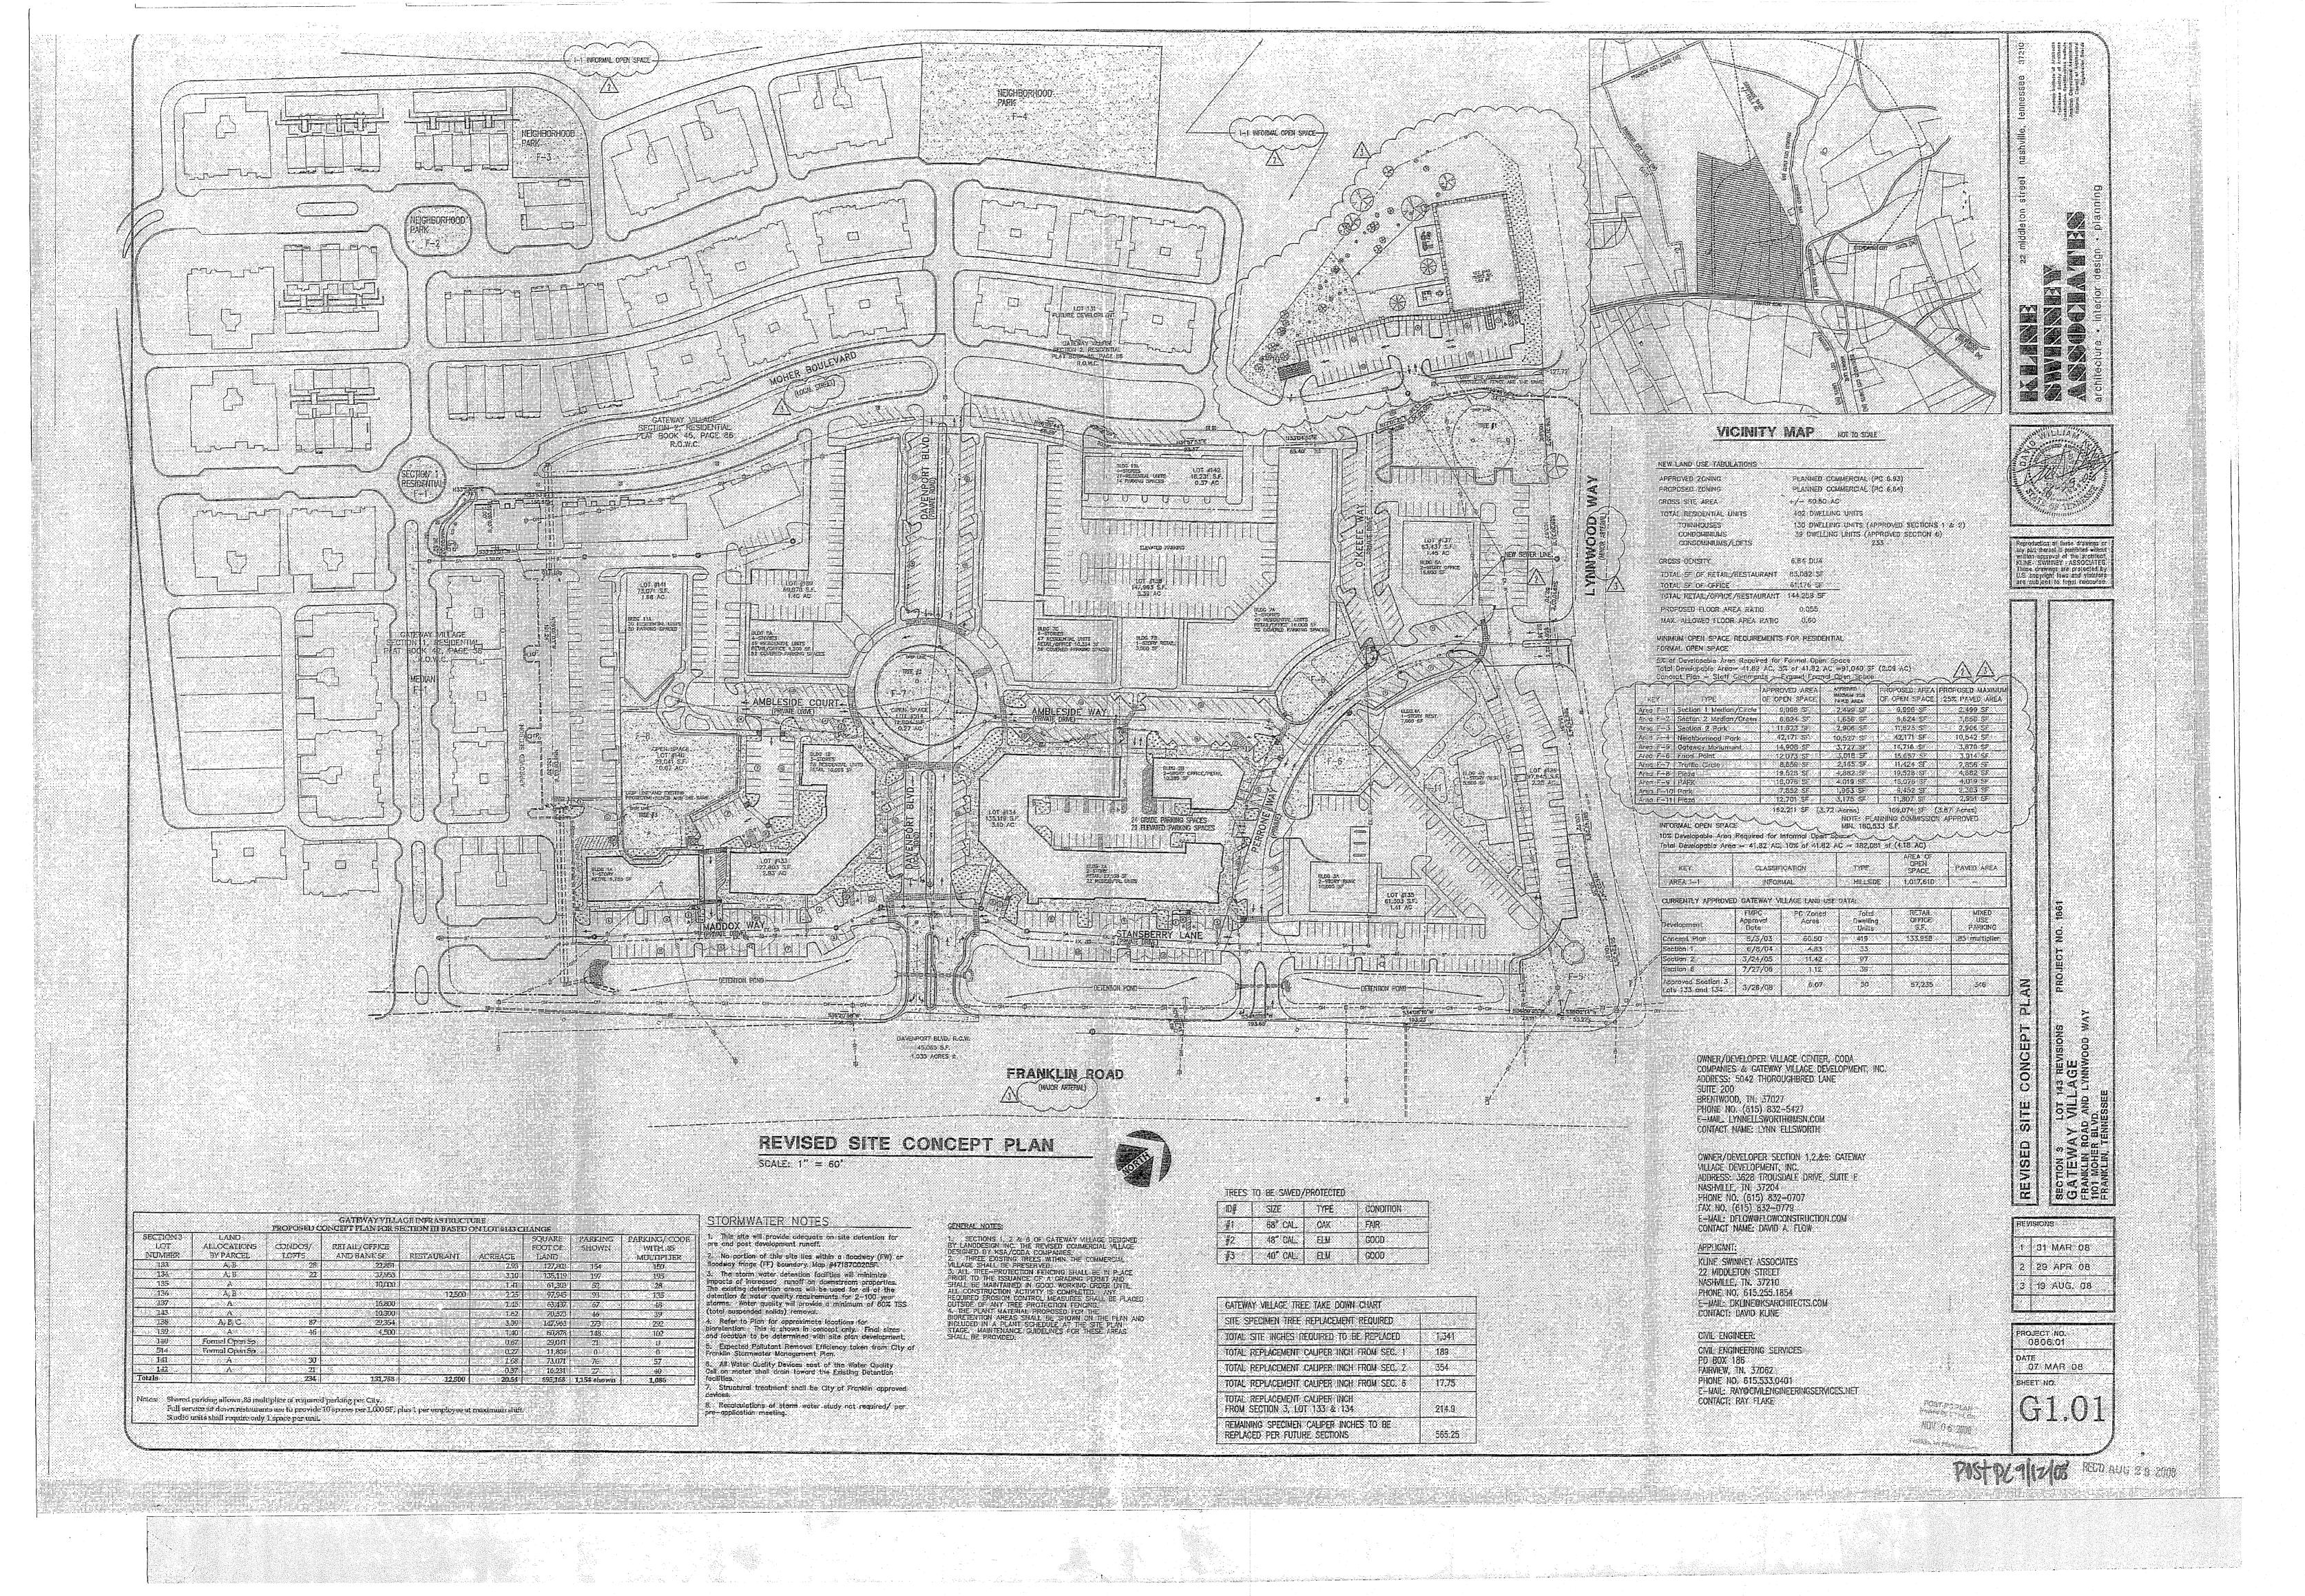

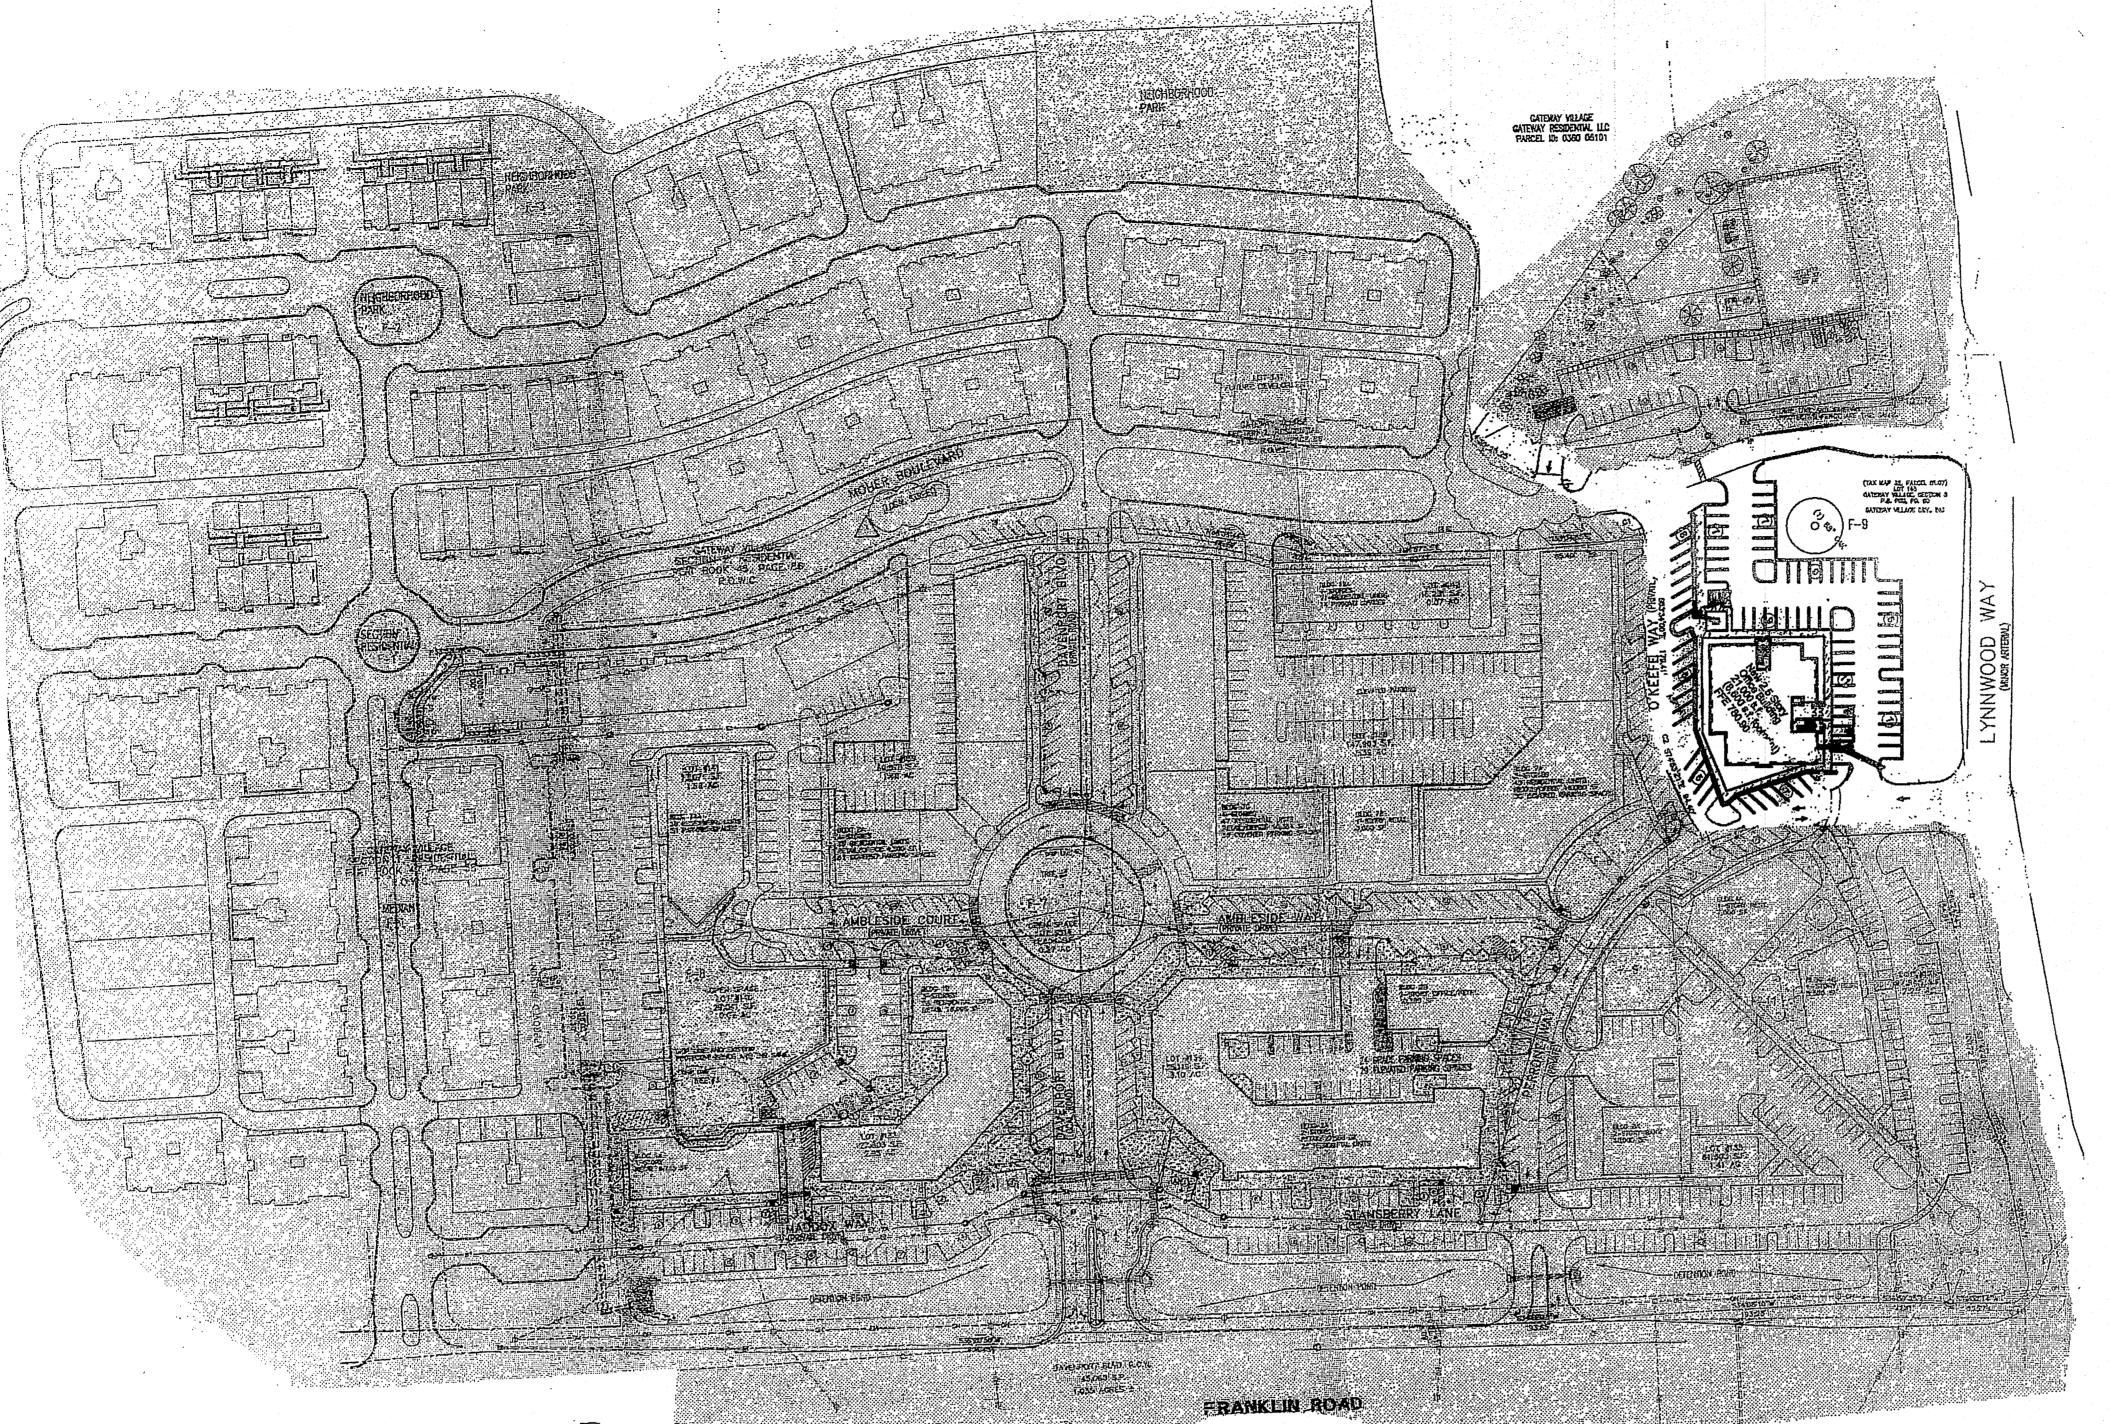

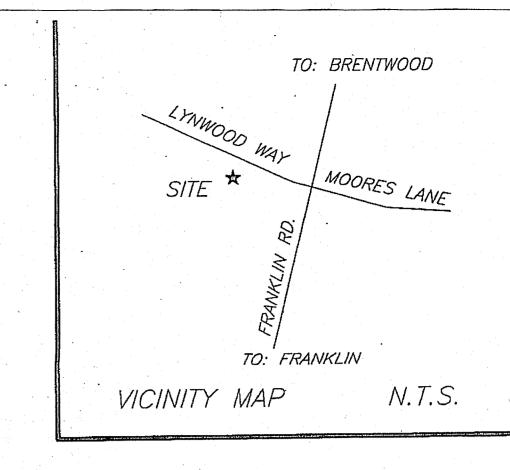

SPECIAL NOTE:

THIS CONCEPT PLAN INFORMATION SHOWN WAS TAKEN FROM AVAILABLE PUBLIC INFORMATION PROVIDED BY THE CITY OF FRANKLIN. CDC LLC AND THIS ENGINEER ACCEPT NO LIABILITY AS THE EXACTNESS OF THE DEVELOPMENT OUTSIDE OF THE PROPOSED PLAN SHOWN.

TREES TO BE SAVED #1 68" OAK FAIR CONDITION, #2,48" ELM GOOD CONDITION, #3 40" ELM GOOD CONDITION

GATEWAY VILLAGE TREE TAKEDOWN CHART	
SITE SPECIMEN TREE REPLACEMENT REQUIRED	
TOTAL SITE INCHES REQUIRED TO BE REPLACED	1,34
TOTAL REPLACEMENT CALIPER INCH SECTION 1	18
TOTAL REPLACEMENT CALIPER INCH SECTION 2	35
TOTAL REPLACEMENT CALIPER INCH SECTION 6	17
TOTAL REPLACEMENT CALIPER INCHES	1
SECTION 3 LOTS 133 AND 134	2:
TOTAL REPLACMENT CALIPER INCHES	
SECTION 3 LOT 143	!
TOTAL REPLACEMENT CALIPER INCHES SECTION	1
3 & 6 LOTS 138,139,140,141 & 142	1
REMAINING SPECIMEN CALIPER INCHES TO BE	
REPLACED FOR FUTURE SECTIONS	5

LAND USE TABULATIONS

APPROVED ZONING

MIXED USE LOCAL (ML) MIXED USE LOCAL (ML) +/- 60.50 ACRE **402 DWELLING UNITS** 15 DWELLING UNITS 113 DWELLING UNITS **6 DWELLING UNITS** 214 DWELLING UNITS (LOT 133-28, LOT 138, 186)

GROSS DENSITY TOTAL S.F. OF RETAIL RESTAURANT TOTAL S.F. OF OFFICE TOTAL RETAIL/OFFICE/RESTAURANT

PROPOSED FLOOR AREA RATIO

MAX. ALLOWED FLOOR AREA RATIO

6.64 DUA 83,082 S.F. 61,176 S.F. 144,258 S.F. 0,055

0.6



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1-615-366-1987
TENNESSEE ONE CALL
IT'S THE LAW

Gateway Village Section III Detailed Analysis

	October 7, 2014								
	# of Units	"Traditional" spaces Required	<u>Required</u> <u>Spaces</u>		0.85	<u>Actual</u>			
Lot 133	,		•	_					
Camden Commons	1		•						
Apartments									
Studio	2	1	2						
one bed	12	2	24						
two bed	14	2.5	35						
	sq. ft.								
Restaurants									
Mack and Kates	3,077	7.5/1000	23						
Employees	9		. 7						
Wall Street Pizza	2,612	7.5/1000	. 20						
Employees	6		5			-			
Sopapillas	4,387	7.5/1000	33						
Employees	25		19						
Baxter & Co.		•							
Employees	10		10						
Stations	10		10						
Lunatic Fring									
Employees	10		10						
Stations	10		10	•					
True -1-Care	1,467	2.5/1000	3.67						
RB's Cyclery	2,564	2.5/1000	6.41						
Xtend & Whitley		2.5/1000	7	,					
Amish excellence	*	2.5/1000	3	•					
Applied from sec. 1	(37)								
sub total		•		228.08	193.87	191			
Lot 134									
Residential			•						
Studio	15	1	15	•					
1 bed	25	. 2							
2 Bed	14	2.5	•	•					
sub total									

sub total Lot 135 (Bank)

				<u>-</u>		
		"Traditional"	_			
		spaces	Required			
	# of Units	Required	Spaces	_	0.85	<u>Actual</u>
Lot 136	*					
Apollo Burger	•					
sq. ft.	3894					
employees	11		0			
Seats	80	0.67	53.6			
sub total				53.6	45.56	43
Lot 137	•				•	
Touchstone Immag	ing (office)		;			
sq. ft.	21,000	2.85/1000	60	60	51.00	52
lots 138, 139, 141, 142	2					
Bell Apartments						
one bed	87	2	174		:	
two bed	. 77 ·	2.5	192.5			
three bed	22	3	66			
sub total	• . • • •	**		432.5	367.63	467
Small Park			•	•		
Lot 140			•	•	21.00	21
ot 143			•	•		
Goddard School (da	avcare)	-		•		
Employees	30	1	30	•		
sq. ft.	10,278	2/1000	. 21	•	•	•
Stacking	20,2.0	5	•: •	•		
sub total				51	43.35	46
Lot 145						••
Camden Commons	Piaza (Oral 9	Surgery)			·	
sq. ft.	7885			• • • •		
Employees	12	•	• •		•	
Linbioleca			Actual	• •	36.00	36
Total				1049.36	891.96	1089.00

MINIMUM OPEN SPACE REQUIREMENTS FOR RESIDENTIAL FORMAL OPEN SPACE 5% OF DEVELOPABLE AREA REQUIRED FOR FORMAL OPEN SPACE TOTAL DEVELOPABLE AREA=41.82 ACRE, 5% OF 41.82 ACRE=209 ACRE OR 91,040 S.F. CONCEPT PLAN-STAFF COMMENTS- EXPAND FORMAL OPEN SPACE

			oski <u>si dharatera e e e</u>		
KEY	TYPE	APPROVED AREA OF OPEN SPACE SF	APPROVED MAXIMUM PAVED AREA SF	PROPOSED OPEN SPACE AREA	PROPOSED MAXIMUM PAVED AREA S.F.
AREA F-1	SECTION 1 MEDIAN CIRCLE	9,996	2499	9996	2499
		6,624	1656	6624	1656
AREA F-2	SECTION 2 MEDIAN/GREEN	11,623	2906	11623	. 2906
AREA F-3	SECTION 2 PARK	3	10527	42171	10542
AREA F-4	NEIGHBORHOOD PARK	42,171	3727	14716	3679
AREA F-5	GATEWAY MONUMENT	14,908	3018	6838	1709
AREA F-6 LOT 135, 136	FOCAL POINT	12,073		8819	2205
AREA F-6, LOT 138	FOCAL POINT	9,550	2165	11424	2856
AREA F-7	TRAFFIC CIRCLE	8,659	4882	19528	4882
AREA F-8	PARK	19,528	4019	16076	4019
AREA F-9	PARK	16,076		9452	2363
AREA F-10	PARK	7,852	1963	11807	2951
AREA F-11	PLAZA	12,701	3175	159 074 S.F.	3.87 ACRES

	49			
		Required per		
Lots		"Traditional"	85%	<u>Actual</u>
133	Camden Commons I	228.08	193.868	191
134	Proposed CC II	194.18	165.053	188
135	Bank	30	25.5	45
136	Apollo Burger	53.6	45.56	43
137	Touchstone office Bldg.	60	51	52
143	Goddard School	51	43.35	46
145	Camden Medical Plaza	36	30.6	36
140	formal open space	21	17.85	21
138,	Torritor open spass			1
139,				
141,				
141,	Bell Apartments	432	367.2	467
142	Totals	1105.86	939.981	1089

INFORMAL OPEN SPACE 10% DEVELOPABLE AREA REQUIRED FOR INFORMAL OPEN SPACE

	TOTAL DEVELOPABLE AREA= 41.82 AC	RE, 10% OF 41.82 ACRE=182,08	31 S.F.			
	KEY	CLASSIFICATION	TYPE	AREA OF OPEN SPACE	PAVED AREA	
Ì	AREA I-1	INFORMAL	HILLSIDE	1,017,610		
			-	- 1 -		
		CU	RRENTLY APPROVED GATEWA	VILLAGE LAND USE DATA		
	DEVELOPMENT	FMPC APPROVAL DATE	PC ZONED ACRE	TOTAL DWELLING UNITS	RETAIL OFFICE S.F.	MIXED USE PARKING
	CONCEPT PLAN	. 6/3/2003	60.5	419	142,258	.85 MULTIPLIER
ı	CONCEPT PLAN REV. 3	5/22/2008	60.5	402	144,258	.85 MULTIPLIER
1	SECTION 1	8/8/2004	4.83	33		
	SECTION 2	3/24/2005	11.42	95		
1	SECTION 6	7/27/2006	1.12	39		
	SECTION 6 LOT 141 (REV 6)	9/23/2010	0.18	6		7
Ì	APPROVED SECTION 3				<u></u>	
	LOT 133	9/27/2007	2.93	28	22,851	154
	LOT143	11/20/2008	1.92		10,276	46
-	SECTION 3 LOTS 138, 140, 144	9/23/2010	7.74	186	N/A (6,500 S.F. LEASING)	368
	TOTAL			348	33,127	575

NOTE ONLY LOTS 133 AND 143 WERE DEVELOPED FROM 9/27/2007 APPROVAL THE SITE PLAN HAS EXPIRED FOR LOTS 134 AND 514




H. Michael Hindman Architects, P.C.

OFFICE BUILDING FOR

Touchstone Medical Imaging


LYNWOOD WAY LOT 137 GATEWAY VILLAGE SECTION 3 FRANKLIN, TENNESSEE

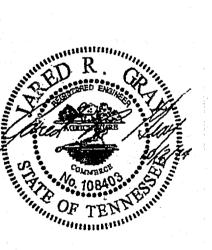


Drawn By

07.28.14 Drawing

PROP. CONCEPT AND PARKING PLAN

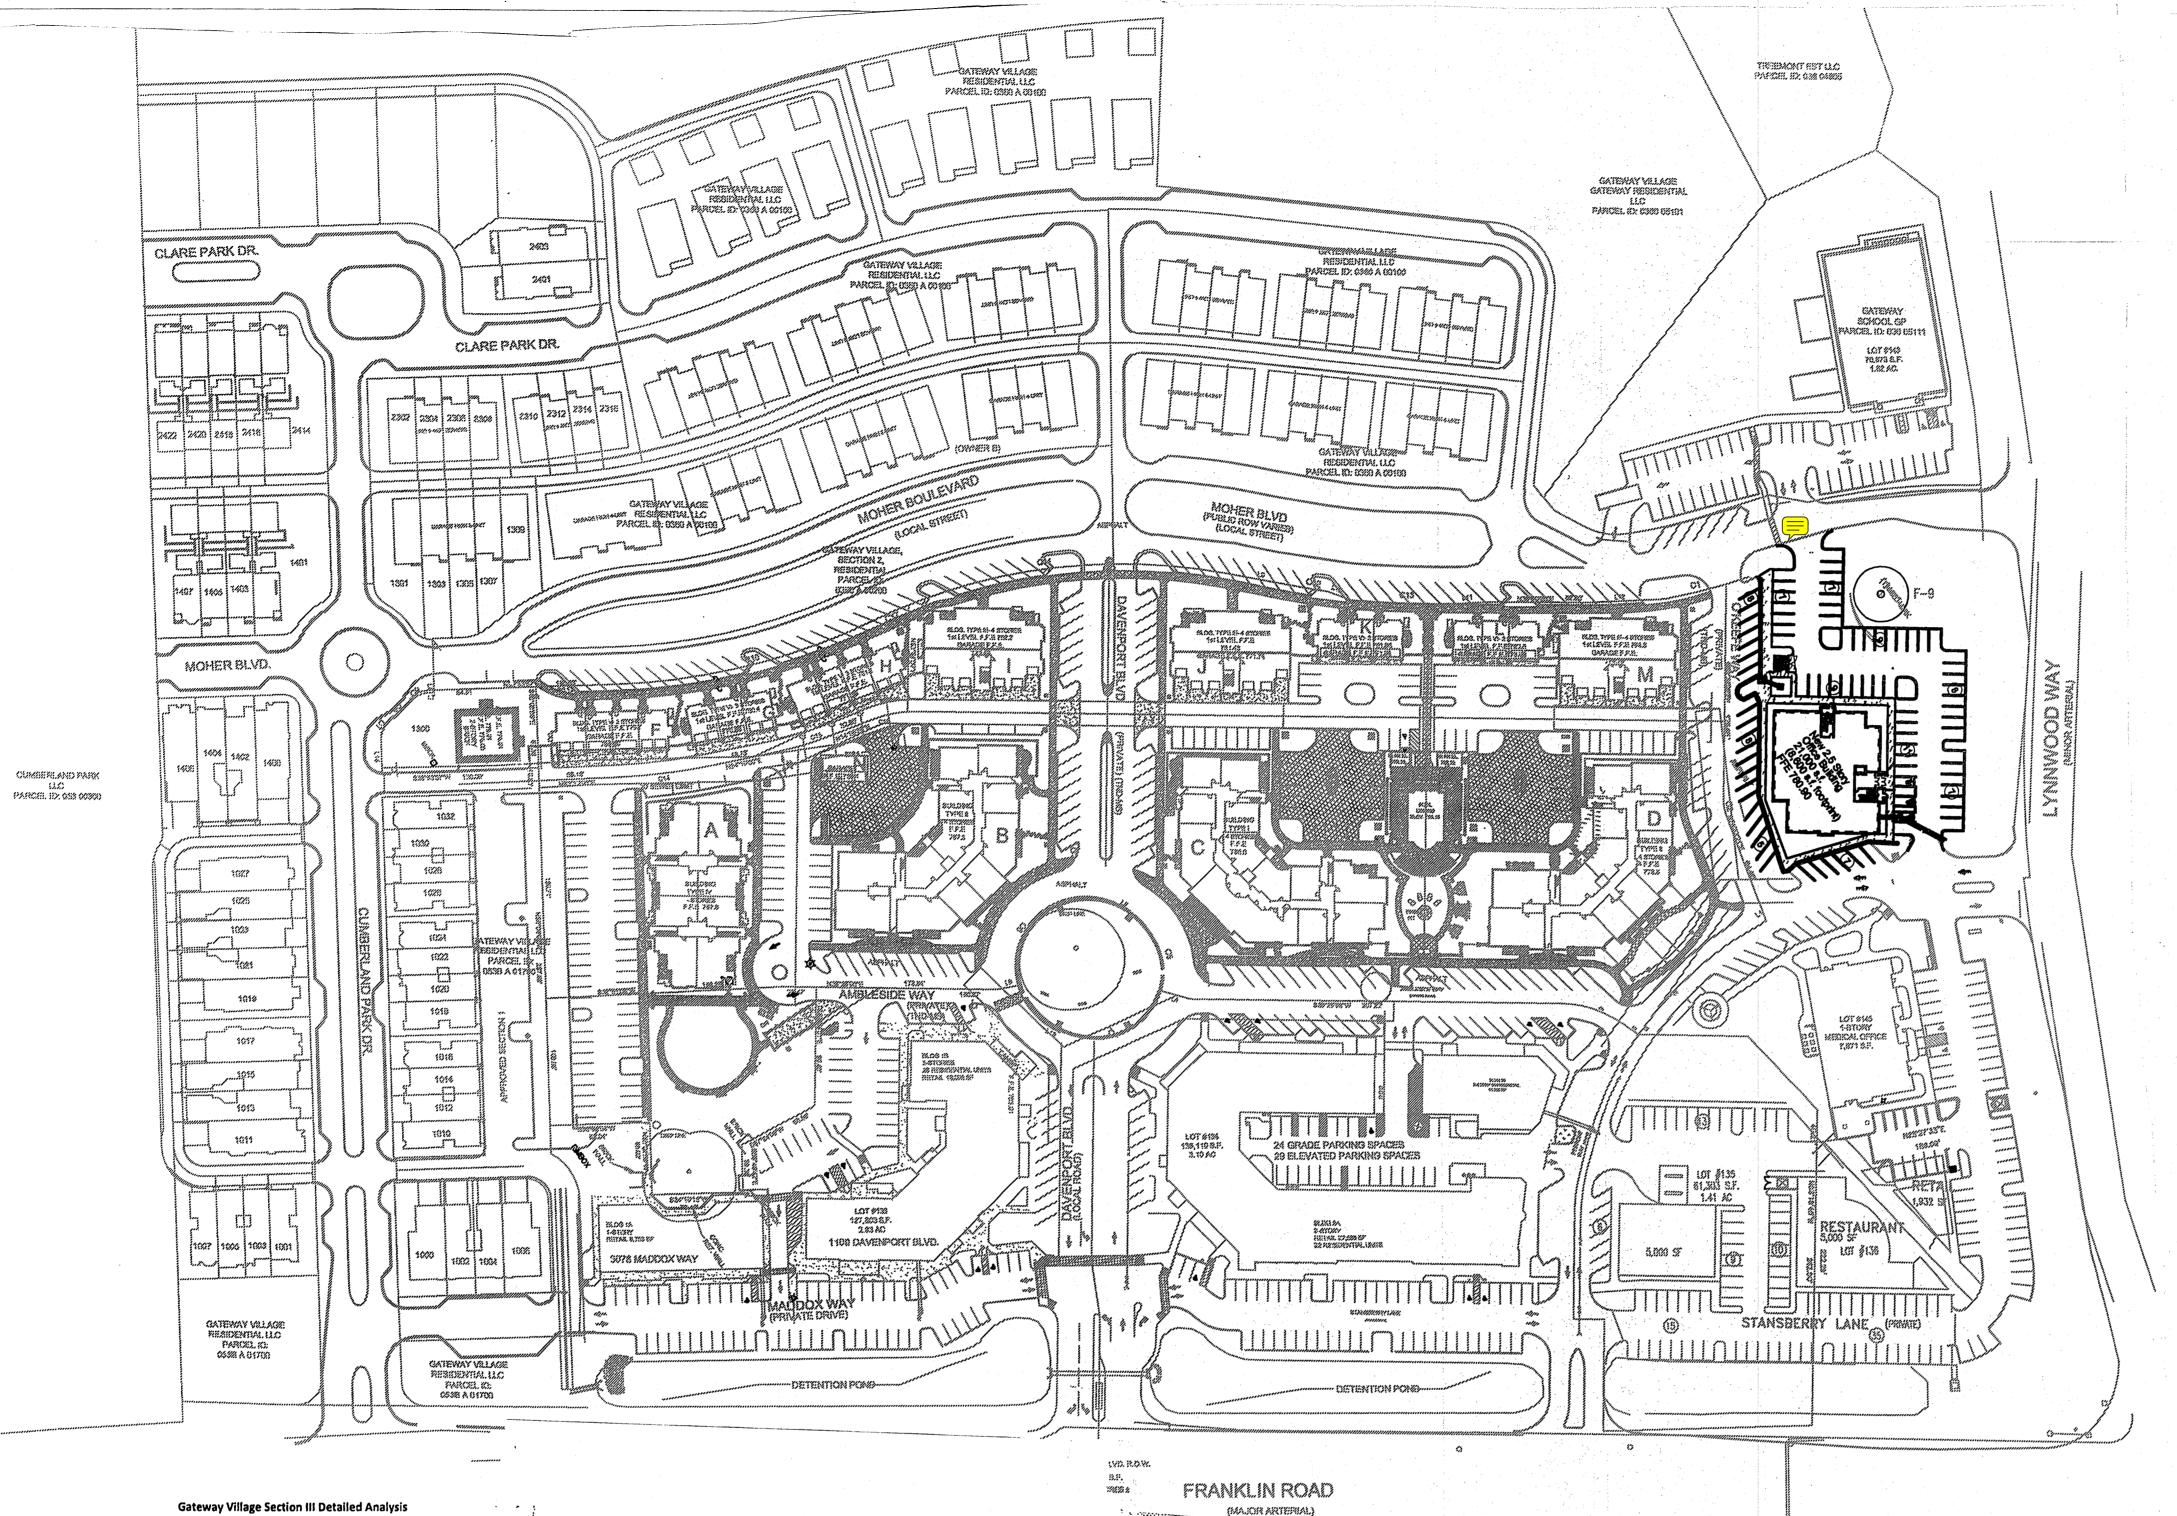

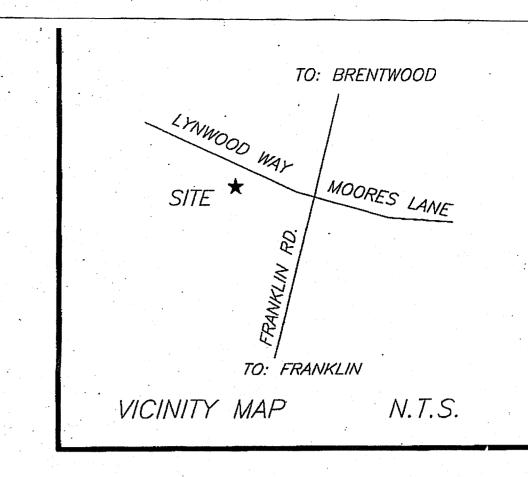


SPECIAL NOTE:

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TREES TO BE SAVED #1 68" OAK FAIR CONDITION, #2,48" ELM GOOD CONDITION, #3 40" ELM GOOD CONDITION

GATEWAY VILLAGE TREE TAKEDOWN CHART	
SITE SPECIMEN TREE REPLACEMENT REQUIRED	
TOTAL SITE INCHES REQUIRED TO BE REPLACED	1,34
TOTAL REPLACEMENT CALIPER INCH SECTION 1	18
TOTAL REPLACEMENT CALIPER INCH SECTION 2	35
TOTAL REPLACEMENT CALIPER INCH SECTION 6	17.
TOTAL REPLACEMENT CALIPER INCHES	
SECTION 3 LOTS 133 AND 134	21
TOTAL REPLACMENT CALIPER INCHES	
SECTION 3 LOT 143	5
TOTAL REPLACEMENT CALIPER INCHES SECTION	-
3 & 6 LOTS 138,139,140,141 & 142	19
REMAINING SPECIMEN CALIPER INCHES TO BE	
REPLACED FOR FUTURE SECTIONS	51

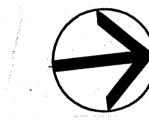

LAND USE TABULATIONS APPROVED ZONING

MIXED USE LOCAL (ML) MIXED USE LOCAL (ML) +/- 60.50 ACRE **402 DWELLING UNITS** 15 DWELLING UNITS 113 DWELLING UNITS **6 DWELLING UNITS**

GROSS DENSITY TOTAL S.F. OF RETAIL RESTAURANT TOTAL S.F. OF OFFICE TOTAL RETAIL/OFFICE/RESTAURANT PROPOSED FLOOR AREA RATIO

214 DWELLING UNITS (LOT 133-28, LOT 138, 186) **6.64 D**UA 83,082 S.F. 61,176 S.F. 144,258 S.F.

0,055





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1-615-366-1987

TENNESSEE ONE CALL

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the same that th

Gateway Village Section III Detailed Analysis

October 7, 2014									
	# of Units	"Traditional" spaces Required	Required Spaces		0.85	<u>Actual</u>			
Lot 133	•								
Camden Commons I Apartments	1			:					
Studio	2	1	2	•		•			
one bed	12	. 2	24						
two bed	14	2.5	35			•			
•	sq. ft.			·					
Restaurants			•			•			
Mack and Kates	3,077	7.5/1000	23			•			
Employees	9		7	Α		'			
Wall Street Pizza	2,612	7.5/1000	20						
Employees	6		j. 5			-			
Sopapillas	4,387	7.5/1000	33						
Employees	25		19						
Baxter & Co.									
Employees	10		10			*			
Stations	10		10						
Lunatic Fring									
Employees	10		10						
Stations	10		10						
True -I-Care		2.5/1000	3.67						
RB's Cyclery		2.5/1000	6.41						
Xtend & Whitley		2.5/1000	. 7						
Amish excellence	1,248	2.5/1000	3	•					
Applied from sec. I	(37)								
sub total				228.08	193.87	191			
ot 134									
Residential									
Studio	15	1	15			j			
1 bed	25	2	50						
2 Bed	14	2.5	35		,				
sub total				• • • •					
Commercial				•	* '				
Retail	15,861	3.33	52.82	•					

• . .

sub total Lot 135 (Bank) sq. ft.

		•	•			
					-	
	• .	"Traditional"	_			
		spaces	Required			
	# of Units	Required	Spaces	,	0.85	<u>Actual</u>
Lot 136	•					
Apollo Burger				-		
sq. ft.	3894				•	••
employees	11		0			
Seats	80	0.67	53.6			
sub total				53.6	45.56	43
Lot 137						
Touchstone Immag	ing (office)					
sq. ft.	21,000	2.85/1000	60	60	51.00	52
lots 138, 139, 141, 14		2.03/ 1000			32.00	 .
Bell Apartments			• • •			
one bed	87		174	-	:	
two bed		2.5	192.5			
three bed	. 77 22	3	66	· · - ·		
sub total	. "	. •		432.5	367.63	467
Small Park	• •		•	432.3	307.03	407
Lot 140				•	21.00	21
Lot 140 Lot 143					21.00	21
Goddard School (da	aycare) 30					
Employees		1	30			
sq. ft.	10,278	2/1000	21 .			
Stacking		5.				
sub total				51	43.35	46
Lot 145				·		
Camden Commons		urgery)				
sq. ft.	7885					
Employees	12					
v. v			Actual		36.00	36
Total				1049.36	891.96	1089.00

		•	•			
		"Traditional"	-			
		spaces	Required			
	# of Units	Required	Spaces		0.85	<u>Actual</u>
Lot 136	·					
Apollo Burger						٠
sq. ft.	3894	,				
employees	11		0		·	
Seats	. 80	0.67	53.6			.
sub total				53.6	45.56	43
Lot 137						
Touchstone Immag	ging (office)					
sq. ft.	21,000	2.85/1000	60	60	51.00	52
lots 138, 139, 141, 14	2				•	
Bell Apartments						
one bed	87	2	174		:	
two bed	77	2.5	192.5	·•	•	•
three bed	22	3 .	66			
sub total	• • • • • • •			432.5	367.63	467
Small Park				•	•	
Lot 140				•	21.00	21
lot 143				. •	••	
Goddard School (d	aycare)	•		•	•	
Employees	30	1	30			
sq. ft.	10,278	2/1000	21	•		
Stacking	/	5			•	
sub total		٠.		51	43.35	46
ot 145			•	- ·	75.55	70
Camden Commons	Plaza (Oral C	urrecul		•		. 1
sq. ft.	7885	m.že.Al		• • • •		1
Employees	12					İ
rmpioyees			Actual	. ,	36.00	36
			Actual	1040 25		
otal				1049.36	891.96	1089.00

KEY	TYPE	APPROVED AREA OF OPEN SPACE SF	APPROVED MAXIMUM PAVED AREA SF	PROPOSED OPEN SPACE AREA	PROPOSED MAXIMUM PAVED AREA S.F.
AREA F-1	SECTION 1 MEDIAN CIRCLE	9,996	2499	9996	2499
AREA F-2	SECTION 2 MEDIAN/GREEN	6,624	1656	6624	1656
AREA F-3	SECTION 2 PARK	11,623	2906	11623	2906
AREA F-4	NEIGHBORHOOD PARK	42,171	10527	42171	10542
AREA F-S	GATEWAY MONUMENT	14,908	3727	14716	3679
REA F-6 LOT 135, 136	FOCAL POINT	12,073	3018	6838	1709
Area F-6 , Lot 138	FOCAL POINT			8819	2205
AREA F-7	TRAFFIC CIRCLE	8,659	2165	11424	2856
AREA F-8	PARK	19,528	4882	19528	4882
AREA F-9	PARK	16,076	4019	16076	4019
AREA F-10	PARK	7,852	1963	9452	2363
AREA F-11	PLAZA	12,701	3175	11807	2951

Lots		Required per "Traditional"	<u>85%</u>	<u>Actual</u>	
133	Camden Commons I	228.08	193.868	191	P. L. 19
134	Proposed CC II	194.18	165.053	188	
135	Bank	30	25.5	45	
136	Apollo Burger	53.6	45.56	43	
137	Touchstone office Bldg.	60	51	52	
143	Goddard School	51	43.35	46	
145	Camden Medical Plaza	36	30.6	36	
140	formal open space	21	17.85	21	
138,		•	•	.[
139,				1	
141,				1	
142	Bell Apartments	432	367.2	467	4 4
	Totals	1105.86	939.981	1089	

5% OF DEVELOPABLE AREA REQUIRED FOR FORMAL OPEN SPACE

INFORMAL OPEN SPACE

10% DEVELOPABLE AREA REQUIRED FOR INFORMAL OPEN SPACE TOTAL DEVELOPABLE AREA= 41.82 ACRE, 10% OF 41.82 ACRE=182,081 S.F.

MAX. ALLOWED FLOOR AREA RATIO

	PAVED AREA	AREA OF OPEN SPACE	ТҮРЕ	CLASSIFICATION	KEY
•		1,017,610	HILLSIDE	INFORMAL	AREA I-1
<u> </u>					
		VILLAGE LAND USE DATA	RRENTLY APPROVED GATEWAY	CU	
MIXED USE PARKING	RETAIL OFFICE S.F.	TOTAL DWELLING UNITS	PC ZONED ACRE	FMPC APPROVAL DATE	DEVELOPMENT
.85 MULTIPLIER	142,258	419	60.5	. 6/3/2003	CONCEPT PLAN
.85 MULTIPLIER	144,258	402	60.5	5/22/2008	CONCEPT PLAN REV. 3
		33	4.83	8/8/2004	SECTION 1
		95	11.42	3/24/2005	SECTION 2
		39	1.12	7/27/2006	SECTION 6
7		6	0.18	9/23/2010	SECTION 6 LOT 141 (REV 6)
					APPROVED SECTION 3
154	22,851	28	2.93	9/27/2007	LOT 133
46	10,276		1.92	11/20/2008	LOT143
368	N/A (6,500 S.F. LEASING)	186	7.74	9/23/2010	SECTION 3 LOTS 138, 140, 144
575	33,127	348			TOTAL

NOTE ONLY LOTS 133 AND 143 WERE DEVELOPED FROM 9/27/2007 APPROVAL THE SITE PLAN HAS EXPIRED FOR LOTS 134 AND 514



CIVIL DESIGN CONSULTANTS, LLC

H. Michael Hindman Architects, P.C.

OFFICE BUILDING FOR

Touchstone Medical Imaging

LYNWOOD WAY LOT 137 GATEWAY VILLAGE SECTION 3 FRANKLIN, TENNESSEE




Revisions

Drawn By


Date 07.28.14

PROP. CONCEPT **AND PARKING PLAN**

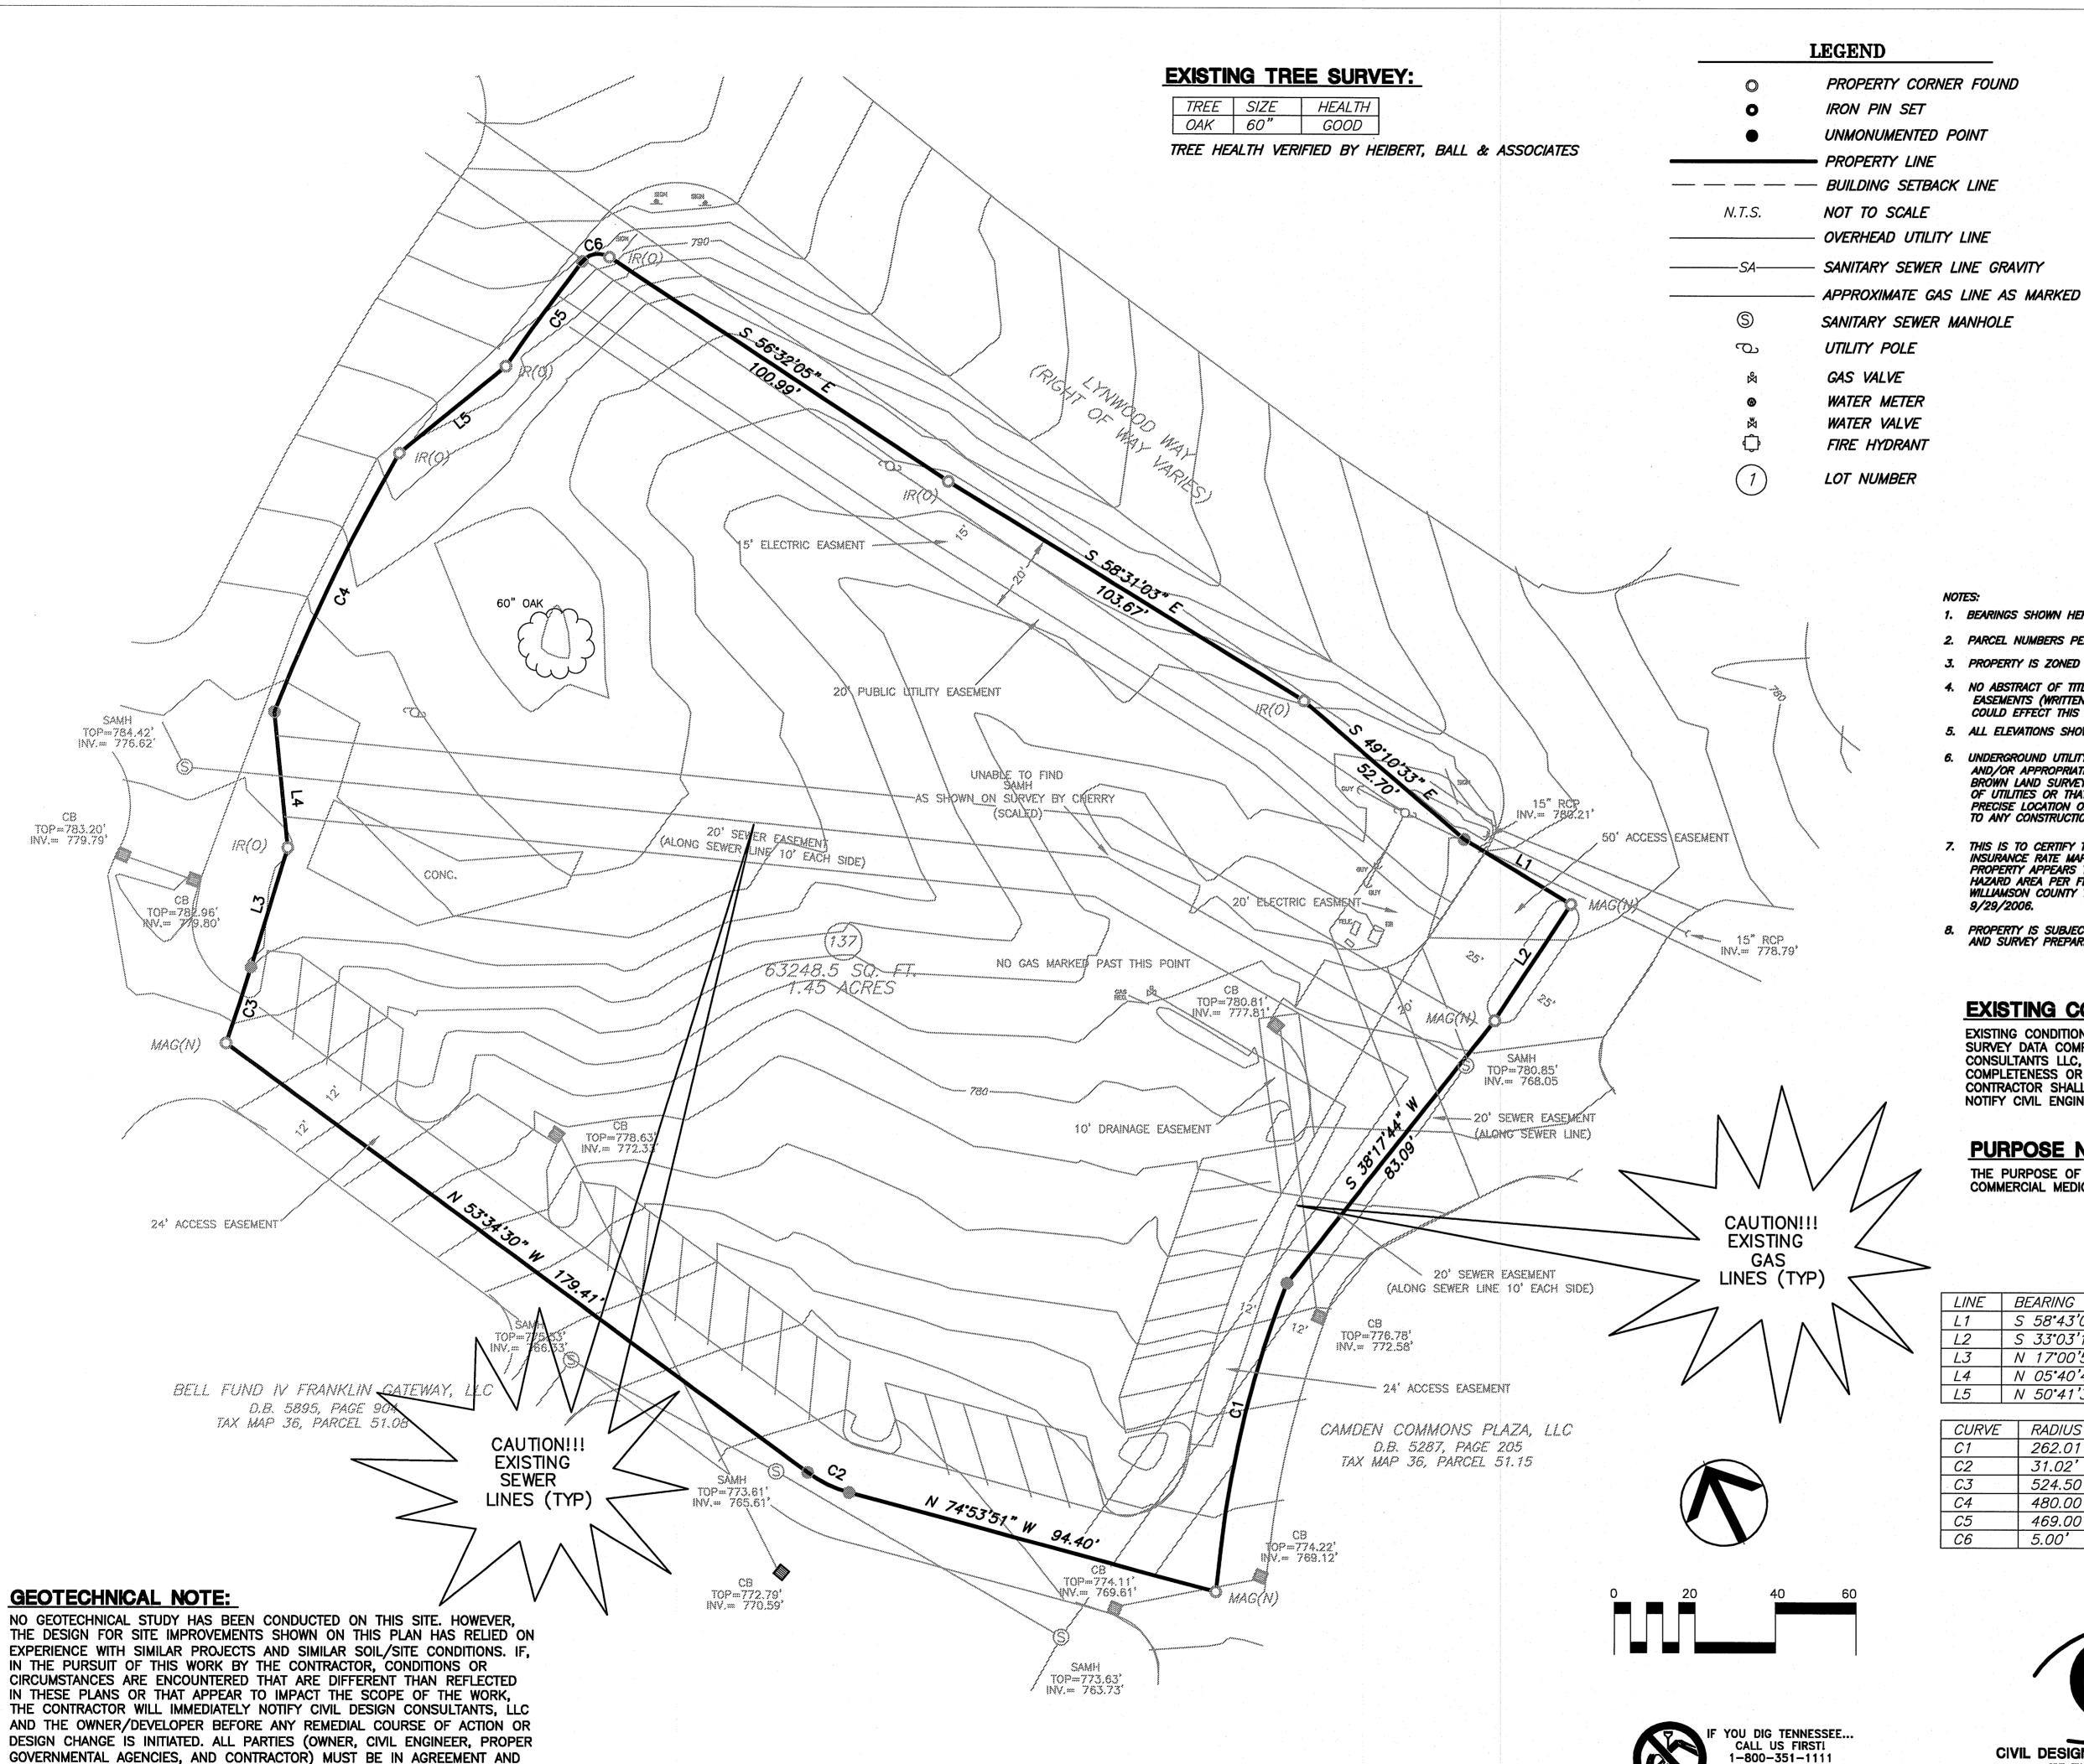

THE MAGNITUDE OF THE COST/TIME REQUIRED FOR THE MEASURES

ESTABLISHED.

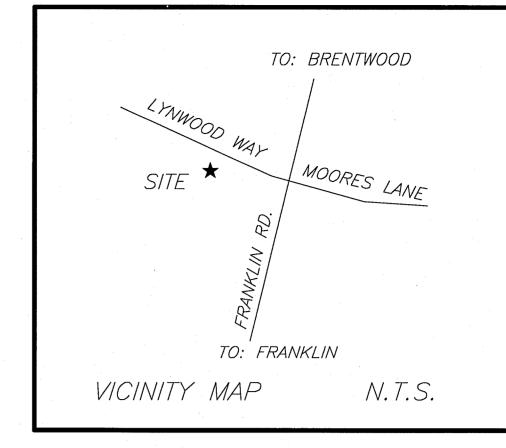

- 1. BEARINGS SHOWN HEREON ARE BASED ON TSPC.
- 2. PARCEL NUMBERS PERTAIN TO WILLIAMSON COUNTY TAX MAPS.
- 3. PROPERTY IS ZONED "PC 6.93 SUBURBAN". (PER SURVEY BY SCOTT CHERRY DATED 2/20/2008.)
- 4. NO ABSTRACT OF TITLE PROVIDED TO SURVEYOR. THERE MAY EXIST OTHER EASEMENTS (WRITTEN OR UNWRITTEN) OR DOCUMENTS OF RECORD THAT COULD EFFECT THIS PROPERTY.
- 5. ALL ELEVATIONS SHOWN ARE BASED ON NAVD88.
- 6. UNDERGROUND UTILITY LOCATIONS WERE TAKEN FROM FIELD LOCATIONS AND/OR APPROPRIATE GOVERNING AGENCIES AND ARE APPROXIMATE ONLY. BROWN LAND SURVEYING, LLC. DOES NOT CERTIFY THE EXACT LOCATION OF UTILITIES OR THAT ALL THE UTILITIES PRESENT ARE SHOWN ON THE SURVEY. PRECISE LOCATION OF UNDERGROUND UTILITIES IS RECOMMENDED PRIOR TO ANY CONSTRUCTION ON THIS PROPERTY. CALL TN-ONE CALL.
- 7. THIS IS TO CERTIFY THAT I HAVE EXAMINED THE FLOOD INSURANCE RATE MAP AND FOUND THE HEREON DESCRIBED PROPERTY APPEARS TO BE LOCATED IN A SPECIAL FLOOD HAZARD AREA PER FEMA MAP NO. 47187C0205F FOR WILLIAMSON COUNTY TENNESSEE UNINC, & INC. AREAS. DATED
- 8. PROPERTY IS SUBJECT TO EASEMENTS SHOWN ON RECORDED PLAT AND SURVEY PREPARED BY SCOTT CHERRY DATED 2/20/2008.

EXISTING CONDITIONS NOTE:

EXISTING CONDITIONS SHOWN ON THIS PLAN TAKEN FROM FIELD RUN SURVEY DATA COMPLETED BY BROWN LAND SURVEYING, INC. CIVIL DESIGN CONSULTANTS LLC, AND THIS ENGINEER, ASSUME NO LIABILITY AS TO THE COMPLETENESS OR ACCURACY OF WHAT IS SHOWN TO BE EXISTING. CONTRACTOR SHALL VERIFY IF NECECSARY ALL EXISTING CONDITIONS AND NOTIFY CIVIL ENGINEER IN THE EVENT THAT DISCREPENCIES EXIST.

PURPOSE NOTE:

THE PURPOSE OF THIS PLAN IS TO ALLOW FOR CONSTRUCTION OF A COMMERCIAL MEDICAL OFFICE DEVELOPMENT.

LINE	BEARING	DISTANCE
L1	S 58°43'02" E	31.03'
L2	S 33°03'13" W	34.63'
L3	N 17°00'51" E	31.08'
L4	N 05°40'40" W	33.96'
L5	N 50°41'39" E	34.12'

CURVE	RADIUS	ARC LENGTH	CHORD LENGTH	CHORD BEARING
C1	262.01'	67.72'	67.53'	S 13°57′36" W
C2	31.02'	11.54'	11.47'	N 64°14'32" W
<i>C3</i>	<i>524.50</i> ′	19.86'	19.86'	N 18°01'06" E
C4	480.00'	71.24'	71.17'	N 25°41'41" E
C5	469.00'	32.33'	32.32'	N 35°49'17" E
C6	5.00'	7.47'	6.79'	N 80°40'23" E




CIVIL DESIGN CONSULTANTS, LLC CIVIL ENGINEERS . LAND PLANNERS CIVIL-DESIGN-CONSULTANTS, LLC
B170 COLEY DAMS RD., MASHMILE, TN. 37221
PHONE: (615) 319-2734EMAIL: CYNICONSULTANTS@ BELLSOUTH.NE

1-615-366-1987

TENNESSEE ONE CALL

IT'S THE LAW

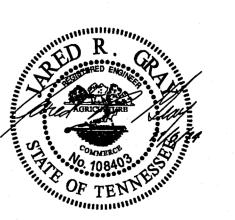

H. Michael Hindman Architects, P.C.

OFFICE BUILDING FOR

Touchstone Medical **Imaging**

LYNWOOD WAY **LOT 137 GATEWAY VILLAGE SECTION 3** FRANKLIN, TENNESSEE

Revisions


HMH Job Number Drawn By

07.28.14

Drawing

EXISTING COND.

COF #4693

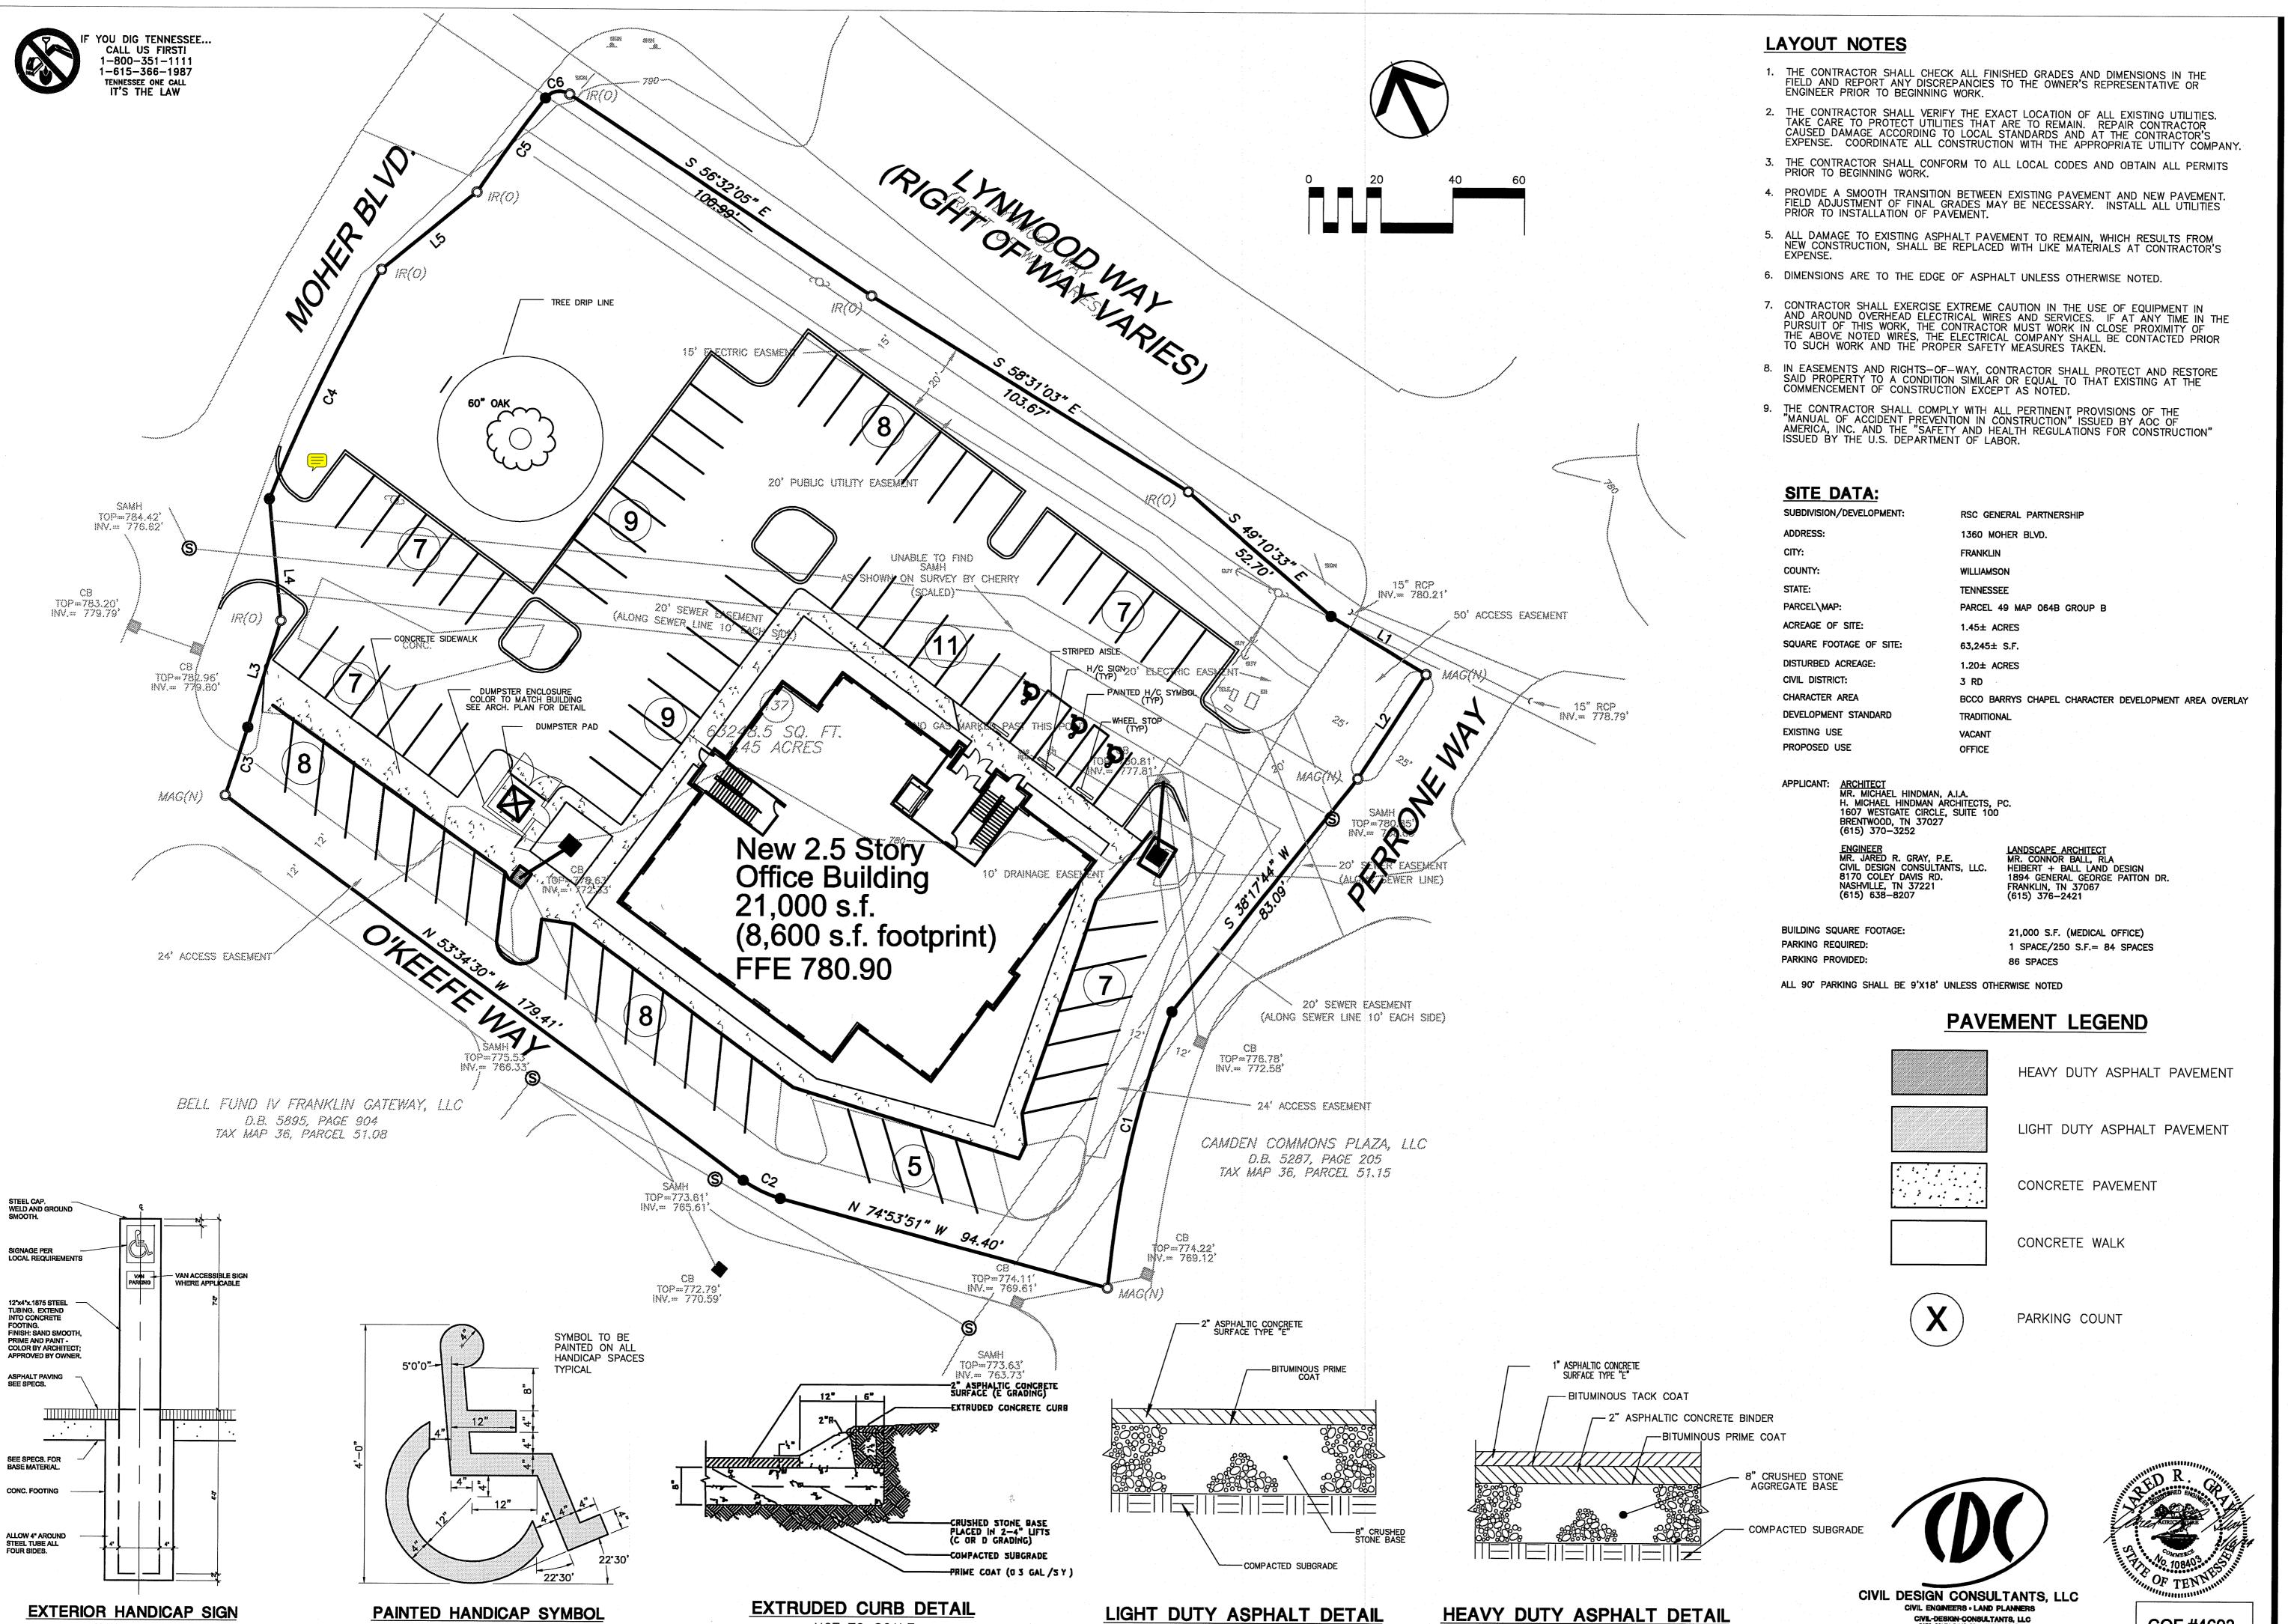

NOT TO SCALE

H. Michael Hindman Architects, P.C.

> 1607 Westgate Circle - Suite 100 Brentwood, Tennessee 37027 615.370.3252 www.hmharchitects.com

OFFICE BUILDING FOR

Touchstone Medical Imaging

LYNWOOD WAY LOT 137 GATEWAY VILLAGE SECTION 3 FRANKLIN, TENNESSEE

Revisions

HMH Job Number 14035


Drawn By

Date 07.28.14

Drawing LAYOUT PLAN

C1.0

COF #4693

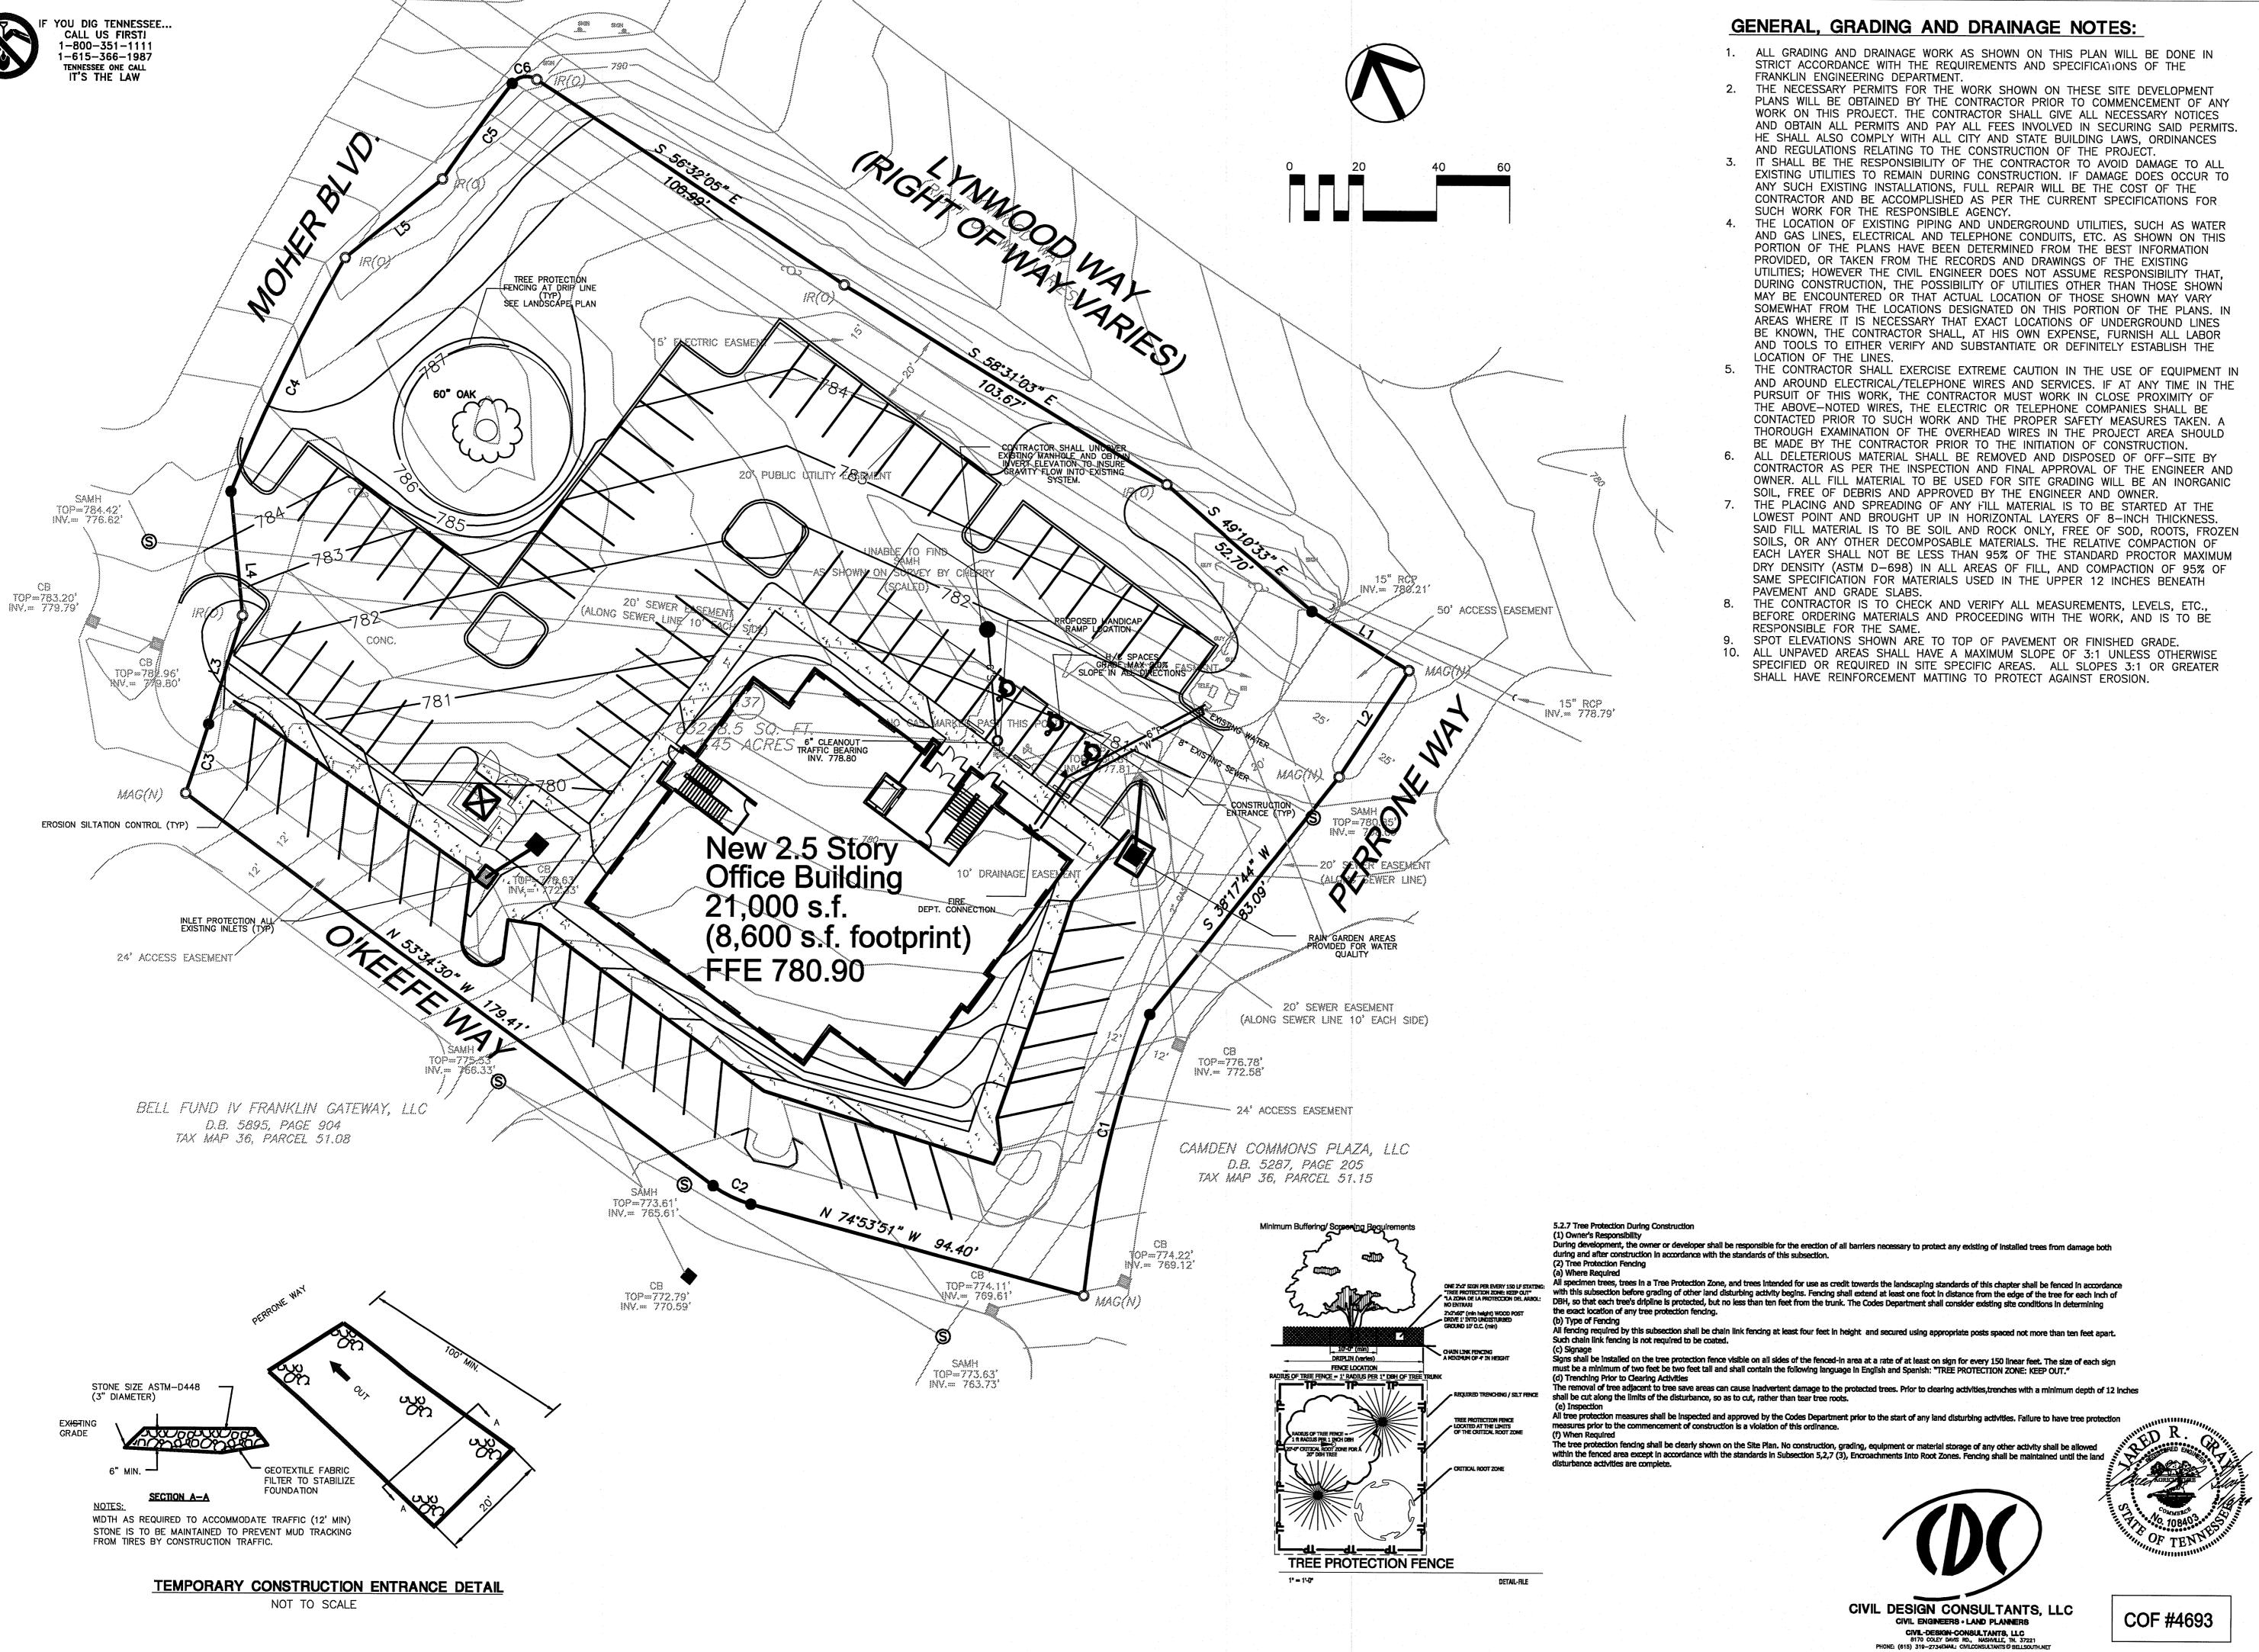

H. Michael Hindman Architects, P.C.

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OFFICE BUILDING FOR

Touchstone Medical Imaging

LYNWOOD WAY LOT 137 GATEWAY VILLAGE SECTION 3 FRANKLIN, TENNESSEE

Revisions

HMH Job Number


Drawn By HMH

Date 07.28.14

Drawing

GRADING/DRAINAGE

C2.0

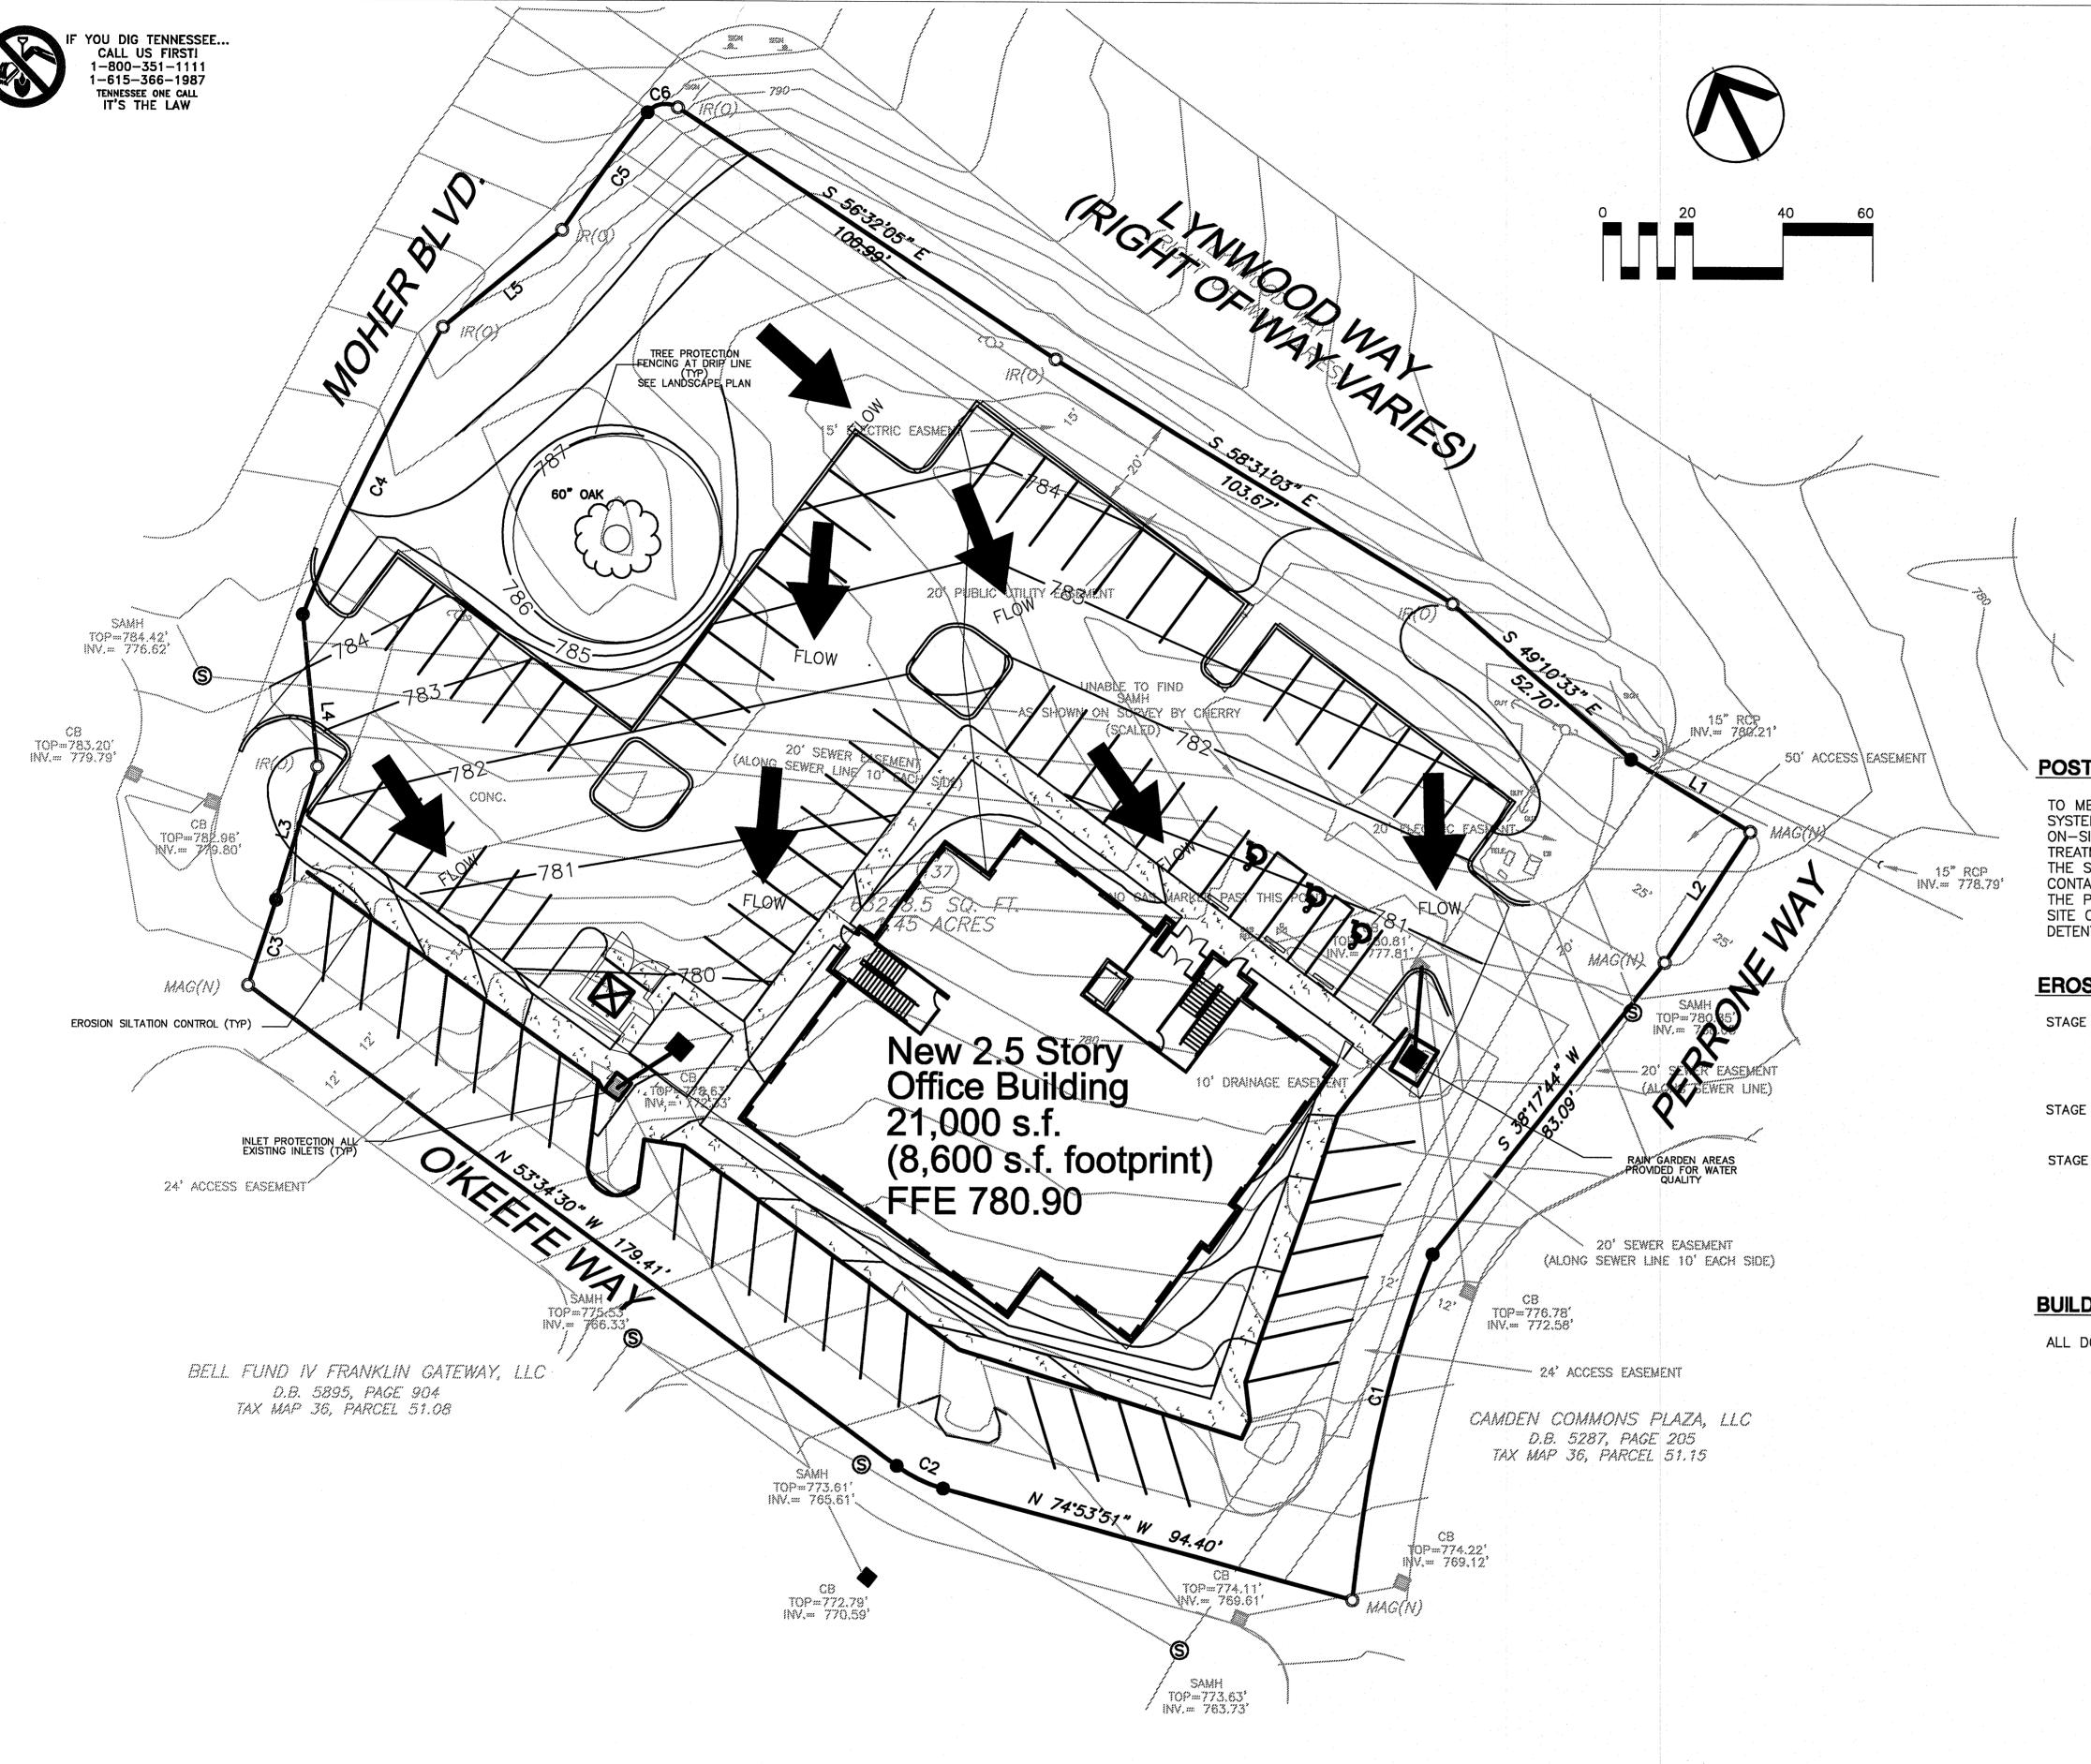

EROSION/SILTATION CONTROL NOTES

- 1. AREAS AND TIME OF EXPOSURE OF UNPROTECTED SOILS SHALL BE KEPT TO
- A MAXIMUM OF 15 DAYS.

 2. KEEP DUST WITHIN TOLERABLE LIMITS BY SPRINKLING OR OTHER ACCEPTABLE
- MEANS.
- 3. USE TEMPORARY VEGETATION AND/OR MULCH TO PROTECT BARE AREAS FROM EROSION DURING CONSTRUCTION.

 4. NO OTHER WORK WILL BE INITIATED ON THE PROJECT LINTUITIES FROM A NO OTHER WORK WILL BE INITIATED ON THE PROJECT LINTUITIES FROM A NO OTHER WORK WILL BE INITIATED ON THE PROJECT LINTUITIES FROM A NO OTHER WORK WILL BE INITIATED ON THE PROJECT LINTUITIES FROM A NO OTHER WORK WILL BE INITIATED ON THE PROJECT LINTUITIES FROM A NO OTHER WORK WILL BE INITIATED.
- 4. NO OTHER WORK WILL BE INITIATED ON THE PROJECT UNTIL THE EROSION/ SILTATION MEASURES SHOWN ON THE PLANS AND DETAILS ARE PROPERLY IN
- 5. SILT FENCING SHOWN THUS —— ARE TO BE USED AS TEMPORARY SEDIMENT BARRIERS. PER THE ATTACHED DETAILS.
- 6. IF, AT ANY TIME DURING THE CONSTRUCTION PHASE OF THIS PROJECT, THE EROSION/SILTATION MEASURES INSTALLED FAIL TO FUNCTION PROPERLY, NEED MAINTENANCE OR REPAIR, OR NEED NEW REPLACEMENT IN KIND, THE CONTRACTOR WILL EFFECT SUCH ACTIONS AS ARE NEEDED TO CORRECT THE SITUATION AT NO ADDITIONAL COST TO THE OWNER.
- 7. DISTURBED AREAS ARE TO BE GRADED TO DRAIN AS INDICATED ON PLAN TO SEDIMENT BARRIERS DURING AND UPON COMPLETION OF CONSTRUCTION.
- 8. ALL CUT/FILL AREAS TO HAVE A MINIMUM OF 6-INCH DEPTH TOPSOIL COVER. AREAS DRESSED WITH TOPSOIL WILL RECEIVE 12 POUNDS PER 1000 SQUARE FEET OF 6-12-12 FERTILIZER, 5 POUNDS OR MORE OF KENTUCKY 31 FESCUE SEED PER 1000 SQUARE FEET AND A STRAW MULCH OF 70%-80% COVERAGE (APPROXIMATELY 125 POUNDS PER 1000 SQUARE FEET) EXCEPT AS OTHERWISE DETERMINED BY PLAN.
- 9. UPON STABILIZATION OF THE PROJECT SITE WITH A GOOD (ACCEPTABLE) STAND OF GRASS AND/OR GROUND COVER, THE EROSION/SILTATION INSTALLATIONS WILL BE REMOVED AND THE AREA DISTURBED WILL BE SEEDED AND MULCHED WITH THE SAME TREATMENT AS OTHER NEW GRASSED AREAS OF THE PROJECT.
- 10. A STONE ACCESS ENTRANCE IS TO BE CONSTRUCTED AT THE SITE ENTRANCE WITH A MINIMUM WIDTH OF 20 FEET AND MINIMUM LENGTH OF 100 FEET. ENTRANCE IS TO BE BASED WITH 8 INCHES OF ASTM D 448, SIZE NO. 1 STONE, AND MAINTAINED
- THROUGHOUT CONSTRUCTION. ENTRANCE SHALL BE GEOTEXTILE REINFORCED.

 11. PRIOR TO THE ISSUANCE OF A GRADING PERMIT, ALL EROSION/SILTATION CONTROL MEASUREMENTS INDICATED ON THE PLANS SHALL BE INSTALLED.

POST CONSTRUCTION BMP/WATER QUALITY NOTE:

TO MEET THE FRANKLIN STORMWATER QUALITY REGULATIONS, A STORM DRAINAGE TREATMENT SYSTEM SHALL BE INSTALLED. DUE TO HAVING AVAILABLE SITE AREA FOR NATURAL DRAINAGE, ON—SITE STORM DRAINAGE SHALL BE DIRECTED TO A RAIN GARDEN AREA FOR STORMWATER TREATMENT. THESE STRUCTURES ARE DESIGNED TO SEPARATE CONTAMINATED EFFLUENT FROM THE STORMWATER DRAINAGE THROUGH PHYDOREMEDIATION AND ABSORBTION OF THE CONTAMINATED EFFLUENT INTO THE ROOT SYSTEM OF VEGETATION. THIS SYSTEM WILL CONTROL THE POLLUTANT LEVELS AND CONTROL DISCHARGE VELOCITIES FROM STORMWATER RUNOFF. THE SITE OWNER SHALL BE RESPONSIBLE FOR MAINTAINING ALL STORMWATER QUALITY AND DETENTION SURFACES ON THIS SITE PER THE FRANKLIN STORMWATER REGULATIONS.

EROSION CONTROL SCHEDULE:

- STAGE #1: SILT FENCE SHALL BE INSTALLED PRIOR TO ANY GRADING OPERATIONS.
 STRAW CHECK DAMS AND INLET PROTECTION AROUND ALL EXISTING DRAINAGE
 STRUCTURES SHALL BE INSTALLED PRIOR TO ANY GRADING OPERATIONS. TREE
 PROTECTION, IF REQUIRED BY LANDSCAPE PLAN, IS TO BE INSTALLED AT THIS
 TIME. A GRADING PERMIT CAN BE OBTAINED FROM BRENTWOOD CODES AND
 ENGINEERING DEPARTMENT AFTER STAGE #1 HAS PASSED THEIR INSPECTION.
- STAGE #2: CONSTRUCT SITE IMPROVEMENTS PROVIDING INLET PROTECTION AND ALL OTHER EROSION CONTROL MEASURES AS THE DRAINAGE SYSTEM IS
- STAGE #3: REMOVE EROSION CONTROL DEVICES ONLY AFTER A PROPER STAND OF GRASS IS OBTAINED AND ONLY UPON APPROVAL FROM THE FRANKLIN STORMWATER DEPARTMENT

BUILDING DRAINAGE NOTE:

ALL DOWNSPOUTS SHALL BE DIRECTED TO THE RAIN GARDEN AREAS.

Revisions

H. Michael Hindman

OFFICE BUILDING FOR

Architects, P.C.

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Touchstone

Imaging

LYNWOOD WAY

LOT 137 GATEWAY

VILLAGE SECTION 3

FRANKLIN, TENNESSEE


HMH Job Number 14035

Drawn By HMH

Date 07.28.14


Drawing STORMWATER

C3.0

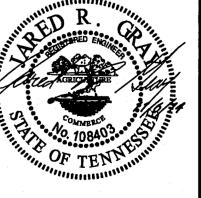

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COF #4693

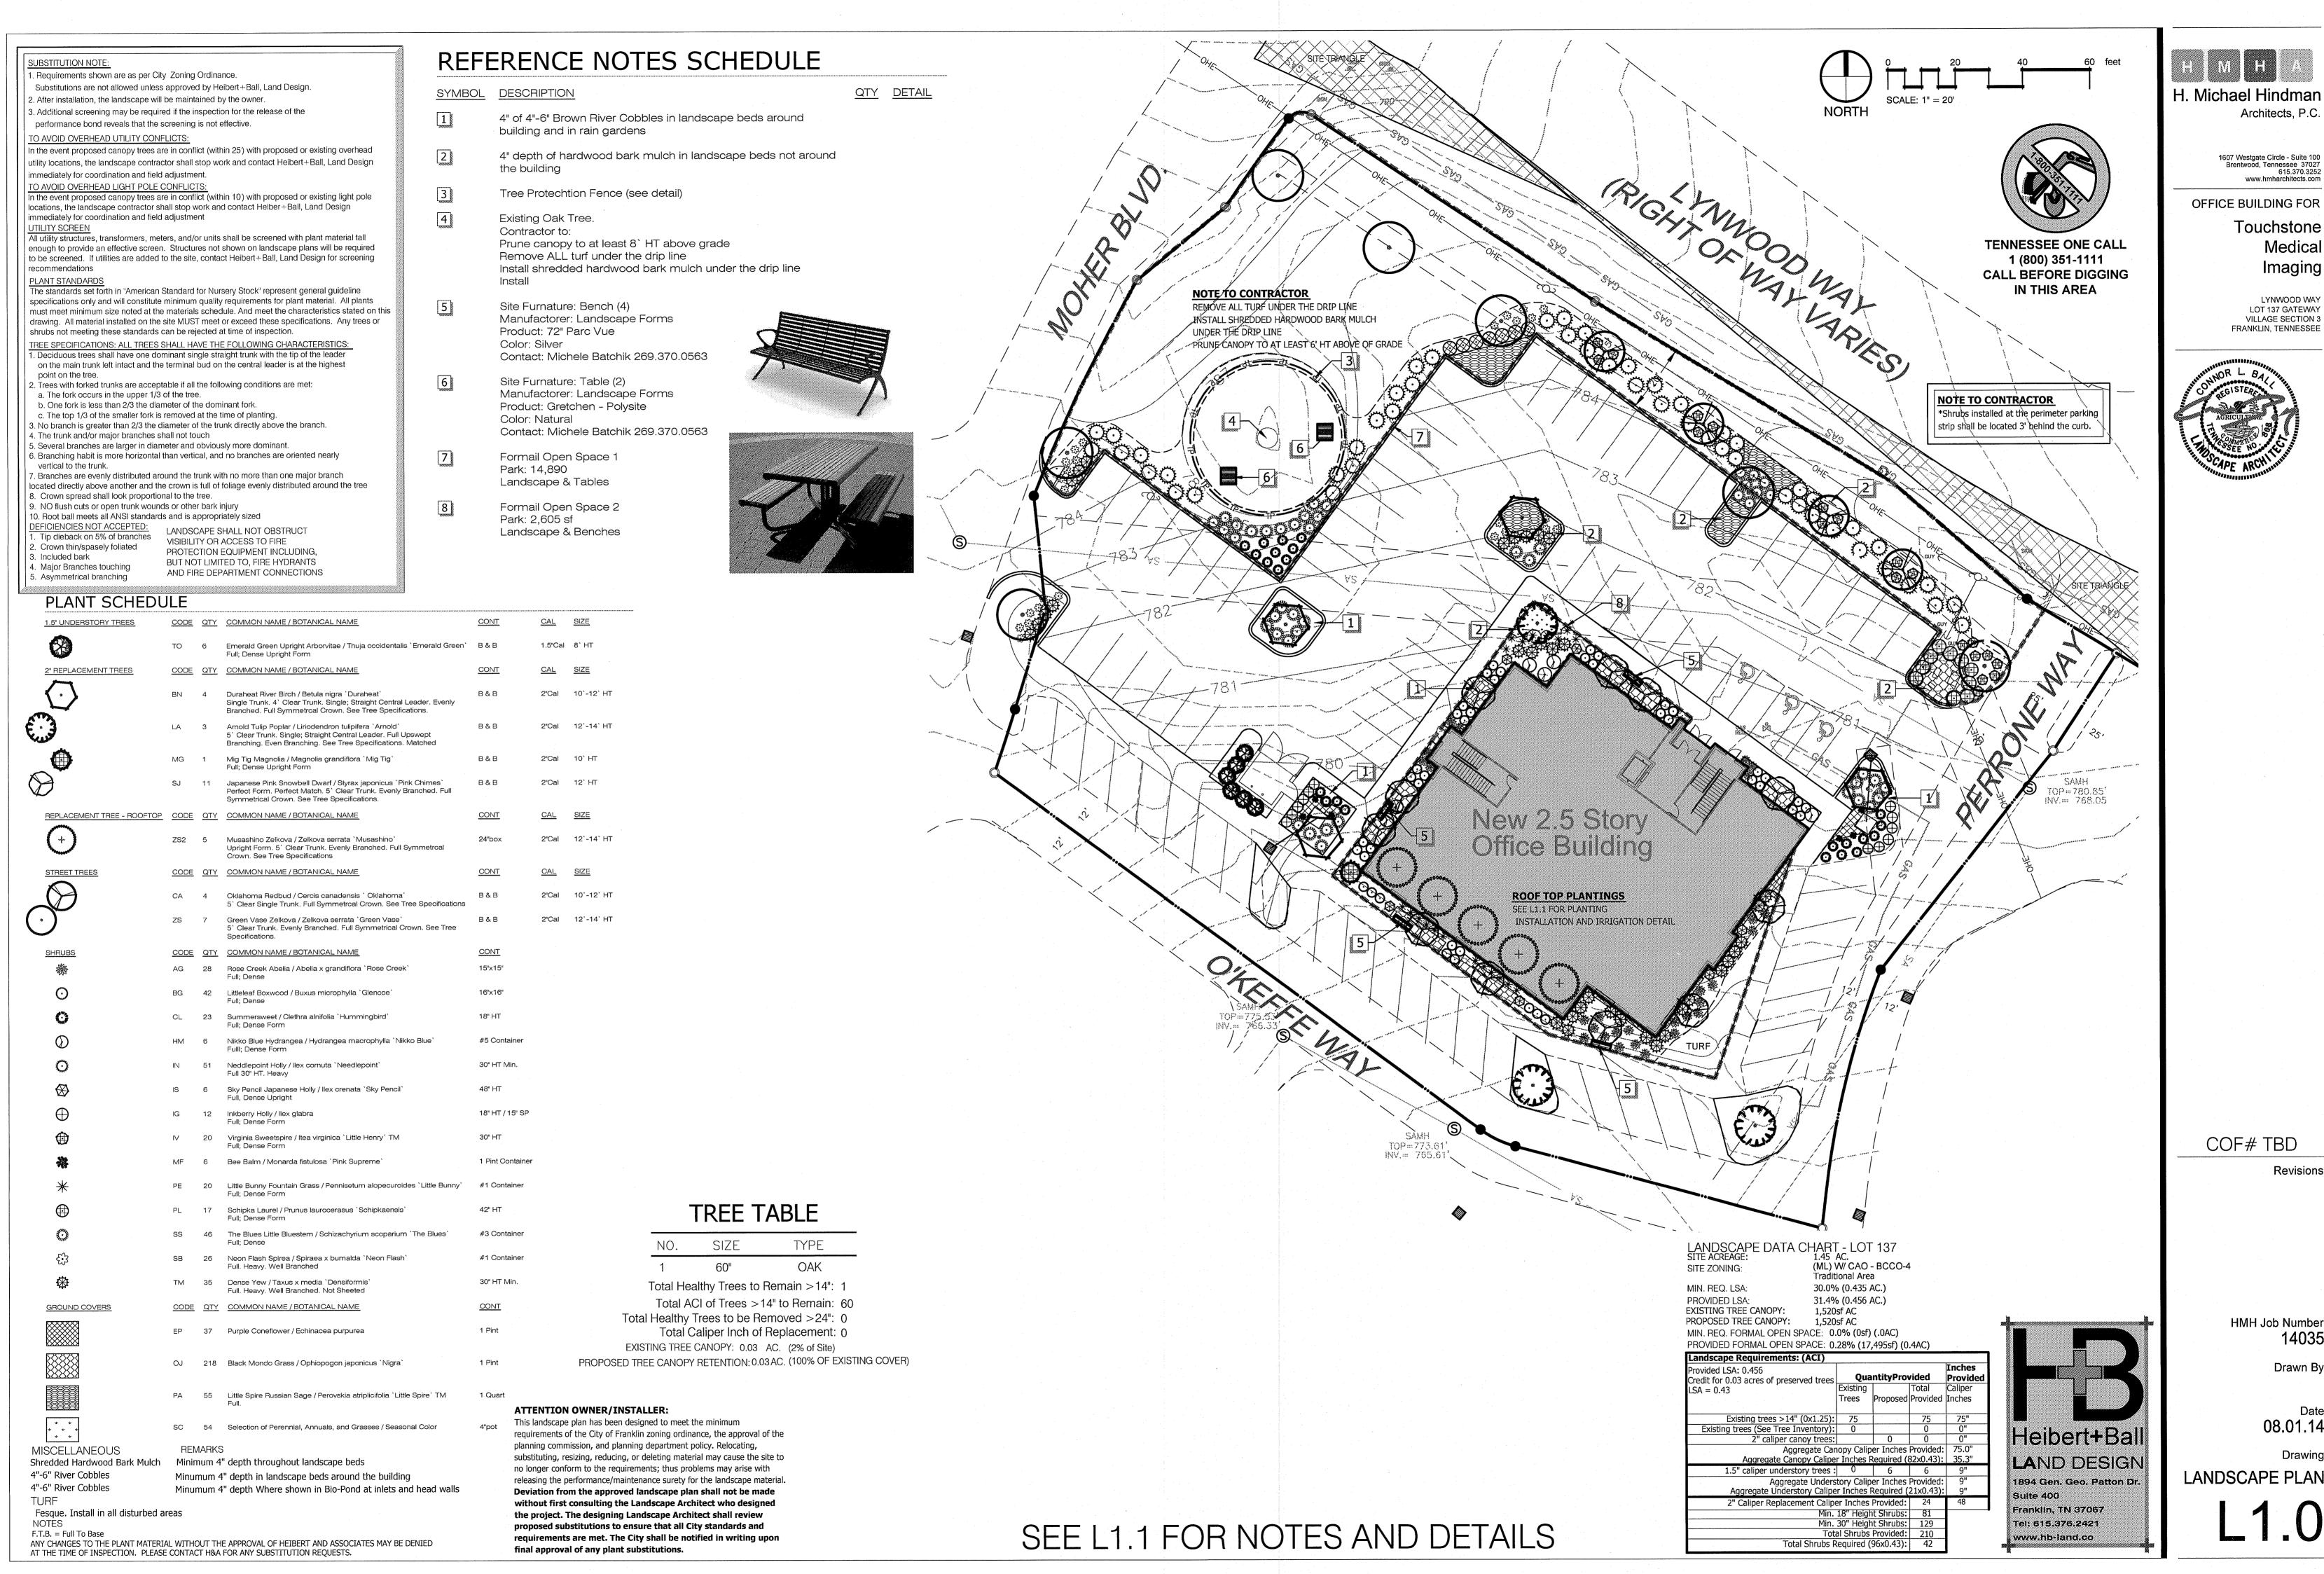


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OFFICE BUILDING FOR Touchstone Medical

> LYNWOOD WAY **LOT 137 GATEWAY** VILLAGE SECTION 3 FRANKLIN, TENNESSEE

Imaging



COF# TBD
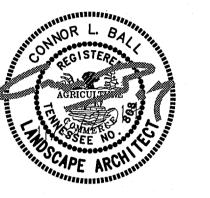
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Drawn By

08.01.14 Drawing

GATEWAY VILLAGE TREE TAKEDOWN CHART				
Site Specimen Tree Replacement Required				
TOTAL SITE INCHES REQUIRED TO BE REPLACED	1,341			
TOTAL REPLACEMENT CALIPER INCH FROM SEC. 1	189			
TOTAL REPLACEMENT CALIPER INCH FROM SEC. 2	354			
TOTAL REPLACEMENT CALIPER INCH FROM SEC. 6	17.75			
TOTAL REPLACEMENT CALIPER INCHES FOR SEC 3 LOT 133	105.0			
TOTAL REPLACEMENT CALIPER INCHES FROM SEC 3 LOT 143	55.0			
TOTAL REPLACEMENT CALIPER INCHES FROM LOT 145	9.0			
TOTAL REPLACEMENT CALIPER INCHES FOR SECTION 3 & 6 LOTS 138, 139, 140, 141, 142	198.0			
PROPOSED REPLACEMENT CALIPER INCHES FROM FOR LOT 137	48			
DEVELOPMENT REPLACEMENT CALIPER INCHES REMAINING:	365.25			

TYPE

Section 1 Median/Circle

Secton 2 Median/Green

Neighborhood Park

Gateway Monument

Section 2 Park

Focal Point

Focal Point

Focal Point

Park

Traffic Circle

DRIPLIN (varies)

FENCE LOCATION RADIUS OF TREE FENCE = 1' RADIUS PER 1" DBH OF TREE TRUNK

1 ft radius per 1 inch dbh

0'-0" CRITICAL ROOT ZONE FOR A / 20" DBH TREE

area

F-2

F-4

F-5

F-6 (LOT 135)

F-6 (LOT 138)

F-6 (LOT 145)

F-7

F-8

F-10

F-11 (LOT 135)

F-9 (Lot 137)

MINIMUM OPEN SPACE REQUIREMENTS FOR RESIDENTIAL FORMAL OPEN SPACE

APPROVED AREA

OF OPEN SPACE

9,996 SF

6,624 SF

11,623 SF

42,171 SF

14,908 SF

12,073 SF

19,528 SF

16,076 SF

7,852 SF

MAXIMUM 25% PAVED AREA

2,499 SF

1,656 SF

2,906 SF

10,527 SF

3,727 SF

3,018 SF

2,165 SF

4,882 SF

4,019 SF

1,963 SF

□ Not Applicable THIS DEVELOPMENT IS REQUIRED TO HAVE THE FOLLOWING LANDSCAPE IMPROVEMENTS

Buffer/ Screening Type: Purpose: □ Not Applicable Buffering/ Screening not required ■ Foundation planting Along primary facade ■ Perimeter Planting Strip Screen VUAs and to create "modules' ■ Interior VUA Planting Create VUA "modules" ■ Utility Box Screen Screen from view

HVAĆ Screen Screen HVAC from view ■ Dumpster Screen Screen Dumpster from view ☐ Loading/service Area Buffer the street or residential property ☐ Incompatible Use Buffer
☐ 30-foot Front Yard Buffer Buffer the adjacent less intensive use Buffer the adjacent Hatcher Bypass ☐ 40-foot Front Yard Buffer Buffer the adjacent Interstate 65

Connor Ball, PLA 615.376.2421 615.791.3212 phone 615.791.3257 fax

Heibert+Ball Land Design

Spatial Definition/Environmental Mitigation

FRANKLIN PLANNING DEPARTMENT:

3,175 SF 709 SF 2,837 SF 12,701 SF F-11 (LOT 136) 3,160 SF 12,640 SF F-11 (LOT 145) Plaza 162,211 SF (3.72 Acres) 171,277 SF (3.93 Acres) 5% of Developable Area Required for Formal Open Space NOTE: PLANNING COMMISSION APPROVED MINIMUM 160,533 SF Total Developable Area = 41.82 AC, 5% of 41.82 AC = 91,040 SF (2.09 AC) Concept Plan - Staff Comments - Expand Formal Open Space 5.2.7 Tree Protection During Construction Minimum Buffering/ Screening Requirements

PROPOSED AREA

9,170 SF

3,981 SF

7,150 SF

42,334 SF

13,041 SF

5,059 SF

7,491 SF

1,225 SF

11,804 SF

24,115 SF

17,495 SF

12,453 SF

OF OPEN SPACE

PROPOSED MAXIMUM

25% PAVED AREA

2,292 SF

995 SF

1,787 SF

10,583 SF

3,260 SF

1,264 SF

1,872 SF

306 SF

2,951 SF

6,028 SF

4,029 SF

3,113 SF

120 SF

TREE PROTECTION ZONE: KEEP OUT"

- REQUIRED TRENCHING / SILT FENCE

LOCATED AT THE LIMITS
OF THE CRITICAL ROOT ZONE

CRITICAL ROOT ZONE

2'x2'x60" (min height) WOOD POST

DRIVE 1' INTO UNDISTURBED
GROUND 10' O.C. (min)

A MINIMUM OF 4' IN HEIGHT

During development, the owner or developer shall be responsible for the erection of all barriers necessary to protect any existing of installed trees from damage both during and after construction in accordance with the standards of this subsection. (2) Tree Protection Fencing (a) Where Required

■ Street Trees

LANDSCAPE ARCHITECT:

□ Other:

□ Ground


All specimen trees, trees in a Tree Protection Zone, and trees intended for use as credit towards the landscaping standards of this chapter shall be fenced in accordance with this subsection before grading of other land disturbing activity begins. Fencing shall extend at least one foot in distance from the edge of the tree for each inch of DBH, so that each tree's dripline is protected, but no less than ten feet from the trunk. The Codes Department shall consider existing site conditions in determining the exact location of any tree protection fencing.

All fencing required by this subsection shall be chain link fencing at least four feet in height and secured using appropriate posts spaced not more than ten feet apart. Such chain link fencing is not required to be coated. Signs shall be installed on the tree protection fence visible on all sides of the fenced-in area at a rate of at least on sign for every 150 linear feet. The size of each sign

must be a minimum of two feet be two feet tall and shall contain the following language in English and Spanish: "TREE PROTECTION ZONE: KEEP OUT." (d) Trenching Prior to Clearing Activities The removal of tree adjacent to tree save areas can cause inadvertent damage to the protected trees. Prior to clearing activities, trenches with a minimum depth of 12 inches shall be cut along the limits of the disturbance, so as to cut, rather than tear tree roots.

All tree protection measures shall be inspected and approved by the Codes Department prior to the start of any land disturbing activities. Failure to have tree protection measures prior to the commencement of construction is a violation of this ordinance.

The tree protection fencing shall be clearly shown on the Site Plan. No construction, grading, equipment or material storage of any other activity shall be allowed within the fenced area except in accordance with the standards in Subsection 5,2,7 (3), Encroachments Into Root Zones. Fencing shall be maintained until the land disturbance activities are complete.

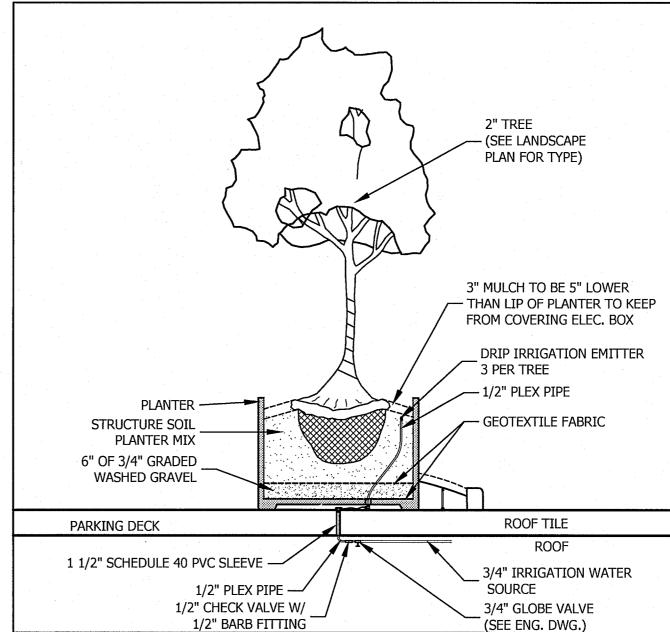

SCALE: 1/2" =1'-0" SECTION

PLANTER PLANTING DETAIL / DRIP IRRIGATION CONNECTION

1. Requirements shown are as per City Zoning Ordinance.

Substitutions are not allowed unless approved by Heibert+Ball, Land Design. After installation, the landscape will be maintained by the owner. 3. Additional screening may be required if the inspection for the release of the performance bond reveals that the screening is not effective.

O AVOID OVERHEAD UTILITY CONFLICTS:

In the event proposed canopy trees are in conflict (within 25') with proposed or existing overhead utility locations, the landscape contractor shall stop work and contact Heibert+Ball, Land Design immediately for coordination and field adjustment. O AVOID OVERHEAD LIGHT POLE CONFLICTS

In the event proposed canopy trees are in conflict (within 10') with proposed or existing light pole locations, the landscape contractor shall stop work and contact Heiber+Ball, Land Design immediately for coordination and field adjustment UTILITY SCREEN

All utility structures, transformers, meters, and/or units shall be screened with plant material tall enough to provide an effective screen. Structures not shown on landscape plans will be required to be screened. If utilities are added to the site, contact Heibert+Ball, Land Design for screening recommendations

PLANT STANDARDS The standards set forth in "American Standard for Nursery Stock" represent general guideline

3. Included bark

4. Major Branches touching

5. Asymmetrical branching

specifications only and will constitute minimum quality requirements for plant material. All plants must meet minimum size noted at the materials schedule. And meet the characteristics stated on this drawing. All material installed on the site MUST meet or exceed these specifications. Any trees or shrubs not meeting these standards can be rejected at time of inspection.

TREE SPECIFICATIONS: ALL TREES SHALL HAVE THE FOLLOWING CHARACTERISTICS: Deciduous trees shall have one dominant single straight trunk with the tip of the leader on the main trunk left intact and the terminal bud on the central leader is at the highest

a. The fork occurs in the upper 1/3 of the tree. b. One fork is less than 2/3 the diameter of the dominant fork. c. The top 1/3 of the smaller fork is removed at the time of planting. 3. No branch is greater than 2/3 the diameter of the trunk directly above the branch.

4. The trunk and/or major branches shall not touch 5. Several branches are larger in diameter and obviously more dominant. 6. Branching habit is more horizontal than vertical, and no branches are oriented nearly vertical to the trunk.

7. Branches are evenly distributed around the trunk with no more than one major branch located directly above another and the crown is full of foliage evenly distributed around the tree

Crown spread shall look proportional to the tree. 9. NO flush cuts or open trunk wounds or other bark injury

10. Root ball meets all ANSI standards and is appropriately sized DEFICIENCIES NOT ACCEPTED: LANDSCAPE SHALL NOT OBSTRUCT Tip dieback on 5% of branches Crown thin/spasely foliated

VISIBILITY OR ACCESS TO FIRE PROTECTION EQUIPMENT INCLUDING, BUT NOT LIMITED TO, FIRE HYDRANTS AND FIRE DEPARTMENT CONNECTIONS 1. The Owner shall submit a Certificate of Landscape Compliance to the Building and Codes Department upon completion of the landscape

2. Upon submittal of a Certificate of Landscape Compliance contact Building and Codes to schedule a Landscape Inspection. 3. No Certificate of Occupancy shall be issued until all landscape materials are in place in substantial compliance with the approved landscape plan.

4. All trees and shrubs shall be tagged according to species. Tags shall not be removed until after the Site Inspection for the issuance of a Certificate of Occupancy. 5. Any plant material that dies, turns brown or defoliates shall be replaced within one year or by the next growing season, whichever comes first. Other defective landscape material shall be replaced within three months.

6. All trees shall be straight trunked, full headed and meet all requirements specified. All trees and shrubs must be container grown or balled and burlapped with sizes indicated on the plant schedule on the approved plans. All plants shall be healthy, vigorous material, free of pest and disease. All rootballs, containers and height to width ratios shall conform to the size standards set forth in the American Standards for Nursery Stock, current edition.

7. All required deciduous trees shall be a minimum of 2" (two inches) in caliper at planting. 8. All required evergreen trees shall be a minimum of 6' (six feet) in height at planting.

9. All required shrubs shall be a minimum of 18" in height at planting.

10. Any site or landscape changes (including but not limited to a change in design, a reduction in size or number of plant material, or the relocation of overhead or underground utilities) will require a revised landscape plan to be submitted and approved prior to the landscape installation.

11. The Owner acknowledges that landscaping in a dedicated easement does not waive or modify the City rights as the easement holder. The Owner understands that the City, its authorized contractor or applicable private utility may at any time and for any reason perform work within the dedicated easement. The City, its authorized contractor or applicable private utility shall have no liability to the Owner for any damage to the landscaping in the easement when said damage is due to work within the easement. The Owner may be held responsible for the removal of the landscaping to enable work to be done. The Owner shall be solely responsible for any costs incurred in repairing and/or replacing the required landscaping. 12. ATTENTION OWNER/ INSTALLER:

This landscape plan has been designed to meet the minimum requirements of the City Zoning ordinance, the approval of the planning commission, and planning department policy. Relocating, substituting, resizing, reducing or deleting material may cause the site to no longer conform to the requirements; Thus problems may arise with releasing the performance/ maintenance bond for landscaping. Deviation from the approved landscape plan shall not be made without first consulting Heibert+Ball, Land Design and then obtaining approval from either the planning commission or the planning department.

COF# TBD

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Touchstone

Medical

lmaging

LYNWOOD WAY

LOT 137 GATEWAY

VILLAGE SECTION 3

FRANKLIN, TENNESSEE

OFFICE BUILDING FOR

TENNESSEE ONE CALL

1 (800) 351-1111

CALL BEFORE DIGGING


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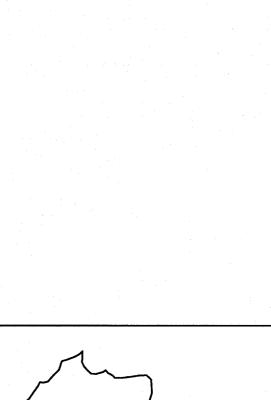
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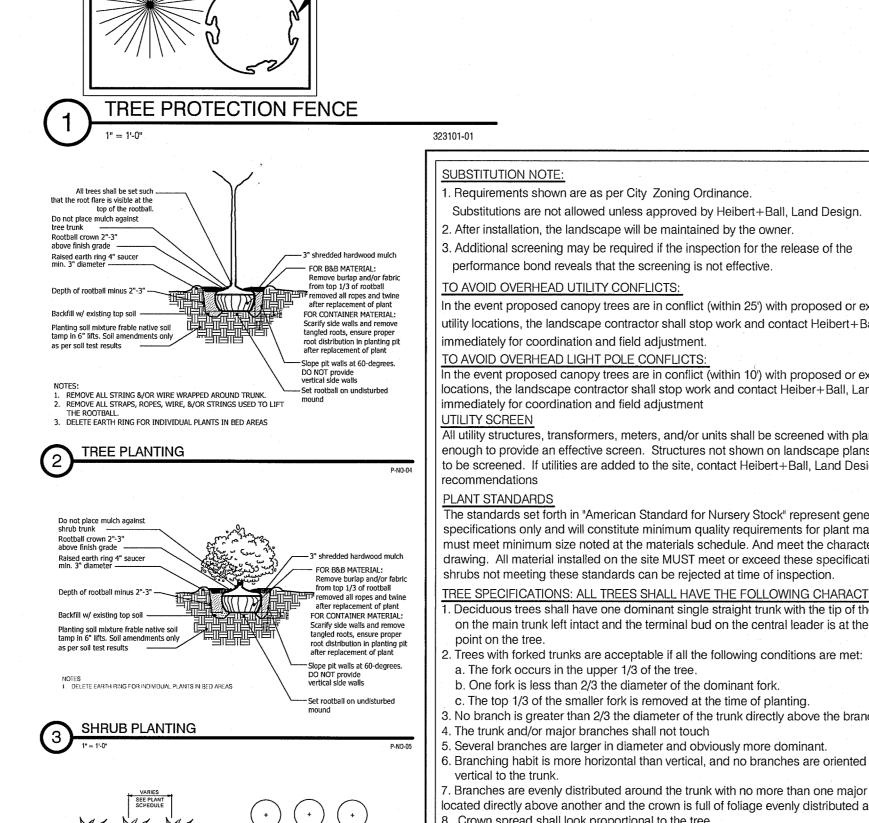
Drawn By

08.01.14

NOTES & DETAILS






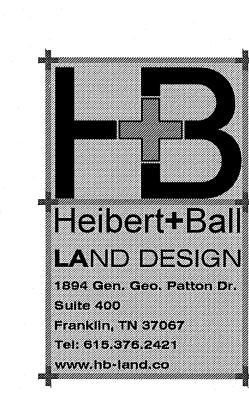

GROUND COVER / PERENNIAL PLANTING

GROUNDCOVER PLANTING

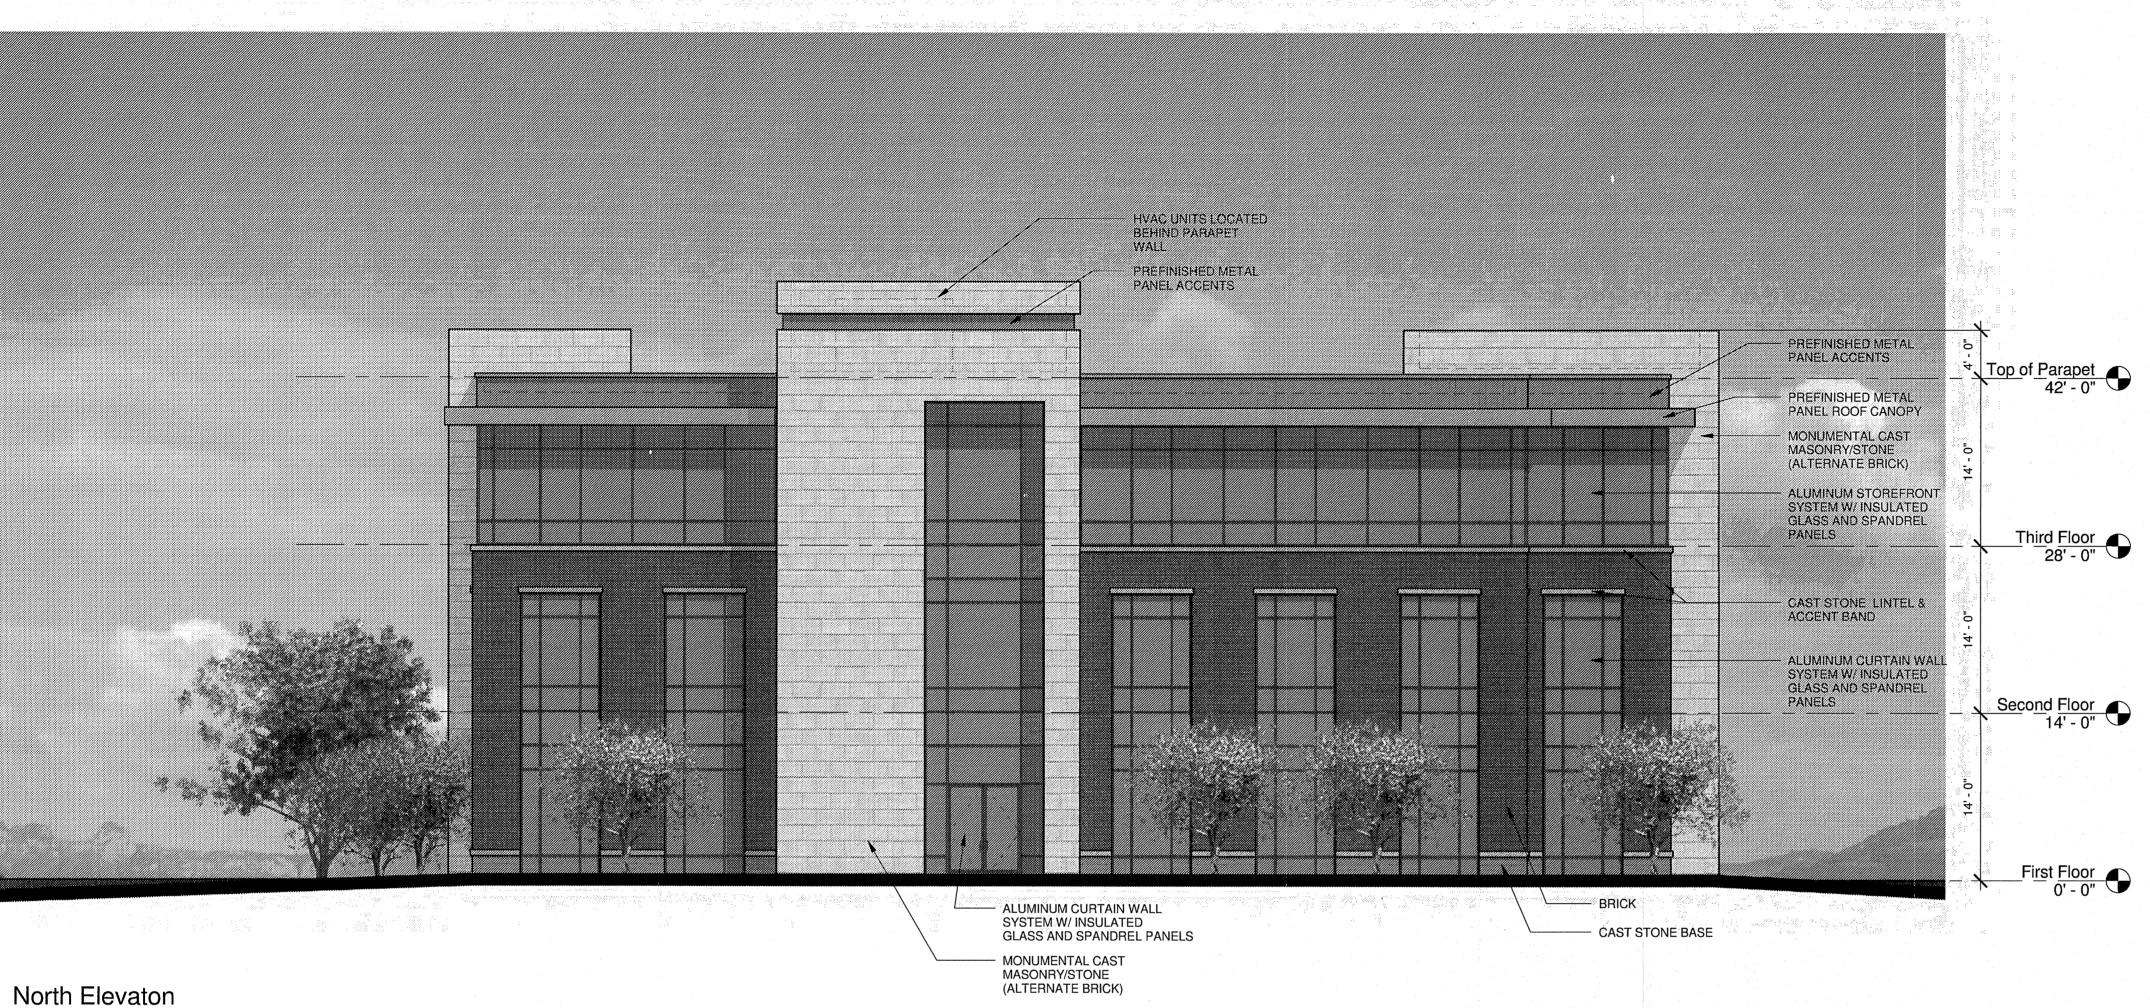



West Elevation 1/8" = 1'-0"

NOTES

- LOCATON AND NUMBERS OF STOREFRONT DOORS SUBJECT TO CHANGE PER TENANT REQUIREMENTS.
- LOCATION AND NUMBERS OF REAR & EGRESS DOORS SUBJECT TO CHANGE PER TENANT REQUIREMENTS.
- TENANT SIGNS WILL BE SUBMITTED FOR APPROVAL AS TENANT
- REQUIREMENTS ARE DETERMINED. SPECIFIED MATERIALS MAY CHANGE SUBJECT TO AVAILABILITY AT
- TIME OF CONSTRUCTION AND SUBJECT TO APPROVAL OF BNS DEPARTMENT OR PLANNING COMMISSION. THESE ELEVATIONS HAVE BEEN DESIGNED TO MEET THE
- REQUIREMENTS OF THE CITY OF FRANKLIN'S ARCHITECTURAL DESIGN STANDARDS AND THE APPROVAL OF THE PLANNING COMMISSION. CHANGES SHALL NOT BE MADE TO THE APPROVED ELEVATIONS UNLESS APPROVED BY EITHER THE BNS DEPARTMENT OR THE PLANNING COMMISSION.
- HVAC UNITS ARE LOCATED ON THE ROOFS OF THE BUILDING AND ARE SCREENED FROM PUBLIC VIEW BY PARAPET WALLS.
- CAVITY WALL CONSTRUCTION SHALL BE USED WHEREVER INTEGRALLY COLORED, UNPAINTED, SPLIT FACE CONCRETE BLOCK IS USED TO PREVENT WATER PENETRATION.

EXTERIOR FINISH LEGEND

BRICK	
STYLE/SIZE:	UTILITY
COLOR:	RED/BROWN
MANUFACTURER:	TBD
MORTAR:	TBD
MORTAR MANUE.:	TBD

MONUMENTAL CAST STONE
STVI E/SIZE: TRENDSTONE PLUS MONUMENTAL SERIES

MANUFACTURER: TRENWYTH

MORTAR MANUF .: BRICK OF SIMILAR COLOR ALTERNATE:

BUFFSTONE, GP-A MANUFACTURER: ROCK CAST SAME AS ADJACENT MASONRY

SPLIST/STPS-304 (3.625"x23.625")

COLOR: MANUFACTURER: PRAIRIE STONE MORTAR: MORTAR MANUF.:

STOREFRONT & CURTAIN WALL
STYLE/SIZE: ALUMINUM RECTANGULAR KYNAR CHARCOAL GRAY OR ANODIZED DARK

BRONZE TUBELITE OR EQUAL MANUFACTURER:

<u>GLAZING</u> STYLE/SIZE: COLOR:

1" INSULATED LOW-E SOLAR BLUE + SOLARBAN 70XL (3) MANUFACTURER: PPG OR EQUAL

SMOOTH METAL PANEL, 18" PEWTER/TITANIUM CENTRIA/ALUCOBOND OR EQUAL

METAL PANEL/SCREEN ACCENT
STYLE/SIZE: PROFILE SERIES, CS-660
COLOR: ORANGE VERMILLION
MANUFACTURER: CENTRIA

MATERIAL AREA NOTES

- MINOR MATERIALS INCLUDING COPINGS, FLASHINGS, AND TRIM INSTALLED OVER BRICK ARE NOT INCLUDED IN MATERIAL AREA
- CALCULATIONS.
 NET WALL AREA EXCLUDES STOREFRONT, DOORS, LOUVERS AND

MATERIAL CALCULATIONS

NORTH ELEVATION

	AREA	% OF NET
GROSS WALL AREA	4427S.F.	.A%
NET WALL AREA	2320S.F.	100%
BRICK AREA	1007 S.F.	44%
CAST STONE AREA	952 S.F.	41%
METAL PANEL/CANOPY	361 S.F.	15%

WEST ELEVATION

	AREA	% OF NET
GROSS WALL AREA	3352 S.F.	NA%
NET WALL AREA	1897 S.F.	100%
BRICK AREA	1055 S.F.	56%
CAST STONE AREA	657 S.F.	35%
METAL PANEL/CANOPY	185 S.F.	9%

CONCEPT DESIGN

FINAL DESIGN TO BE SUBMITTED FOR SITE PLAN APPROVAL




H. Michael Hindman Architects, P.C.

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OFFICE BUILDING FOR

Touchstone Medical

LYNWOOD WAY **LOT 137 GATEWAY** VILLIAGE SECTION 3

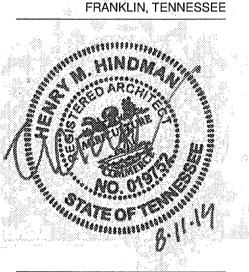

Revisions

HMH Job Number

Drawn By

Date 08.11.14

Drawing Elevations



A2

East Elevation



South Elevation

1/8" = 1'-0"

NOTES

 LOCATON AND NUMBERS OF STOREFRONT DOORS SUBJECT TO CHANGE PER TENANT REQUIREMENTS.
 LOCATION AND NUMBERS OF REAR & EGRESS DOORS SUBJECT TO CHANGE PER TENANT REQUIREMENTS.
 TENANT SIGNS WILL BE SUBMITTED FOR APPROVAL AS TENANT

TENANT SIGNS WILL BE SUBMITTED FOR APPROVAL AS TENANT REQUIREMENTS ARE DETERMINED.

SPECIFIED MATERIALS MAY CHANGE SUBJECT TO AVAILABILITY AT TIME OF CONSTRUCTION AND SUBJECT TO APPROVAL OF BNS

DEPARTMENT OR PLANNING COMMISSION.
THESE ELEVATIONS HAVE BEEN DESIGNED TO MEET THE
REQUIREMENTS OF THE CITY OF FRANKLIN'S ARCHITECTURAL DESIGN
STANDARDS AND THE APPROVAL OF THE PLANNING COMMISSION.
CHANGES SHALL NOT BE MADE TO THE APPROVED ELEVATIONS
UNLESS APPROVED BY EITHER THE BNS DEPARTMENT OR THE
PLANNING COMMISSION.

HVAC UNITS ARE LOCATED ON THE ROOFS OF THE BUILDING AND ARE SCREENED FROM PUBLIC VIEW BY PARAPET WALLS.
CAVITY WALL CONSTRUCTION SHALL BE USED WHEREVER INTEGRALLY COLORED, UNPAINTED, SPLIT FACE CONCRETE BLOCK IS USED TO PREVENT WATER PENETRATION.

EXTERIOR FINISH LEGEND

BRICK
STYLE/SIZE: UTILITY
COLOR: RED/BROWN
MANUFACTURER: TBD
MORTAR: TBD
MORTAR MANUF.: TBD

MORTAR MANUF.: ALTERNATE:

MORTAR MANUF.:

MANUFACTURER:

MONUMENTAL CAST STONE
STYLE/SIZE: TRENDSTONE PLUS MONUMENTAL SERIES
COLOR: MW WHITE
MANUFACTURER: TRENWYTH
MORTAR: TBD

BRICK OF SIMILAR COLOR

CAST STONE LINTEL & ACCENT BAND
STYLE/SIZE: SMOOTH
COLOR: BUFFSTONE, GP-A
MANUFACTURER: ROCK CAST
MORTAR: SAME AS ADJACENT MASONRY

CAST STONE BASE
STYLE/SIZE: SPLIST/STPS-304 (3.625"x23.625")
COLOR: SUNSET
MANUFACTURER: PRAIRIE STONE
MORTAR: TBD

TBD

STOREFRONT & CURTAIN WALL
STYLE/SIZE: ALUMINUM RECTANGULAR
COLOR: KYNAR CHARCOAL GRAY OR ANODIZED DARK
BRONZE

TUBELITE OR EQUAL

GLAZING
STYLE/SIZE: 1" INSULATED LOW-E
COLOR: SOLAR BLUE + SOLARBAN 70XL (3)
MANUFACTURER: PPG OR EQUAL

PREFINISHED METAL PARAPET COPING
COLOR: SIERRA TAN & SLATE GRAY
MANUFACTURER: BERRIDGE OR EQUAL

METAL PANEL CANOPY
STYLE/SIZE: SMOOTH METAL PANEL, 18"
COLOR: PEWTER/TITANIUM
MANUFACTURER: CENTRIA/ALUCOBOND OR EQUAL

METAL PANEL/SCREEN ACCENT
STYLE/SIZE: PROFILE SERIES, CS-660
COLOR: ORANGE VERMILLION
MANUFACTURER: CENTRIA

<u>T</u> DR: Ti

MATERIAL AREA NOTES

MINOR MATERIALS INCLUDING COPINGS, FLASHINGS, AND TRIM INSTALLED OVER BRICK ARE NOT INCLUDED IN MATERIAL AREA CALCULATIONS.
 NET WALL AREA EXCLUDES STOREFRONT, DOORS, LOUVERS AND MINOR TRIM.

MATERIAL CALCULATIONS

EAST ELEVATION

 AREA
 % OF NET

 GROSS WALL AREA
 3631 S.F.
 NA%

 NET WALL AREA
 2208 S.F.
 100%

 BRICK AREA
 1193 S.F.
 54%

 CAST STONE AREA
 846 S.F.
 38%

 METAL PANEL/CANOPY
 169 S.F.
 8%

SOUTH ELEVATION

AREA % OF NET
GROSS WALL AREA 4954 S.F. NA%
NET WALL AREA 3091 S.F. 100%
BRICK AREA 1522 S.F. 49%
CAST STONE AREA 1253 S.F. 41%
METAL PANEL/CANOPY 316 S.F. 10%

CONCEPT DESIGN

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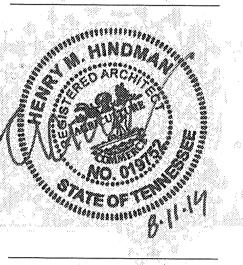
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OFFICE BUILDING FOR

Touchstone Medical Imaging

LYNWOOD WAY LOT 137 GATEWAY VILLIAGE SECTION 3 FRANKLIN, TENNESSEE



Revisions

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Drawing Elevations

A2



1 View from North



3 View from South



 $\begin{pmatrix} 2 \\ \Delta 3 \end{pmatrix}$

View from East



4 A3

View from West

CONCEPT DESIGN

FINAL DESIGN TO BE SUBMITTED FOR SITE PLAN APPROVAL


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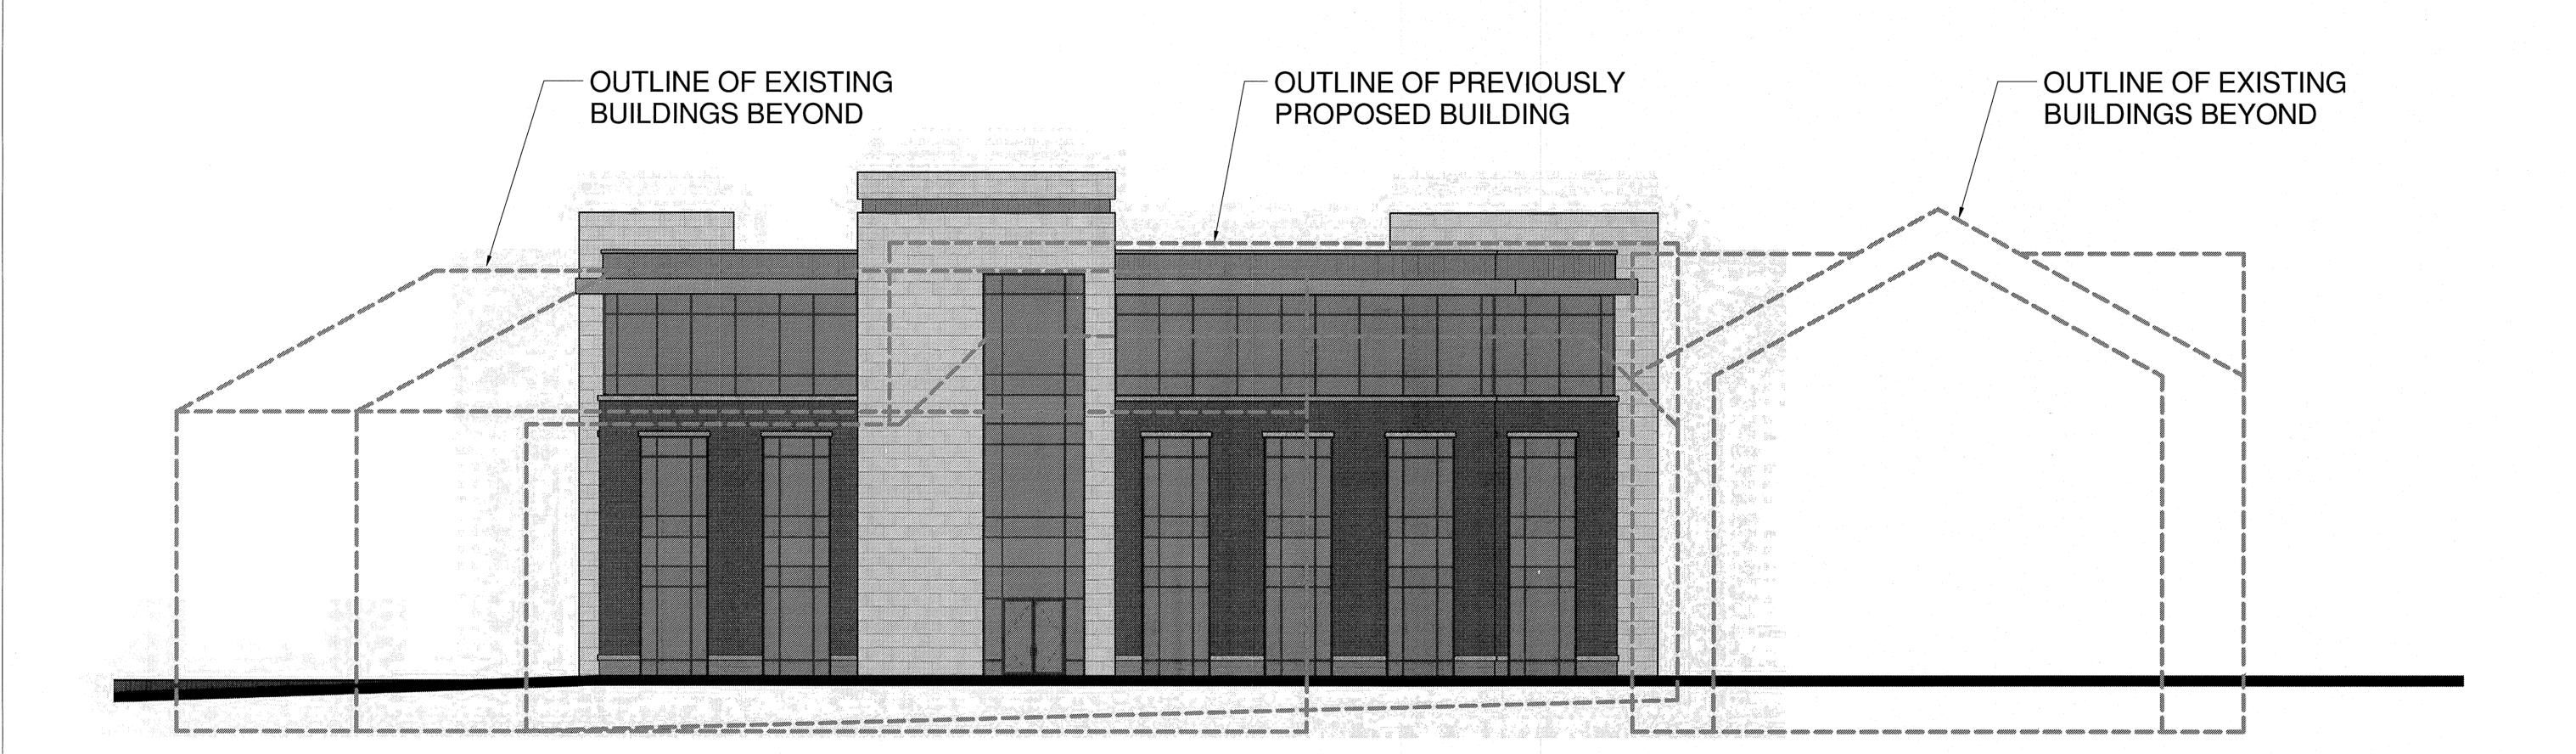
Revisions

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Date 08.11.14
Drawing

Perspectives



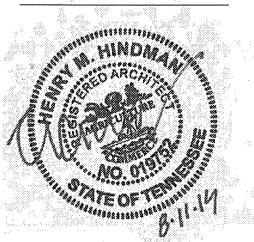

North Elevation Diagram

CONCEPT DESIGN

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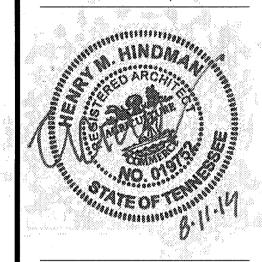


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Touchstone Medical Imaging

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Revisions

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> Drawn By TT

> Date 08.11.14

Elevation Diagram

A4